STREAM BELLINGHAM TOWNHOMES

LAND USE APPLICATION SET - APRIL 14, 2023



NUMBER; POUND(S)

DRAWING SYMBOL KEY

5	AT	GA	GAUGE, GAGE	PT	PRESSURE TREATED
D B	ANCHOR BOLT	GALV	GALVANIZED	PTD	PAINTED
3 3V	ABOVE	GC	GENERAL CONTRACTOR	PWR	POWER
2	AIR CONDITIONING	GEN	GENERAL	1 ****	TOWER
,)J	ADJUSTABLE	GL	GLASS	QTY	QUALITY
ICH	ANCHOR	GM	GAS METER	QUANT	QUANTITY
PR0X	APPROXIMATE (LY)	GR	GRADE	QUAIT	QUANTITI
CH	ARCHITECT (URAL)	GWB	GYPSUM WALL BOARD	R	RANGE
ITO	AUTOMATIC	GWD	GTFSUIVI WALL DUAND	n RD	ROOF DRAIN
V		НВ	HOSE BIB	REINF	REINFORCING
V	AWNING	HC	HOLLOW CORE	REQ'D	REQUIRED
	BOTTOM FLUSH	HDR	HEADER	REF	REFRIGERATOR
DG	BUILDING	HDW	HARDWARE	REV	REVISION
) 	BEAM	HORIZ	HORIZONTAL	RF	ROOF
ı T	BOTTOM	HR	HOUR (FIRE RESISTANT RATING)	RFG	ROOFING
G	BEARING	HT	HEIGHT	RM	ROOM
u WN		HVAC			ROUGH OPENING
VVIN	BETWEEN	пуас	HEATING, VENTILATION & AC	R0	NOUGH OF EINING
	CASEMENT	IG	INSULATED GLASS	S	SINK
	CATCH BASIN	IN	INCH	SAF	SELF-ADHERED FLASHING
M	CUBIC FEET PER MINUTE	INCL	INCLUDING	SC	SOLID CORE
	CEILING JOIST	INFO	INFORMATION	SCH	SCHEDULE
G	CEILING	INSUL	INSULATING, INSULATION	SCHED	SCHEDULE
R	CLEAR	INT	INTERIOR	SECT	SECTION
ITR	CENTER	ISG	INSULATED SAFETY GLASS	SF	SQUARE FOOT
)L	COLUMN			SG	SAFETY GLAZING
NC	CONCRETE	JT	JOINT	SH	SINGLE HUNG
NST	CONSTRUCTION			SIM	SIMILAR
NT	CONTINUOUS	KD	KILN DRIED	SI	SLIDING WINDOW OR DOOR
NTR	CONTRACTOR	KP	KING POST	SPEC	SPECIFICATION
ORD	COORDINATE			SPF	SPRUCE, PINE, FIR
		LAM	LAMINATE(D)	SQ	SQUARE
	DRYER	LAV	LAVATORY	SQ FT	SQUARE FOOT
3	DROP BEAM	LB	LAG BOLT	SS	STAINLESS STEEL
M0	DEMOLITION	LL	LIVE LOAD	S&R	SHELF AND ROD
IW	DOMESTIC HOT WATER HEATER	LT	LIGHT	STD	STANDARD
4	DIAMETER	LTG	LIGHTING	STL	STEEL
M	DIMENSION	LVR	LOUVER	STRUCT	STRUCTURAL
*1	DEAD LOAD	LT WT	LIGHT WEIGHT	SYM	SYMMETRICAL
	DOWN	LVL	LAMINATED VENEER LUMBER	OTIVI	OTIVITY IT IT IT IT
Y	DRYER	LVL	E/WINATTED VENEEN EOWIDEN	TF	TOP FLUSH
	DOWNSPOUT	MAX	MAXIMUM	T&G	TONGUE AND GROOVE
I	DISHWASHER	MECH	MECHANICAL	TEMP	TEMPORARY, TEMPERATURE
v VG	DRAWING	MED	MEDIUM	THK	THICK
	DIAWING	MFR	MANUFACTURER	TOC	TOP OF CONCRETE
I	EACH WAY	MIN	MINIMUM	TOG	TOGETHER
	EXISTING	MISC	MISCELLANEOUS	TOW	TOP OF WALL
	EACH	MTL	METAL	TYP	TYPICAL
				111	TITIOAL
-0	EGRESS	MW	MICROWAVE	LINIO	LINI ECC MOTED OTHERWISE
EC	ELECTRICAL	NICO	NECECCADY	UNO	UNLESS NOTED OTHERWISE
1	ELECTRIC METER	NEC	NECESSARY	UON	UNLESS OTHERWISE NOTED
LIID	EQUAL	NIC	NOT IN CONTRACT	1/45	VADIEC
UIP	EQUIPMENT	NTS	NOT TO SCALE	VAR	VARIES
4	EXHAUST	~ .	0.455	VENT	VENTILATION
ST	EXISTING	0/	OVER	VERT	VERTICAL
	EXPANSION	OD	OUTSIDE DIAMETER	VG	VERTICAL GRAIN
Γ	EXTERIOR	00	ON CENTER	VIF	VERIFY IN FIELD
		OH	OVERHEAD		
	FLOOR DRAIN	OPP	OPPOSITE	W	WASHER
N	FOUNDATION	OV	OVEN	W/	WITH
	FINISH			W/0	WITHOUT
	FLOOR JOIST	PC	PIPE COLUMN	WASH	CLOTHES WASHER
	FL00R	PLAM	PLASTIC LAMINATE	WD	WARMING DRAWER
	FACE OF	PLYWD	PLYW00D	WM	WATER METER
RR	FURRING	PSF	POUNDS PER SQUARE FOOT	WS	WIRE SHELVING
•	F00T	PSI	POUNDS PER SQUARE INCH	WWM	WELDED WIRE MESH
G	FOOTING	PSL	PARALLEL STRAND LUMBER		

FURNACE

	NORTH ARROW		WING TITLE_ g scale
			VIEW TITLE
X SIM	BUILDING ELEVATION DRAWING NUMBER SHEET NUMBER	+ 144.25' + 146.67 (E)	SITE POINT ELEVATION
X SIM	INTERIOR EL EVATION	FLOOR LEVEL ELEV: 121'-6"	<u>FLOOR ELEVATION</u> DATUM
(XX.XX)	INTERIOR ELEVATION DRAWING NUMBER SHEET NUMBER	+ 8' - 0" AFF	SPOT ELEVATION DATUM
XXXXX	BUILDING SECTION DRAWNING ALLIMATER	1	REVISION TAG
(M.M)	Drawing number Sheet number		WALL/FLOOR/ROOF ASSEMBLY TYPE TAG
X SIM	WALL SECTION DRAWING NUMBER SHEET NUMBER	нв †	HOSE BIBB
1 SIM	SHEET NUIVIDEN	50 CFM	EXHAUST FAN AIR FLOW RATE
A101	DETAIL REFERENCE DRAWING NUMBER SHEET NUMBER	RAMP UP	RAMP UP/DOWN PERCENT SLOPE
SIM	OTDUOTUDAL DETAIL	2%	DECK SLOPE TO DRAIN
XXXXX	Structural Detail Drawing Number Sheet Number	9" / 12"	CEILING/ROOF SLOPE RISE / RUN
		(SD)	SMOKE DETECTOR
XXXXX SIM	ARCHITECTURAL DETAIL DRAWING NUMBER SHEET NUMBER	CD	CARBON MONOXIDE ALARM
	CUT MARK	(CD) (SD)	COMBO SMOKE/CARBON MONOXIDE DETECTOR
Q	CENTERLINE		CLOTHES ROD AND SHELF
	GRID LINE	12	ROOF PITCH


PROJECT INFORMATION

CITY OF BELLINGHAM PROJEC	T NO: 2021-0105
PROJECT ADDRESS:	3509 MERIDIAN STREET, BELLINGHAM, WA 98225
PROJECT DESCRIPTION:	CONSTRUCTION OF 67 NEW TOWNHOUSES, DISTRIBUTED AMONG 18 BUILDINGS, EACH BUILDING UNDER SEPARATE PERMIT
SITE AREA:	179,793 SF
ASSESSOR PARCEL NO:	380213 546133 000
LEGAL DESCRIPTION:	PER CHICAGO TITLE COMPANY ORDER NO. 245444100 UPDATE #3 COMMITMENT DATE: SEPTEMBER 27, 2022. LOT 2, AS DELINEATED ON BG & CC SHORT PLAT, ACCORDING TO THE PLAT THEREOF, RECORDED UNDER AUDITOR'S FILE NO. 2022-0800206, RECORDS OF WHATCOM COUNTY, WASHINGTON. SITUATE IN WHATCOM COUNTY, WASHINGTON.
NEIGHBORHOOD:	BIRCHWOOD
ZONING:	RESIDENTIAL MULTI - PLANNED
APPLICABLE CODE:	INTERNATIONAL BUILDING CODE (IBC) 2018 INTERNATIONAL RESIDENTIAL CODE (IRC) 2018 WASHINGTON STATE ENERGY CODE - RESIDENTIAL PROVISIONS (WSEC-R) - 2018 BELLINGHAM MUNICIPAL CODE (BMC) INFILL TOOLKIT TOWNHOUSE REGULATIONS (BMC 20.28)
CONSTRUCTION TYPE:	TYPE V-B
OCCUPANCY:	RESIDENTIAL
AUTOMATIC FIRE SPRINKLER:	NFPA 13D @ TOWNHOME BUILDINGS
ENVIRONMENTALLY CRITICAL	AREAS: NONE

CONTRACT DIMENSION NOTES

- 1. DO NOT SCALE THE DRAWINGS. LARGE SCALE DIMENSIONS GOVERN SMALL SCALE DIMENSIONS.
- 2. GENERAL CONTRACTOR SHALL NOTIFY ARCHITECT OF ANY DISCREPANCY IN DIMENSIONS, PRIOR TO PROCEEDING WITH
- 3. AT NEW CONSTRUCTION, ALL DIMENSIONS ARE TO FACE OF FRAMING, FACE OF CONCRETE, CENTER LINE OF COLUMNS, AND CENTERLINE OF WINDOWS AND DOORS, UNLESS NOTED OTHERWISE. 4. SITE PLAN DIMENSIONS UNACCOMPANIED BY A LICENSED SURVEY IN THE POSTED DRAWING SET ARE CONSIDERED
- APPROXIMATE AND FOR REFERENCE ONLY.
- 5. GRAPHIC SCALES ARE PROVIDED FOR REFERENCE ONLY. WHERE DRAWINGS OF DIFFERENT SCALES ARE PROVIDED ON THE SAME SHEET, GRAPHIC SCALES ARE REMOVED FOR CLARITY.
- 6. DIMENSIONS WITH ACCOMPANYING TEXT (E.G. CLEAR, HOLD, EQUAL) SHALL BE VERIFIED IN FIELD. ANY CHANGES TO THESE DIMENSIONS REQUIRE APPROVAL BY ARCHITECT.

VICINITY MAP

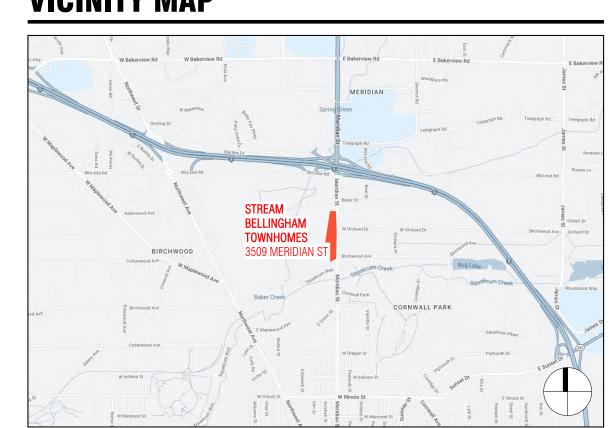

PROJECT TEAM

NGHAM PROJEC	CT NO: 2021-0105	OWNER:	STREAM REAL ESTATE DEVELOPMENT CONTACT: MARC ANGELILO	LANDSCAPE Architect:	KIM ROOI	NEY LANDSCAPE ARCHITECTUR CONTACT: KIM ROONE
RESS:	3509 MERIDIAN STREET, BELLINGHAM, WA 98225		999 N NORTHLAKE WAY, SUITE 200 SEATTLE. WA 98103	ANUTITEUT.		2307 W VIEWMONT WA SEATTLE WA 9819
CRIPTION:	CONSTRUCTION OF 67 NEW TOWNHOUSES, DISTRIBUTED AMONG 18 BUILDINGS, EACH BUILDING UNDER SEPARATE PERMIT		t: 206.463.5080 marc@streamre.com			t: 206.920.132 kim@kimrooneyinc.co
	179,793 SF	ARCHITECT: B	OARD & VELLUM ARCHITECTURE AND DESIGN CONTACT: JILL BURDEEN	STRUCTURAL E	NGINEER:	MALSAM-TSAN CONTACT: MARC MALSA
RCEL NO:	380213 546133 000		115 15TH AVE E. SUITE 100			122 S JACKSON ST, SUITE 21
PTION:	PER CHICAGO TITLE COMPANY ORDER NO. 245444100 UPDATE #3 COMMITMENT DATE: SEPTEMBER 27, 2022. LOT 2, AS DELINEATED ON BG & CC SHORT PLAT, ACCORDING TO THE PLAT THEREOF, RECORDED UNDER AUDITOR'S FILE NO. 2022-0800206, RECORDS OF WHATCOM COUNTY, WASHINGTON. SITUATE IN WHATCOM COUNTY, WASHINGTON.		SEATTLE, WA 98112 t: 206.707.8895 jill@boardandvellum.com www.boardandvellum.com	PERMIT CONSL	II TANT-	SEATTLE, WA 9810 t: 206.789.603 marcm@malsam-tsang.co AVT CONSULTIN
D:	BIRCHWOOD	SURVEY: LAN	D DEVELOPMENT ENGINEERING & SURVEYING CONTACT: RAYMOND PETERSON	I LIMIT CONSC	LIANI.	CONTACT : ALI TAY 1708 F STREE
	RESIDENTIAL MULTI - PLANNED		5160 INDUSTRIAL PL, P.I.P. BLDG. #108, FERNDALE, WA 98248			BELLINGHAM, WA 9822 t: 360.527.977
ODE:	INTERNATIONAL BUILDING CODE (IBC) 2018 INTERNATIONAL RESIDENTIAL CODE (IRC) 2018		t: 360.736.8098 ray@ldesinc.com			ali@avtplanning.co
	WASHINGTON STATE ENERGY CODE - RESIDENTIAL PROVISIONS (WSEC-R) - 2018 BELLINGHAM MUNICIPAL CODE (BMC) INFILL TOOLKIT TOWNHOUSE REGULATIONS (BMC 20.28)	CIVIL ENGINEE	CONTACT: JP SLAGLE 220 WEST CHAMPION STREET, SUITE 200			
N TYPE:	TYPE V-B		BELLINGHAM, WA 98225 t: 360.650.1408			
	RESIDENTIAL		jpslagle@freelandengineering.com			
re sprinkler:	NFPA 13D @ TOWNHOME BUILDINGS					

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A2 10	RUII DING ELEVATIONS 2 DACK TH "C C" UNITS

BUILDING ELEVATIONS - 2-PACK TH "C-C" UNITS BUILDING ELEVATIONS - 2-PACK TH "A-B" UNITS BUILDING ELEVATIONS - 4-PACK TH "A-B-A-B" UNITS BUILDING ELEVATIONS - 5-PACK TH "A-B-A-B-A" UNITS BUILDING SECTIONS - 2-PACK TH "C-C" UNITS

BUILDING SECTIONS - 2-PACK TH "A-B" UNITS BUILDING SECTIONS - 4-PACK TH "A-B-A-B" UNITS

UNIT PLANS -TYPE A.1 & A.2 (A.1M OPP) UNIT PLANS -TYPE B.1 & B.2 (B.1M OPP)

A5.13 UNIT PLANS - TYPE C.1 (C.1M OPP)

BUILDING SECTIONS - 5-PACK TH "A-B-A-B-A" UNITS

ISSUANCES

REVISION DATE

DESCRIPTION

DATE DESCRIPTION 7/29/2022 LAND USE APPLICATION

1/13/2023 LAND USE APP RESUBMITTAL 4/14/2023 LAND USE APP RESUBMITTAL

CITY OF BELLINGHAM STAMP AREA

SITE

BELLINGHAM

COPYRIGHT BOARD AND VELLUM LLC. ALL RIGHTS RESERVED. ORIGINAL SHEET SIZE IS 22"x34"

BOARD & VELLUM PROJECT #: 2021170.00

04.12.2023

COB PROJECT #: 2021-0105

PROJECT INFORMATION

PLOT DATE:


DEPARTURE REQUEST MATRIX

BMC CODE CITATION	CODE REQUIREMENT	PROPOSED DEPARTURE	DESIGN RATIONALE
DEPARTURE REQUEST #1 20.28.140.C.3: BULK AND MASSING	THE HEIGHT LIMIT IS 35' UNDER BMC 20.08.020, DEFINITION NO. 1.	DEPARTURE REQUEST: • 6 1/2" TO 2'-4 1/2" ABOVE 35' HEIGHT LIMIT *THIS ASSUMES MIDDLE OF THE RIDGE AS THE 35' LIMIT SEE SHEET G1.02 FOR DIAGRAM	THIS SITE IS ZONED RESIDENTIAL MULTI-PLANNED AND HAS NO HEIGHT LIMIT. THE TOWNHOUSE FINISH FLOOR HEIGHT TO ROOF RIDGELINE IS CONSISTENTLY 38'. THE EXISTING GRADES OF THE EXISTING TREE-FILLED AREA SLOPES BELOW MERIDIAN AND BIRCHWOOD. SOME OF THE BUILDINGS ARE SITUATED HIGHER THAN EXISTING GRADE IN AN EFFORT TO CREATE FUNCTIONAL AND ACCESSIBLE BUILDINGS AND TO PROVIDE A CONSISTENT MASSING ACROSS THE SITE.
			THE TWO BUILDINGS EXCEEDING 35' PER DEFINITION NO 1 CALCULATION ARE: BLDG 5.2 @ 35'-6 1/2" AND BLDG 5.3 @ 37'-4 1/2".
DEPARTURE REQUEST #2 20.28.050.A PEDESTRIAN-ORIENTED DESIGN	FRONTING INFILL HOUSING UNITS ON EXISTING IMPROVED STREETS SHALL BE PRIORITIZED OVER FRONTING UNITS INTERNALLY OFF A NEW STREET.	DEPARTURE REQUEST: • ALLOW UNIT B.2 IN BUILDING 2.5 TO FRONT COMMON AMENITY SEE SHEET A1.11 FOR LOCATION	THE MAJORITY OF THE UNITS ALONG MERIDIAN PROVIDE UNIT ENTRIES THAT FRONT MERIDIA UNIT B.2, IN BUILDING 2.5, IS THE ONLY UNIT ALONG MERIDIAN THAT HAS THE UNIT ENTRY ROTATED TO FACE NORTH, INSTEAD OF EAST. ROTATING THIS UNIT ENTRY ALLOWS THE UNIT TO FOLLOW A SIMILAR CONTEXTUAL PATTERN OF FRONTING THE GREEN SPACE, INSTEAD OF THE MAJOR ARTERIAL.
			THE SITING OF THIS BUILDING ALLOWS THE CENTRAL TRASH ENCLOSURE TO BE DISCRETELY TUCKED AMONG OTHER GARAGES, RATHER THAN FLANKING THE COMMON GREEN SPACE.
			UNIT A.1 HAS TWO ENTRIES, ONE FRONTING MERIDIAN AND ONE FRONTING THE GREEN SPAC
DEPARTURE REQUEST #3 20.28.140.B.2: SITE REQUIREMENTS AND SETBACKS	BUILDINGS SHALL BE PLACED: WITHIN 20' MAXIMUM FROM PROPERTY LINE AT FRONT AND SIDE FLANKING STREETS. 10' CLEAR FROM PROPERTY LINE AT REAR YARD WHEN NO ALLEY IS PRESENT (OPPOSITE 'FRONT STREET).	DEPARTURE REQUESTS: • ALLOW SETBACKS RANGE FROM 48'-4" (BUILDING 4.7) TO 80'-2" (BUILDING 4.6) FROM PROPERTY LINE. • ALLOW BLDG 2.3 TO OVERLAP THE 10' SETBACK AT REAR YARD.	BUILDINGS 4.6 & 4.7 FRONT ALONG MERIDIAN, HOWEVER, THE OPEN SPACE WAS STRATEGICALLY LOCATED IN AN EFFORT TO CREATE A SUBTLE BUFFER BETWEEN THE ARTERIAL AND THE UNITS ON THE EAST, SINCE THE UNITS ON THE WESTERN EDGE ALL FRON THE GOLF COURSE.
	IS PRESEIVE (UPPUSITE PROINT STREET).	SEE SHEET G1.04 FOR DIAGRAM	LOCATING THE GREEN SPACE ON THE EASTERN EDGE MORE EVENLY DISTRIBUTES THE GREEN SPACE THROUGHOUT THE PROJECT.
			CITY HAS NOTED THAT MERIDIAN ST IS CONSIDERED THE FRONT YARD AND THEREFORE REQUIRES A 10' REAR YARD SETBACK OPPOSITE THE FRONT YARD.
			BLDG 2.3 EXTENDS PAST THE 10' SETBACK OPPOSITE MERIDIAN (50 SF AREA) AND ASSUMINITHE 'JOG' IN REAR PROPERTY LINE WILL ALSO BE CONSIDERED A 10' SETBACK, BLDG 2.3 EXTENDS OVER THIS SETBACK PARTIALLY FROM 1'-11" TO 4'-11".
DEPARTURE REQUEST #4 20.28.050.G PRIVATE LANES, COMMON PEDESTRIAN CORRIDORS, AND ALLEYS	 PEDESTRIAN PATHS SHALL BE SEPARATED BY A MINIMUM OF 2' FROM PROPERTY LINES, FENCES, WALLS AND HEDGES. TOWNHOUSES ARE REQUIRED TO BE SETBACK A MINIMUM OF 10' FROM THE COMMON PEDESTRIAN CORRIDORS (COMMON PEDESTRIAN CORRIDORS SHALL BE CONSIDERED STREETS FOR SETBACK PURPOSES). COMMON PEDESTRIAN CORRIDOR MINIMUM TOTAL WIDTH REQUIRED TO BE 10'. 	DEPARTURE REQUESTS: ALLOW PEDESTRIAN PATHS TO BE SITED AT PROPERTY LINE IN FRONT OF BLDGS 2.3, 2.4, 5.2 AND 5.3. AND ADJACENT TO FENCES ALONG ENTIRE WEST EDGE OF THE BUILT SITE. A MINOR MODIFICATION FROM BMC 20.28.050.G IS REQUESTED AS TOWNHOUSES ARE REQUIRED TO BE SETBACK A MINIMUM OF 10' FROM THE COMMON PEDESTRIAN CORRIDORS. MINOR MODIFICATION FROM BMC 20.28.050.G.3 AS TABLE 20.28.050 REQUIRES A TOTAL WIDTH OF 10' TO BE PROVIDED FOR COMMON PEDESTRIAN CORRIDORS.	LOCATING THE PEDESTRIAN PATH ALONG THE FENCE AND PROPERTY LINE AT THE WEST EDGINSTEAD OF PROVIDING THE REQUIRED 2 FEET SEPARATION MAXIMIZES THE OPEN SPACE ARIBETWEEN THE PROPERTY AND THE GOLF FAIRWAY ON THE ADJACENT BELLINGHAM GOLF CLIPROPERTY AND ALLOWS FOR PRIVATE YARD SPACE AT UNITS FACING THE WEST EDGE.
		SEE SHEETS G1.04 AND A1.11	
DEPARTURE REQUEST #5 20.28.050.1.4 LANDSCAPING AND FENCING	ALL FENCES IN THE FRONT AND SIDE STREET SETBACKS ARE LIMITED TO 42" IN HEIGHT.	DEPARTURE REQUEST: • ALLOW FENCE SEPARATING THE THE TOWNHOUSE PROJECT FROM THE BELLINGHAM COUNTRY CLUB PROPERTY TO BE 60" IN HEIGHT	A 60" HIGH FENCE IS THE PREFERNCE OF THE SITE'S NEIGHBORS, THE BELLINGHAM COUNTR' CLUB AND COMPLIANT WITH A REAR YARD SETBACK (PER COB; SEE DEPATURE REQUEST #3
		SEE SHEET A1.11 FOR LOCATION	

BELLINGHAM CODE REVIEW

BELLINGHA	AM CODE REVIEW		
ZONE	RESIDENTIAL MULTI - PLANNED	20.28.140.D USABLE SPACE,	 EACH DWELLING UNIT SHALL HAVE: 200 SF OF PRIVATE USABLE SPACE WITH NO DIMENSION LESS THAN 5'.
LOT AREA	179,793 SF	OPEN SPACE AND LANDSCAPING	UP TO 100 SF OF DECK, PATIO OR STRUCTURE MAY BE INCLUDED TOWARDS 200 SF REQUIREMENT.
20.28.050.A PEDESTRIAN- ORIENTED DESIGN	FRONTING INFILL HOUSING UNITS ON EXISTING IMPROVED STREETS SHALL BE PRIORITIZED OVER FRONTING UNITS INTERNALLY OFF A NEW STREET. GAPS MAY OCCUR AS NECESSARY FOR BUILDING SETBACKS, VEHICULAR AND PEDESTRIAN ACCESS, AND FEATURES THAT CONTRIBUTE TO THE PEDESTRIAN REALM.		 PRIVATE USABLE SPACE MAY BE CONSOLIDATED AND PROVIDED AS COMMON USABLE SPACE WITH MINIMUM DIMENSIONS OF 10' BY 10'. ALL UNITS SHALL HAVE DIRECT ACCESS TO USABLE SPACE.
	PARKING SHALL NOT BE LOCATED BETWEEN DWELLING UNITS AND THE STREET OR LANE. DEPARTURE REQUESTED - SEE DEPATURE REQUEST #2 ON DEPATRURE REQUEST MATRIX		REQUIRED PRIVATE USABLE SPACE: 67 UNITS X 200 SF = 13,400 SF PROPOSED PRIVATE USABLE SPACE:
20.28.050.C LOT REQUIREMENTS	THERE ARE NO MINIMUM LOT DIMENSIONS, LOT SIZES OR MINIMUM STREET FRONTAGE REQUIREMENTS. ALL INFILL HOUSING DEVELOPMENT SHALL PROVIDE ACCESS TO A PUBLIC RIGHT-OF-WAY.		PRIVATE USABLE SPACE = VARIES (SEE SHEET G1.03 FOR DIAGRAM) COMMON USABLE SPACE = 3,862 SF SEE SHEET G1.04 FOR PRIVATE USABLE SPACE CALCULATIONS.
20.28.050.D SUBDIVISION	SITES WITH DUPLEX AND TOWNHOUSE TYPES MAY BE SUBDIVIDED INTO LOTS THAT DO NOT COMPLY WITH DEVELOPMENT STANDARDS IN THIS TITLE OR BMC TITLE 23 INDIVIDUALLY, AS LONG AS THE PARENT SITE AS A WHOLE COMPLIES WITH THIS CHAPTER.		OR PERMEABLE MATERIALS. REQUIRED SITE OPEN SPACE: 179,793 X .3 = 53,938 SF PROPOSED SITE OPEN SPACE: 67,396 SF
20.28.050.F ENCROACHMENTS AND COMMON WALL DEVELOPMENT	ENCROACHMENTS INTO REQUIRED YARDS ARE ALLOWED AS SPECIFIED IN BMC 20.10.080(B). FENCES AND WALLS UNCOVERED DECK OR BALCONY, EXCEEDING 30" ABOVE GRADE: FRONT YARD SETBACK = 6' PERMITTED ENCROACHMENT REAR YARD SETBACK = 5' PERMITTED ENCROACHMENT MECHANICAL EQUIPMENT, SUCH AS: AIR CONDITION UNIT, HEAT PUMP UNIT		SEE SHEET G1.04 FOR OPEN SPACE CALCULATIONS • A GREEN FACTOR LANDSCAPING SCORE OF 0.4 IS REQUIRED PROPOSED: 0.5324 SEE SHEET L-11 FOR GREEN FACTOR CALCULATIONS
	REAR YARD SETBACK = 4' PERMITTED ENCROACHMENT • COVERED PORCH, SINGLE STORY MAIN ENTRY OPEN ON 3 SIDES (UNCOVERED STEPS LEADING INTO A PORCH OR DECK WHICH ARE NOT EXCEEDING 4' ABOVE GRADE ARE NOT COUNTED TOWARDS THE 6' FRONT YARD ENCROACHMENT) FRONT YARD SETBACK = 6' PERMITTED ENCROACHMENT	20.28.140.F Design Standards	 EACH TOWNHOUSE UNIT SHALL FRONT (AND HAVE AND ENTRANCE FACING) A STREET, LANE, OR COMMON PEDESTRIAN CORRIDOR. ENTRANCES FOR EACH UNIT SHALL BE SEPARATE. EACH UNIT SHALL HAVE DIRECT ACCESS TO BOTH THE PUBLIC STREET, LANE, OR COMMON
	FOR COMMON WALL DEVELOPMENT SUCH AS TOWNHOUSES AND ENCROACHMENTS OVER PROPERTY LINES SUCH AS EAVES, A JOINT AGREEMENT MUST BE APPROVED BY THE CITY OF BELLINGHAM AND RECORDED WITH THE WHATCOM COUNTY AUDITOR'S OFFICE AND THEREAFTER FILED WITH THE CITY.		PEDESTRIAN CORRIDOR AND PARKING. • EACH UNIT MUST HAVE A COVERED, MAIN ENTRY-RELATED PORCH OR STOOP AREA OF AT LEAST 40 SF WITH NO DIMENSION LESS THAN 5'. THIS IS IN ADDITION TO THE PRIVATE USABLE SPACE REQUIREMENT. SEE SHEET G1.04 FOR ENTRY PORCH AND PRIVATE USABLE SPACE CALCULATIONS
20.28.050.G PRIVATE LANES, COMMON PEDESTRIAN CORRIDORS, AND ALLEYS	LANES, COMMON PEDESTRIAN CORRIDORS, AND ALLEYS MUST BE CONSTRUCTED AND MAINTAINED TO THE FOLLOWING MINIMUM IMPROVEMENT STANDARDS: ALLEYS: TRAVEL LANE WIDTH = 15' PEDESTRIAN PATH WIDTH = N/A TOTAL WIDTH = 15'		 BUILDINGS MUST BE MODULATED ALONG THE PUBLIC STREET AT LEAST EVERY 30 FEET. STEP THE BUILDING WALL AT LEAST 4', OR AT LEAST 2' WHEN ARCHITECTURAL DETAILING IS USED TO CLEARLY DELINEATE THE INDIVIDUALITY OF EACH UNIT. SEE SHEET G1.04 FOR BUILDING MODULATION DIMENSIONS GARBAGE/RECYCLING AREAS SHALL BE CONSOLIDATED, UNLESS THE LOCAL REFUSE PROVIDER APPROVES OTHERWISE, AND SCREENED FROM PUBLIC VIEW.
	PROPOSED TOTAL WIDTH = 20'		SEE SHEET G1.04 FOR LOCATION OF CONSOLIDATED GARBAGE/RECYCLING AREAS
	 LANES, COMMON PEDESTRIAN CORRIDORS, AND ALLEYS MUST BE: SURFACED WITH A HARD MATERIAL SUCH AS CONCRETE OR ASPHALT, EXCEPT THAT ASPHALT SHALL NOT BE USED FOR COMMON PEDESTRIAN CORRIDORS. PERMEABLE PAVEMENT SHALL BE USED FOR HARD SURFACE GROUND COVER AREAS UNLESS INFEASIBLE 	20.32.040.B STANDARD DEVELOPMENT –	MAXIMUM DENSITY: (HIGH DENSITY CLASSIFICATION) NO EXPRESSED MAXIMUM DENSITY WITHIN A HIGH-DENSITY CLASSIFICATION
	PEDESTRIAN PATHS SHALL BE SEPARATED FROM PROPERTY LINES, FENCES, WALLS AND HEDGES BY A MINIMUM OF 2' PEDESTRIAN PATHS SHALL BE SEPARATED FROM PROPERTY LINES, FENCES, WALLS AND HEDGES BY A MINIMUM OF 2' PEDESTRIAN PATHS SHALL BE SEPARATED FROM PROPERTY LINES, FENCES, WALLS AND HEDGES BY A MINIMUM OF 2' PEDESTRIAN PATHS SHALL BE SEPARATED FROM PROPERTY LINES, FENCES, WALLS AND HEDGES BY A MINIMUM OF 2' PEDESTRIAN PATHS SHALL BE SEPARATED FROM PROPERTY LINES, FENCES, WALLS AND HEDGES BY A MINIMUM OF 2' PEDESTRIAN PATHS SHALL BE SEPARATED FROM PROPERTY LINES, FENCES, WALLS AND HEDGES BY A MINIMUM OF 2' PEDESTRIAN PATHS SHALL BE SEPARATED FROM PROPERTY LINES, FENCES, WALLS AND HEDGES BY A MINIMUM OF 2' PEDESTRIAN PATHS SHALL BE SEPARATED FROM PROPERTY LINES FROM PROPER	REGULATIONS - DENSITY	$\frac{\text{MINIMUM DENSITY: (HIGH DENSITY CLASSIFICATION)}}{3,599 \text{ SF OF GROSS LAND AREA/1 RESIDENTIAL UNIT}}{179,793 \text{ SF GROSS LAND AREA/3,559 SF} = 50 \text{ UNIT MINIMUM REQUIRED}}$
	DEPARTURE REQUESTED - SEE DEPATURE REQUEST #4 ON DEPATRURE REQUEST MATRIX		67 UNITS PROPOSED
20.28.050.H PARKING	NUMBER OF SPACES UNITS OF 1,000 SQUARE FEET OR GREATER SHALL PROVIDE TWO ON-SITE PARKING STALLS. PROPOSED DWELLING UNIT PARKING: 2 GARAGE STALLS (3BD UNITS > 1,000 SF) GUEST PARKING. WHEN A SITE CONTAINS 20 OR MORE UNITS AND LACKS ON-STREET PARKING ABUTTING OR PARKING WITHIN THE PARENT SITE, THE PLANNING DIRECTOR MAY REQUIRE ADDITIONAL GUEST PARKING. PROPOSED GUEST PARKING ON SITE: 21 SURFACE PARKING STALLS	20.32.040.G4. PEDESTRIAN CIRCULATION	SIDEWALK SHALL BE CONSTRUCTED WITHIN ALL ABUTTING ROW. (A LOCAL IMPROVEMENT DISTRICT COMMITMENT MAY BE REQUIRED IN LIEU OF CONSTRUCTION IF THE CITY DETERMINES IMMEDIATE CONSTRUCTION IS NOT WARRANTED.) WALKWAYS
	 PARKING STALL DIMENSIONS UNIT GARAGE PARKING STALLS SHALL BE AT LEAST 9' BY 18'. PARKING SETBACKS 		REQUIRED LINKING BUILDING ENTRANCES TO PARKING AREAS, SIDEWALKS AND OTHER BUILDING ENTRANCES. IF NO SIDEWALK IS CONSTRUCTED OR EXISTS, THE CONNECTING WALKWAY SHALL EXTEND TO THE PROPOSED LOCATION OF A SIDEWALK OR TO THE EDGE OF THE PAVEMENT.
	THE REQUIRED MINIMUM SETBACKS FOR OPEN PARKING ARE: • FRONT STREET: 25' • SIDE FLANKING STREET: 10' • SIDE AND REAR YARDS: 5'	20.32.070.B LANDSCAPING	STREET TREES • ONE STREET TREE SHALL BE PROVIDED FOR EVERY 50 FEET OF STREET FRONTAGE ABUTTING THE
20.28.050.I LANDSCAPING AND FENCING	 LANDSCAPING SHALL BE PROVIDED BETWEEN EACH HOUSING UNIT AND ABUTTING STREETS, LANES, ALLEYS, AND COMMON PEDESTRIAN CORRIDORS EXCEPT WHERE DRIVEWAY AND WALKWAY CROSSINGS OCCUR. ALONG STREETS, LANES AND ALLEYS, LANDSCAPING SHALL BE PROVIDED TO SEPARATE THE PARKING AND DRIVEWAYS BETWEEN INDIVIDUAL DWELLING UNITS. ALL FENCES IN THE FRONT AND SIDE STREET SETBACKS ARE LIMITED TO 42" IN HEIGHT AND MAY 	REQUIREMENTS (SEE SHEETS L-1 - L-11 FOR LANDSCAPE DESIGN)	PROPERTY. SAID TREES SHALL BE INSTALLED ADJACENT TO THE RIGHT-OF-WAY WITHIN THE PROPERTY LINES OR WITHIN THE RIGHT-OF-WAY SUBJECT TO THE APPROVAL OF THE PUBLIC WORKS AND PARKS DEPARTMENT. GARBAGE RECEPTACLE AREAS SHALL BE SCREENED ON AT LEAST TWO SIDES.
	BE NO MORE THAN 60% OPAQUE . CHAIN LINK OR CYCLONE FENCING IS NOT ALLOWED IN THE FRONT OR SIDE STREET SETBACK.		OPEN SPACE • A MINIMUM OF 25% OF THE REQUIRED OPEN SPACE SHALL BE LANDSCAPED. (LANDSCAPE-BASED LID BMPS SHALL COUNT TOWARD THIS REQUIREMENT.)
20.28.140.B Townhouse - Site Requirements and	TOWNHOUSES MAY BE LOCATED ON A SEPARATE (FEE SIMPLE) LOT OR SEVERAL UNITS MAY BE LOCATED ON A COMMON PARCEL.		<u>PARKING</u>
SETBACKS	THE REQUIRED SETBACKS ARE: GARAGES AND CARPORTS SHALL BE SET BACK AT LEAST 4' FROM THE STREET FACE OF RESIDENTIAL BUILDINGS (EXCLUDING FRONT PORCHES). BUILDINGS SHALL BE PLACED:		 FOR EVERY 10 OPEN PARKING SPACES, ONE TREE SHALL BE INSTALLED AROUND THE FACILITY PERIMETER. THESE TREES MAY BE GROUPED OR SPREAD LINEALLY. AREAS BETWEEN PARKING AND ADJACENT PROPERTY SHALL BE LANDSCAPED AND/OR SCREENED.
	 1. 10° CLEAR FROM PROPERTY LINE AT FRONT AND SIDE FLANKING STREETS. 2. WITHIN 20° MAXIMUM FROM PROPERTY LINE AT FRONT AND SIDE FLANKING STREETS. 3. 5° CLEAR FROM PROPERTY LINE AT ADJACENT PARCELS. 		 WHEN ADJACENT TO LANDSCAPING, A PORTION OF A STANDARD PARKING SPACE MAY BE LANDSCAPED INSTEAD OF PAVED, AS FOLLOWS: THE LANDSCAPED AREA MAY BE UP TO TWO FEET OF THE FRONT OF THE SPACE. ANY VEHICLE OVERHANG MUST BE FREE FROM INTERFERENCE FROM SIDEWALKS, LANDSCAPING, OR OTHER REQUIRED ELEMENTS.
	DEPARTURE REQUESTED - SEE DEPATURE REQUEST #3 ON DEPATRURE REQUEST MATRIX		b. LANDSCAPING WITHIN THE PARKING OVERHANG AREA MUST BE GROUND COVER PLANTS.
20.28.140.C BULK AND MASSING	MAXIMUM ATTACHED DWELLING UNITS IS 8. PROPOSED MAXIMUM ATTACHED DWELLING UNITS: 5. MAXIMUM ELOOP AREA RATIO (FAR.) IS 0.75.		 c. THE LANDSCAPED AREA COUNTS TOWARD PARKING LOT LANDSCAPING REQUIREMENTS AND TOWARD ANY OVERALL OPEN SPACE REQUIREMENTS. UNLESS INFEASIBLE, LANDSCAPE-BASED LID BMPS SHALL BE USED WITHIN PARKING LOT LANDSCAPING TO MEET DRAINAGE REQUIREMENTS.
	MAXIMUM FLOOR AREA RATIO (FAR) IS 0.75. PROPOSED FAR: 0.71 SEE SHEET G1.03 FOR FAR DIAGRAMS & CALCULATIONS ANAMAMAMAM FLOOR AREA RATIO (FAR) IS 0.75. ANAMAMAMAMAMAMAMAMAMAMAMAMAMAMAMAMAMAM		
	MAXIMUM HEIGHT LIMIT IS 35' (PER DEFINITION NO 1). PROPOSED MAXIMUM STRUCTURE HEIGHT: 39'-11" (VARIES PER BUILDING) SEE SHEET G1.02 FOR HEIGHT DIAGRAMS & CALCULATIONS		
	DEPARTURE REQUESTED - SEE DEPARTURE REQUEST #1 ON DEPARTURE REQUEST MATRIX		

TECTURE AND DES

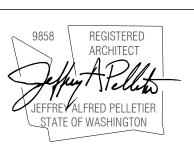



- SITE

STREAM BELLINGHAM

REVISION DATE

PROJEC: 3509 ME OWNER: STRFAM

DESCRIPTION

DATE DESCRIPTION

7/29/2022 LAND USE APPLICATION1/13/2023 LAND USE APP RESUBMITTAL4/14/2023 LAND USE APP RESUBMITTAL

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ORIGINAL SHEET SIZE IS 22"x34"

BOARD & VELLUM PROJECT #: 2021170.00 COB PROJECT #: 2021-0105

PLOT DATE:

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04.12.2023

CODE REVIEW - LAND USE
SHEET NO.:

G1.01





rd & Vellum
LECTURE AND DESIGN
Ave E. Suite 100 Seattle, WA 98112
loardandvellum.com | 206.707.8895

LEGEND

GENERAL NOTES

9858

REGISTERED
ARCHITECT

JEFFREY ALFRED PELLETIER
STATE OF WASHINGTON

Oa

Δ ₹

CITY OF BELLINGHAM STAMP AREA

IM - SITE

PROJECT ADDRESS: 3509 MERIDIAN STREET, BELLINGHAM, WA 98225 DWNER:

REVISION DATE DES

ISSUANCES

7/29/2022 LAND USE APPLICATION
1/13/2023 LAND USE APP RESUBMITTA
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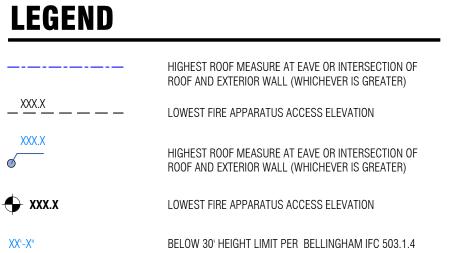
 OB PROJECT #:
 2021-0105

PLOT DATE: 4.12.2023

CODE DIAGRAMS BUILDING HEIGHT (ZONING)
SHEET NO.:

G1.02





GENERAL NOTES

LEVEL OF FIRE DEPARTMENT VEHICLE ACCESS.

1. THE PROPOSED BUILDINGS ARE WITHIN 30 FEET IN HEIGHT ABOVE THE LOWEST



Vellum

STATE OF WASHINGTON

CITY OF BELLINGHAM STAMP AREA

SITE

BELLINGHAM

REVISION DATE

ISSUANCES

DATE DESCRIPTION 7/29/2022 LAND USE APPLICATION


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PLOT DATE: 4.12.2023

CODE DIAGRAMS -**BUILDING HEIGHT (FIRE)** SHEET NO.:

BLDG 2.3 SETBACK (DEPATURE REQUEST #4)




MAIN ENTRY PORCHES & DECKS, TYPICAL UNO

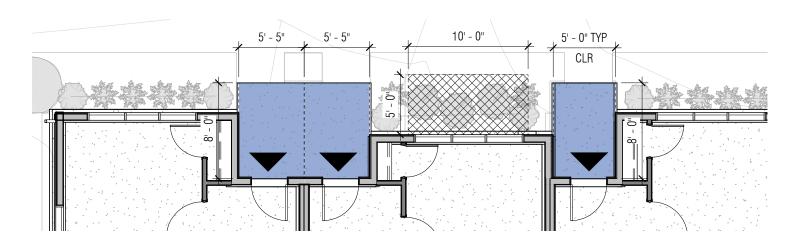COMMON & PRIVATE USABLE SPACE CALCULATIONS

EACH DWELLING UNIT SHALL HAVE **200 SF OF PRIVATE USABLE SPACE** WITH NO DIMENSION LESS THAN FIVE FEET. UP TO 100 SF OF DECK, PATIO OR STRUCTURE MAY BE INCLUDED. PRIVATE USABLE SPACE MAY BE CONSOLIDATED AND PROVIDED AS COMMON USABLE SPACE WITH MINIMUM DIMENSIONS OF 10 FEET BY 10 FEET. EACH UNIT MUST HAVE A COVERED, MAIN ENTRY-RELATED PORCH OR STOOP AREA OF AT LEAST **40 SF** WITH NO DIMENSION LESS THAN **5**'. THIS IS IN ADDITION TO THE PRIVATE USABLE SPACE REQUIREMENT.

BUILDING	PRIVATE USABLE SPACE	TOTAL	SHORTAGE	BUILDING	PRIVATE USABLE SPACE	TOTAL	SHORTAGE	BUILDING	PRIVATE USABLE SPACE	TOTAL	<u>SHORTAGE</u>
BUILDING 4.1 UNIT A.1 UNIT A.2M UNIT B.1M	200 SF YARD 200 SF YARD 228 SF YARD, 50 SF DECK	200 SF 200 SF 278 SF		BUILDING 5.1 UNIT A.1 UNIT A.2 UNIT A.1M	530 SF YARD 448 SF YARD 252 SF YARD	530 SF 448 SF 252 SF		BUILDING 2.1 UNIT C.1 UNIT C.1M	0 SF YARD, 268 SF DECK 0 SF YARD, 268 SF DECK	100 SF 100 SF	-100 SF -100 SF
UNIT B.2 BUILDING 4.2	228 SF YARD, 50 SF DECK	278 SF		UNIT B.1 UNIT B.1M	550 SF YARD, 50 SF DECK 170 SF YARD, 50 SF DECK	600 SF 220 SF		BUILDING 2.2 UNIT C.1 UNIT C.1M	478 SF YARD, 270 SF DECK 555 SF YARD, 270 SF DECK	578 SF 655 SF	
UNIT A.1 UNIT A.2M UNIT B.1M UNIT B.2	200 SF YARD 200 SF YARD 228 SF YARD, 50 SF DECK 228 SF YARD, 50 SF DECK	200 SF 200 SF 278 SF 278 SF		BUILDING 5.2 UNIT A.1 UNIT A.2 UNIT A.1M UNIT B.1	76 SF YARD 76 SF YARD 76 SF YARD 100 SF YARD, 50 SF DECK	76 SF 76 SF 76 SF 150 SF	-124 SF -124 SF -124 SF -50 SF -45 SF	BUILDING 2.3 UNIT C.1 UNIT C.1M	0 SF YARD, 268 SF DECK 183 SF YARD, 270 SF DECK	100 SF 283 SF	-100 SF
BUILDING 4.3 UNIT A.1 UNIT A.2M	150 SF YARD 155 SF YARD	150 SF 155 SF	-50 SF -45 SF	UNIT B.1M BUILDING 5.3	105 SF YARD, 50 SF DECK	155 SF		BUILDING 2.4 UNIT C.1 UNIT C.1M	410 SF YARD, 270 SF DECK 108 SF YARD, 270 SF DECK	510 SF 208 SF	
UNIT B.1M UNIT B.2 BUILDING 4.4 UNIT A.1	180 SF YARD, 50 SF DECK 184 SF YARD, 50 SF DECK 85 SF YARD	230 SF 234 SF 85 SF	-115 SF	UNIT A.1 UNIT A.2 UNIT A.1M UNIT B.1 UNIT B.1M	76 SF YARD 76 SF YARD 76 SF YARD 100 SF YARD, 50 SF DECK 105 SF YARD, 50 SF DECK	76 SF 76 SF 76 SF 150 SF 155 SF	-124 SF -124 SF -124 SF -50 SF -45 SF	BUILDING 2.5 UNIT A.1 UNIT B.2	200 SF YARD 229 SF YARD, 50 SF DECK	200 SF 279 SF	
UNIT A.2M UNIT B.1M UNIT B.2	108 SF YARD 123 SF YARD, 50 SF DECK 145 SF YARD, 50 SF DECK	108 SF 173 SF 195 SF	-92 SF -17 SF -5 SF	BUILDING 5.5 UNIT A.1 UNIT A.2	225 SF YARD 265 SF YARD	225 SF 265 SF			TE USABLE SPACE: F PER UNIT = 13,400 SF		
BUILDING 4.5 UNIT A.1 UNIT A.2M UNIT B.1M UNIT B.2	160 SF YARD 165 SF YARD 190 SF YARD, 50 SF DECK 194 SF YARD, 50 SF DECK	160 SF 165 SF 240 SF 244 SF	-40 SF -35 SF	UNIT A.1M UNIT B.1 UNIT B.1M BUILDING 5.6	285 SF YARD 265 SF YARD, 50 SF DECK 254 SF YARD, 50 SF DECK	285 SF 315 SF 304 SF		PRIVATE OPEN SF	ATE USABLE SPACE: PACE = VARIES (SEE OPEN SPACE	: DIAGRAM)	
BUILDING 4.6				UNIT A.1 UNIT A.2	218 SF YARD 212 SF YARD	218 SF 212 SF		FOR PRIVATE US	E SPACE REQUIRED ABLE SPACE SHORTAGE = 1,633		
UNIT A.1 UNIT A.2M UNIT B.1M	200 SF YARD 226 SF YARD 229 SF YARD, 50 SF DECK	200 SF 226 SF 279 SF		UNIT A.1M UNIT B.1 UNIT B.1M	219 SF YARD 218 SF YARD, 50 SF DECK 238 SF YARD, 50 SF DECK	219 SF 268 SF 358 SF			E SPACE PROVIDED = 3,862 SF		
UNIT B.2 BUILDING 4.7	226 SF YARD, 50 SF DECK	276 SF							ENTRY PORCH AREA: PER UNIT = 2,680 SF		
UNIT A.1 UNIT A.2M UNIT B.1M UNIT B.2	200 SF YARD 215 SF YARD 229 SF YARD, 50 SF DECK 240 SF YARD, 50 SF DECK	200 SF 215 SF 279 SF 290 SF							ENTRY PORCH AREA: PER UNIT = 2,680 SF		
BUILDING 4.8 UNIT A.1 UNIT A.2M UNIT B.1M UNIT B.2	212 SF YARD 213 SF YARD 234 SF YARD, 50 SF DECK 265 SF YARD, 50 SF DECK	212 SF 213 SF 284 SF 315 SF									

COMMON & PRIVATE USABLE SPACE KEY

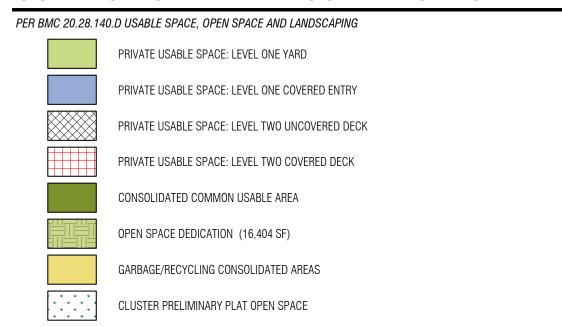

OPEN SPACE CALCULATION

A MINIMUM OF 30% OF THE SITE AREA SHALL BE OPEN SPACE; CONSISTING OF LANDSCAPING OR PERMEABLE MATERIALS

SITE AREA: 179,793 SF

REQUIRED SITE OPEN SPACE:
179,793 X .3 = 53,938 SF REQUIRED

PROPOSED SITE OPEN SPACE:
179,793 SF SITE AREA
- 58,440 SF BUILDING FOOTPRINTS
- 33,896 SF DRIVE AISLE
- 12,708 SF SIDEWALKS
- 7,353 SF DRIVEWAYS

CLUSTER PRELIMINARY PLAT OPEN SPACE CALCULATION

PER BMC 23.08.060 A MINIMUM OF 15 PERCENT OF THE SITE SHALL BE RESERVED FOR OPEN SPACE THAT (A) PRESERVES SIGNIFICANT NATURAL FEATURES INCLUDING, BUT NOT LIMITED TO, CRITICAL AREAS AND ASSOCIATED BUFFERS OR MATURE STANDS OF TREES, AND/OR (B) CREATES RECREATIONAL OPEN SPACE WITH AMENITIES.

SITE AREA: 179,793 SF X .15 = **26,969 SF REQUIRED**

+16,404 SF (OPEN SPACE DEDICATION) +10,298 SF (SEE OPEN AREA DIAGRAM) + 1,340 SF (SEE OPEN AREA DIAGRAM) 28,042 SF PROPOSED

PROPOSED GUEST PARKING STALLS

67,396 SF PROPOSED

PARKING CALCULATION

PER BMC 20.28.050.H PARKING

REQUIRED UNIT PARKING STALLS (2 PER TOWNHOUSE) = 134 (67 UNITS X 2 STALLS/UNIT)

PROPOSED UNIT PARKING STALLS (IN TOWNHOUSE GARAGE) = 134


REQUIRED GUEST PARKING STALLS = N/A

BUILDING MODULATION

BUILDINGS MUST BE MODULATED ALONG THE PUBLIC STREET AT LEAST EVERY 30'. BUILDING MODULATIONS MUST STEP THE BUILDING WALL BACK OR FORWARD AT LEAST 4' OR AT LEAST 2' WHEN ARCHITECTURAL DETAILING IS USED TO CLEARLY DELINEATE THE INDIVIDUALITY OF EACH UNIT.

= 21

SEE G1.04 OPEN AREAS & PARKING DIAGRAM FOR DIMENSIONS

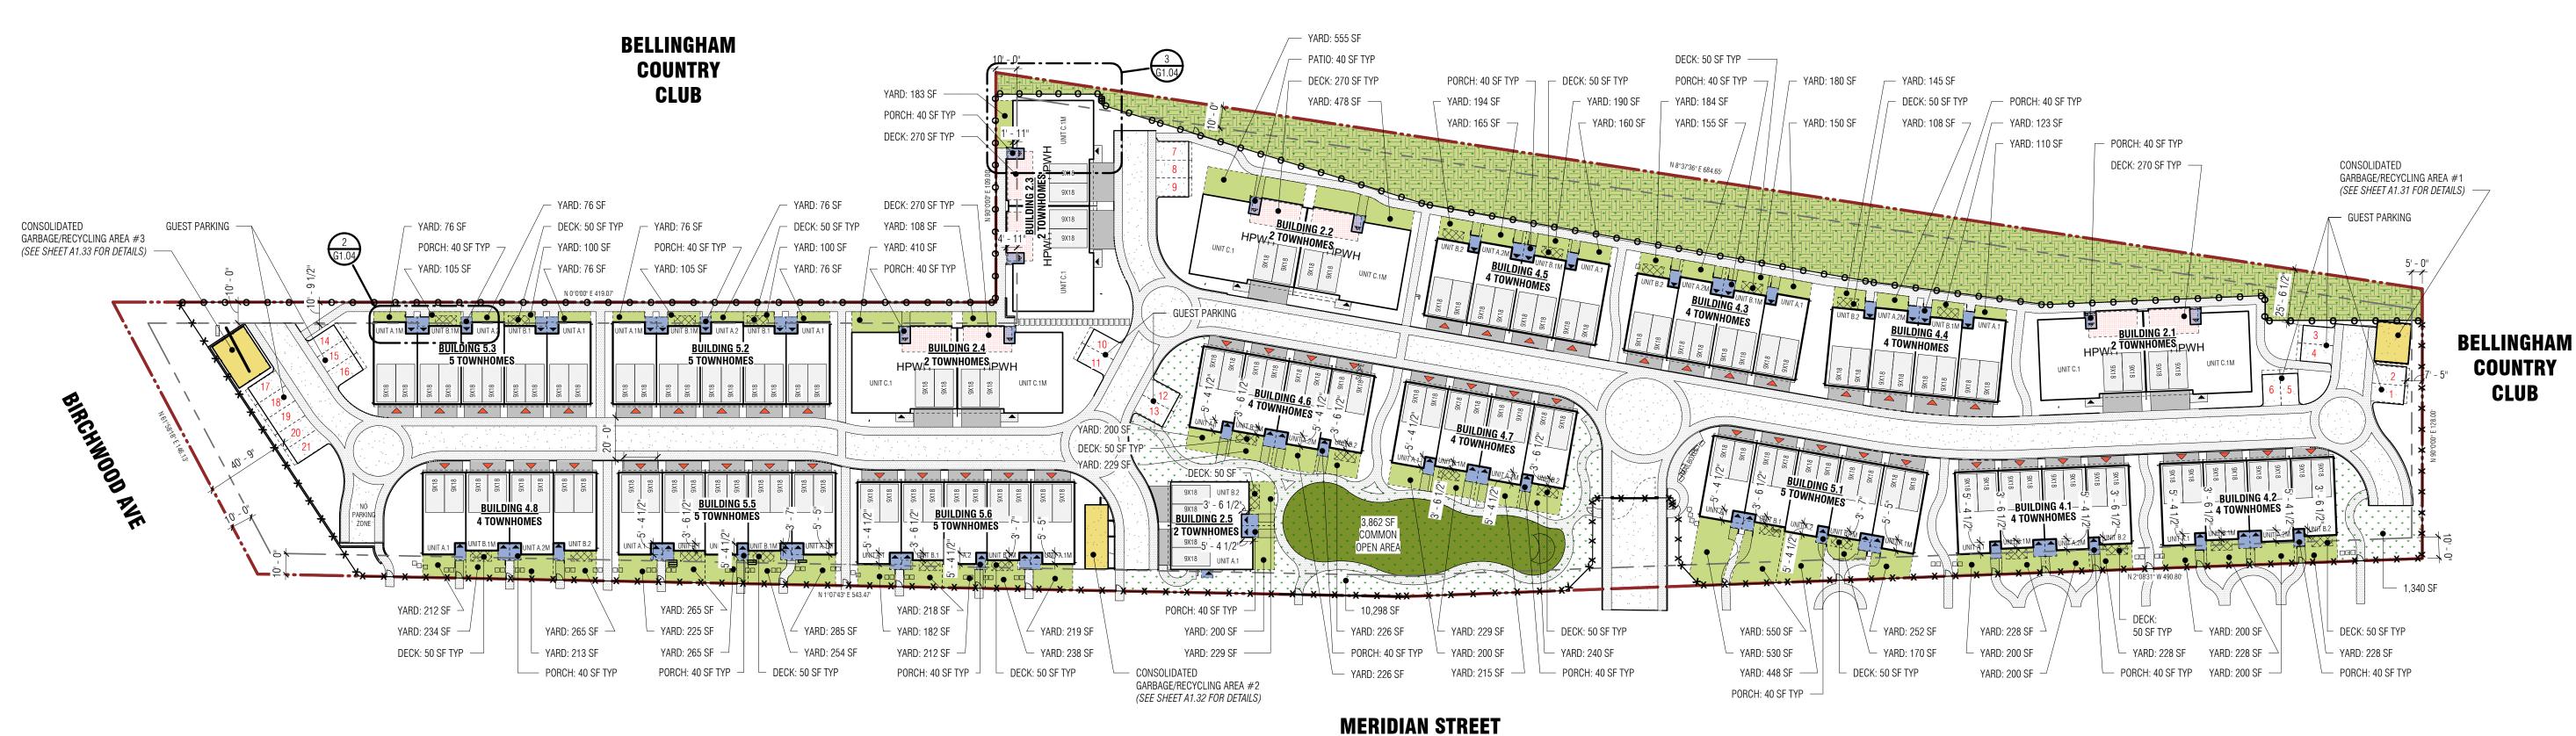

0' 20' 40' 80' 160'

Ard & Vel

9858 REGISTERED ARCHITECT

ARCHITECT

JEFFRE ALFRED PELLETIER STATE OF WASHINGTON

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CITY OF BELLINGHAM STAMP AREA

SELLINGHAM - SITE

3509 MERIDIAN STREET, BELLINGHAM, WA 98225

OWNER:

REVISION DATE DESCRIPTION

ISSUANCES

STREAM

DATE DESCRIPTION

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1/13/2023 LAND USE APP RESUBMITTAL

4/14/2023 LAND USE APP RESUBMITTAL

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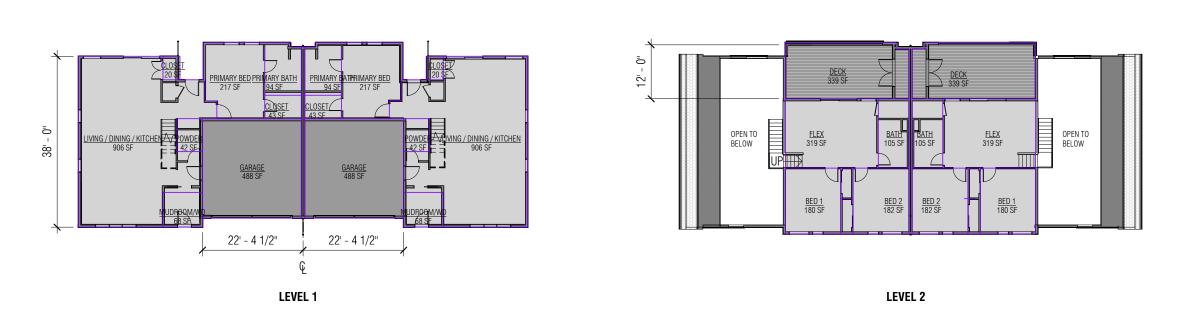
COB PROJECT #: 2021-0105

PLOT DATE: 04.12.2023

CODE DIAGRAMS - OPEN,

COMMON & PRIVATE SPACE
SHEET NO.:

G1.04




UNIT C.1


UNIT C.1M

TYPICAL BUILDING PATIO HOME


UNIT C.1

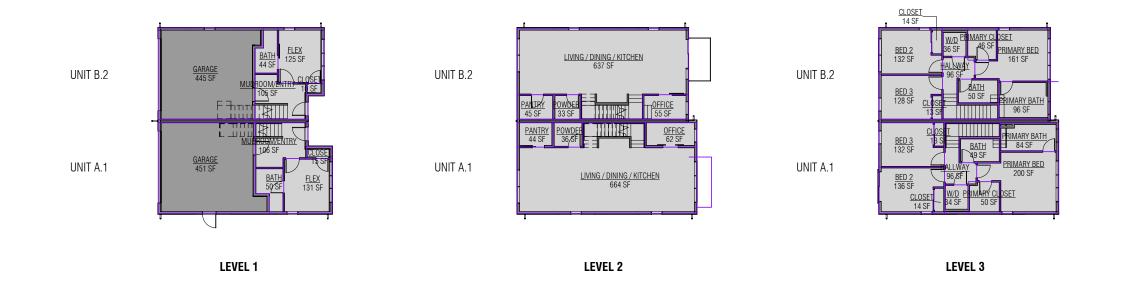

TYPICAL BUILDING 2-PACK

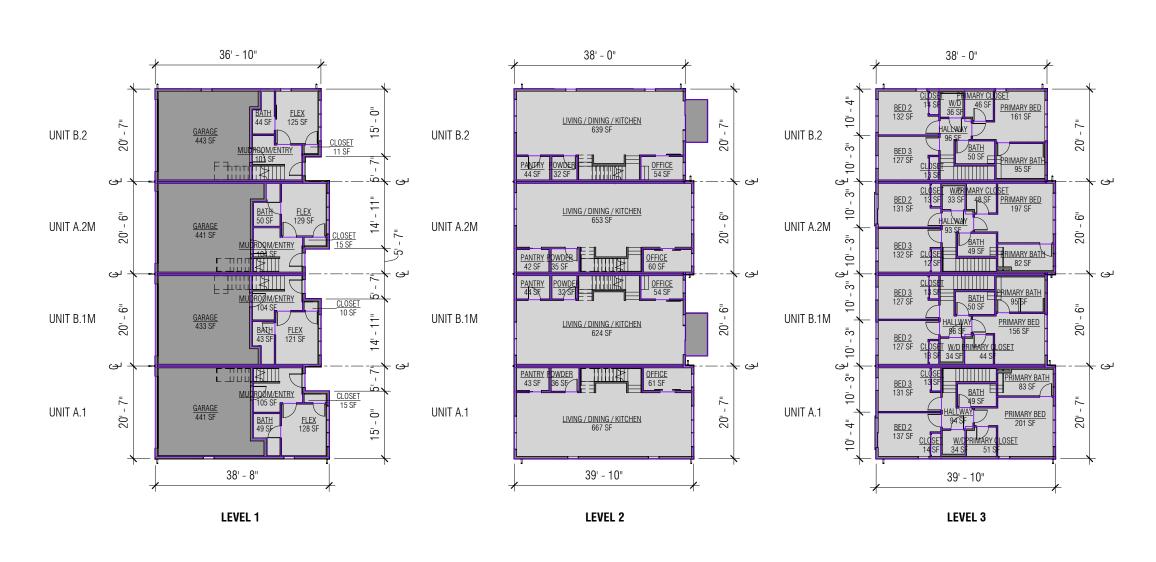

TYPICAL BUILDING 4-PACK

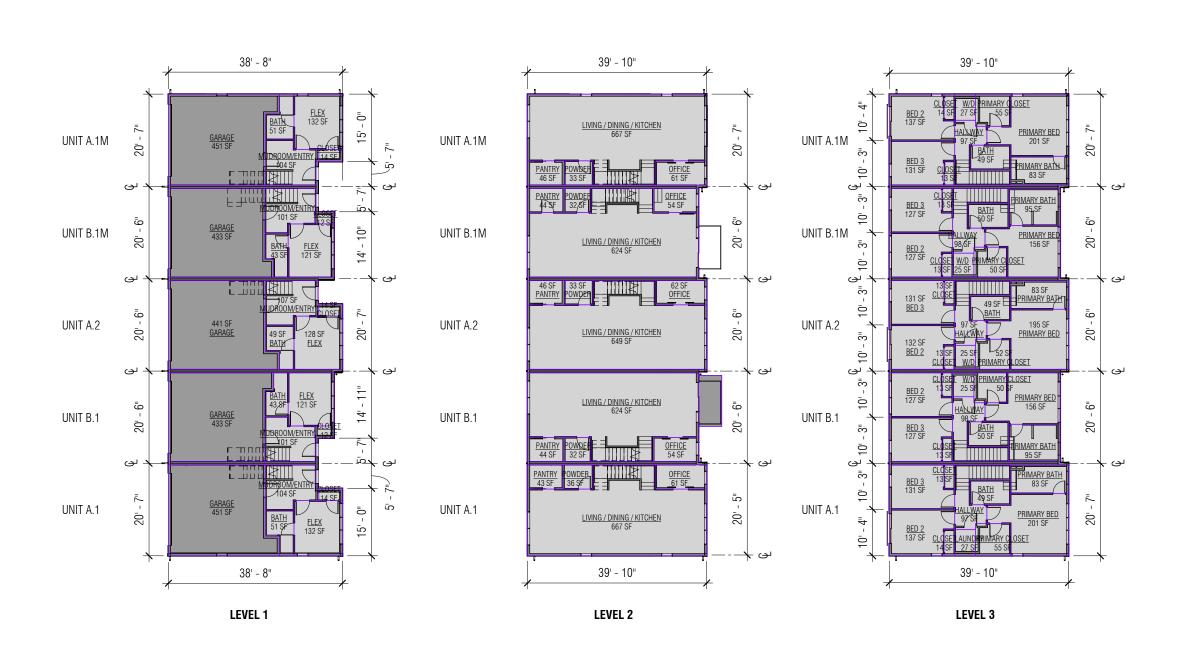

TYPICAL BUILDING 5-PACK

UNIT	LEVEL	NAME	ARE
C.1	LEVEL 1	CLOSET	43 SF
C.1	LEVEL 1	CLOSET	20 SF
C.1	LEVEL 1	LIVING / DINING / KITCHEN	906 SF
C.1	LEVEL 1	MUDROOM/WD	68 SF
C.1	LEVEL 1	POWDER	42 SF
C.1	LEVEL 1	PRIMARY BATH	94 SF
C.1	LEVEL 1	PRIMARY BED	217 SF
			1,389
C.1	LEVEL 2	BATH	105 SF
C.1	LEVEL 2	BED 1	180 SF
C.1	LEVEL 2	BED 2	182 SF
C.1	LEVEL 2	CLOSET	19 SF
C.1	LEVEL 2	CLOSET	22 SF
C.1	LEVEL 2	FLEX	319 SF
			826 SF
TOTAL	UNIT C.1 G	SSF	2,215
C.1M	LEVEL 1	CLOSET	43 SF
C.1M	LEVEL 1	CLOSET	20 SF
C.1M	LEVEL 1	LIVING / DINING / KITCHEN	906 SF
C.1M	LEVEL 1	MUDROOM/WD	68 SF
C.1M	LEVEL 1	POWDER	42 SF
C.1M	LEVEL 1	PRIMARY BATH	94 SF
C.1M	LEVEL 1	PRIMARY BED	217 SF
			1,389
C.1M	LEVEL 2	BATH	105 SF
C.1M	LEVEL 2	BED 1	180 SF
C.1M	LEVEL 2	BED 2	182 SF
C.1M	LEVEL 2	CLOSET	41 SF
C.1M	LEVEL 2	CLOSET	Redund t Area
C.1M	LEVEL 2	FLEX	319 SF
TOTAL	UNIT C.1M	1 GSF	826 SF
-			2,215
TOTAL	PATIO HOI	ME GSF	4,430

UNIT	LEVEL	NAME	ARI
01111		Will	7111
A.1	LEVEL 1	BATH	50 SF
A.1	LEVEL 1	FLEX	131 S
A.1	LEVEL 1		106 S
A.1	LEVEL 1	CLOSET	15 SF
A. I	LLVLL I	ULUSLI	303 S
A.1	LEVEL 2	LIVING / DINING / KITCHEN	664 5
A.1 A.1	LEVEL 2	PANTRY	44 SF
A.1 A.1	LEVEL 2	POWDER	36 SF
A.1 A.1	LEVEL 2	OFFICE	62 SF
A. I	LEVEL Z	UFFICE	
۸ 1	ו ביירו ס	DED 0	807 S
A.1	LEVEL 3	BED 2	130 8
A.1	LEVEL 3	BED 3	
A.1	LEVEL 3	W/D	34 SF
A.1	LEVEL 3	CLOSET	14 SF
A.1	LEVEL 3	CLOSET	13 SF
A.1	LEVEL 3	PRIMARY CLOSET	50 SF
A.1	LEVEL 3	PRIMARY BED	200 S
A.1	LEVEL 3	BATH	49 SF
A.1	LEVEL 3	PRIMARY BATH	84 SF
A.1	LEVEL 3	HALLWAY	96 SF 807 S
B.2	LEVEL 1	BATH	44 SF
B.2	LEVEL 1	FLEX	125 S
B.2	LEVEL 1	MUDROOM/ENTRY	105 S
B.2	LEVEL 1	CLOSET	10 SF
			285 9
B.2	LEVEL 2	LIVING / DINING / KITCHEN	637 9
B.2	LEVEL 2	PANTRY	45 SF
B.2	LEVEL 2	POWDER	33 SF
B.2	LEVEL 2	OFFICE	55 SF
			770 S
B.2	LEVEL 3	BED 2	132 S
B.2	LEVEL 3	BED 3	128 9
B.2	LEVEL 3	W/D	36 SF
B.2	LEVEL 3	CLOSET	14 SF
B.2	LEVEL 3	CLOSET	13 SF
B.2	LEVEL 3	PRIMARY CLOSET	46 SF
B.2	LEVEL 3	PRIMARY BED	161 S
B.2	LEVEL 3	BATH	50 SF
B.2	LEVEL 3	PRIMARY BATH	96 SF
B.2	LEVEL 3	HALLWAY	96 SF
_		1	773 S
TOTAI	UNIT B.2	GSF	1,827
	_ 2-PACK (3,744
			٠,. ١

Λ -4	LEVEL 1	BATH	49 SF
A.1	LEVEL 1	FLEX	128 SF
A.1	LEVEL 1	MUDROOM/ENTRY	105 SF
A.1	LEVEL 1	CLOSET	15 SF
۸ 1	ו דיירו ס	LIVING / DINING / IZITGLIEN	298 SF
A.1 A.1	LEVEL 2	LIVING / DINING / KITCHEN PANTRY	667 SF 43 SF
A.1 A.1	LEVEL 2	POWDER	36 SF
			61 SF
A.1	LEVEL 2	OFFICE	
۸ 1	ו דיירו	DED 0	807 SF
A.1		BED 2	137 SF
A.1	LEVEL 3	BED 3	131 SF
A.1	LEVEL 3	W/D	34 SF
A.1	LEVEL 3	CLOSET	14 SF
A.1	LEVEL 3	CLOSET	13 SF
A.1	LEVEL 3	BATH	49 SF
A.1		PRIMARY CLOSET	51 SF
A.1		PRIMARY BED	201 SF
A.1	LEVEL 3	PRIMARY BATH	83 SF
A.1	LEVEL 3	HALLWAY	94 SF
TOTAL	UNIT A.1	GSF	807 SF 1,911 SF
۸ ۵۰۰	10/5	DATH	
	LEVEL 1	BATH	50 SF
	LEVEL 1	FLEX	129 SF
	LEVEL 1	MUDROOM/ENTRY	104 SF
A.2M	LEVEL 1	CLOSET	15 SF
			297 SF
A.2M		LIVING / DINING / KITCHEN	653 SF
A.2M	LEVEL 2	PANTRY	42 SF
A.2M	LEVEL 2	POWDER	35 SF
A.2M	LEVEL 2	OFFICE	60 SF
			790 SF
A.2M	LEVEL 3	BED 2	131 SF
A.2M	LEVEL 3	BED 3	132 SF
		W/D	33 SF
A.2M	LEVEL 3	CLOSET	13 SF
A.2M	LEVEL 3	CLOSET	12 SF
A.2M	LEVEL 3	BATH	49 SF
A.2M	LEVEL 3	PRIMARY CLOSET	48 SF
A.2M	LEVEL 3	PRIMARY BED	197 SF
A.2M		PRIMARY BATH	82 SF
A.2M	LEVEL 3	HALLWAY	93 SF 790 SF
B.1M B.1M	LEVEL 1	BATH FLEX	43 SF 121 SF
		MUDROOM/ENTRY	104 SF
B.1M	LEVEL 1	CLOSET	10 SF
D 414	1.5./51.0	LIVING / DINING / I/ITOLIFN	279 SF
		LIVING / DINING / KITCHEN	624 SF
B.1M	LEVEL 2	PANTRY	44 SF
B.1M B.1M	LEVEL 2	POWDER OFFICE	32 SF 54 SF
D. HVI	LLVLL Z	OTTIOL	754 SF
B.1M	LEVEL 3	BED 2	10701
ווו.ש	LLLVLL O		127 CF
R 11/1			127 SF
B.1M B.1M	LEVEL 3	BED 3	127 SF
B.1M	LEVEL 3 LEVEL 3	BED 3 W/D	127 SF 34 SF
B.1M B.1M	LEVEL 3 LEVEL 3 LEVEL 3	BED 3 W/D CLOSET	127 SF 34 SF 13 SF
B.1M B.1M B.1M	LEVEL 3 LEVEL 3 LEVEL 3 LEVEL 3	BED 3 W/D CLOSET CLOSET	127 SF 34 SF 13 SF 13 SF
B.1M B.1M B.1M B.1M	LEVEL 3 LEVEL 3 LEVEL 3 LEVEL 3	BED 3 W/D CLOSET CLOSET BATH	127 SF 34 SF 13 SF 13 SF 50 SF
B.1M B.1M B.1M B.1M B.1M	LEVEL 3 LEVEL 3 LEVEL 3 LEVEL 3 LEVEL 3	BED 3 W/D CLOSET CLOSET BATH PRIMARY CLOSET	127 SF 34 SF 13 SF 13 SF 50 SF 44 SF
B.1M B.1M B.1M B.1M B.1M B.1M	LEVEL 3	BED 3 W/D CLOSET CLOSET BATH PRIMARY CLOSET PRIMARY BED	127 SF 34 SF 13 SF 13 SF 50 SF 44 SF 156 SF
B.1M B.1M B.1M B.1M B.1M B.1M B.1M	LEVEL 3	BED 3 W/D CLOSET CLOSET BATH PRIMARY CLOSET PRIMARY BED PRIMARY BATH	127 SF 34 SF 13 SF 13 SF 50 SF 44 SF 156 SF 95 SF
B.1M B.1M B.1M B.1M B.1M B.1M	LEVEL 3	BED 3 W/D CLOSET CLOSET BATH PRIMARY CLOSET PRIMARY BED	127 SF 34 SF 13 SF 13 SF 50 SF 44 SF 156 SF 95 SF 96 SF
B.1M B.1M B.1M B.1M B.1M B.1M B.1M B.1M	LEVEL 3	BED 3 W/D CLOSET CLOSET BATH PRIMARY CLOSET PRIMARY BED PRIMARY BATH HALLWAY	127 SF 34 SF 13 SF 13 SF 50 SF 44 SF 156 SF 95 SF 96 SF 754 SF
B.1M B.1M B.1M B.1M B.1M B.1M B.1M B.1M	LEVEL 3	BED 3 W/D CLOSET CLOSET BATH PRIMARY CLOSET PRIMARY BED PRIMARY BATH HALLWAY	127 SF 34 SF 13 SF 13 SF 50 SF 44 SF 156 SF 95 SF 96 SF 754 SF 1,786 SF
B.1M B.1M B.1M B.1M B.1M B.1M B.1M B.1M	LEVEL 3	BED 3 W/D CLOSET CLOSET BATH PRIMARY CLOSET PRIMARY BED PRIMARY BATH HALLWAY M GSF BATH	127 SF 34 SF 13 SF 13 SF 50 SF 44 SF 156 SF 95 SF 96 SF 754 SF 1,786 SF
B.1M B.1M B.1M B.1M B.1M B.1M B.1M B.1M	LEVEL 3 LEVEL 1	BED 3 W/D CLOSET CLOSET BATH PRIMARY CLOSET PRIMARY BED PRIMARY BATH HALLWAY M GSF BATH FLEX	127 SF 34 SF 13 SF 13 SF 50 SF 44 SF 156 SF 95 SF 96 SF 754 SF 1,786 SF
B.1M B.1M B.1M B.1M B.1M B.1M B.1M B.1M	LEVEL 3 LEVEL 1 LEVEL 1 LEVEL 1	BED 3 W/D CLOSET CLOSET BATH PRIMARY CLOSET PRIMARY BED PRIMARY BATH HALLWAY M GSF BATH FLEX MUDROOM/ENTRY	127 SF 34 SF 13 SF 13 SF 50 SF 44 SF 156 SF 95 SF 96 SF 754 SF 1,786 SF 44 SF 125 SF 101 SF
B.1M B.1M B.1M B.1M B.1M B.1M B.1M B.1M	LEVEL 3 LEVEL 1	BED 3 W/D CLOSET CLOSET BATH PRIMARY CLOSET PRIMARY BED PRIMARY BATH HALLWAY M GSF BATH FLEX	127 SF 34 SF 13 SF 13 SF 50 SF 44 SF 156 SF 95 SF 96 SF 754 SF 1,786 SF
B.1M B.1M B.1M B.1M B.1M B.1M B.1M B.1M	LEVEL 3 LEVEL 1 LEVEL 1 LEVEL 1	BED 3 W/D CLOSET CLOSET BATH PRIMARY CLOSET PRIMARY BED PRIMARY BATH HALLWAY M GSF BATH FLEX MUDROOM/ENTRY	127 SF 34 SF 13 SF 13 SF 50 SF 44 SF 156 SF 95 SF 96 SF 754 SF 1,786 SF 44 SF 125 SF 101 SF
B.1M B.1M B.1M B.1M B.1M B.1M B.1M B.1M	LEVEL 3 LEVEL 1 LEVEL 1 LEVEL 1 LEVEL 1	BED 3 W/D CLOSET CLOSET BATH PRIMARY CLOSET PRIMARY BED PRIMARY BATH HALLWAY M GSF BATH FLEX MUDROOM/ENTRY	127 SF 34 SF 13 SF 13 SF 50 SF 44 SF 156 SF 95 SF 96 SF 754 SF 1,786 SF 44 SF 125 SF 101 SF
B.1M B.1M B.1M B.1M B.1M B.1M B.1M TOTAL B.2 B.2 B.2	LEVEL 3 LEVEL 1 LEVEL 1 LEVEL 1 LEVEL 1 LEVEL 1	BED 3 W/D CLOSET CLOSET BATH PRIMARY CLOSET PRIMARY BED PRIMARY BATH HALLWAY M GSF BATH FLEX MUDROOM/ENTRY CLOSET	127 SF 34 SF 13 SF 13 SF 50 SF 44 SF 156 SF 95 SF 96 SF 754 SF 1,786 SF 44 SF 125 SF 101 SF 11 SF 282 SF
B.1M B.1M B.1M B.1M B.1M B.1M B.1M TOTAL B.2 B.2 B.2 B.2	LEVEL 3 LEVEL 1 LEVEL 1 LEVEL 1 LEVEL 1 LEVEL 1 LEVEL 2 LEVEL 2	BED 3 W/D CLOSET CLOSET BATH PRIMARY CLOSET PRIMARY BED PRIMARY BATH HALLWAY M GSF BATH FLEX MUDROOM/ENTRY CLOSET LIVING / DINING / KITCHEN	127 SF 34 SF 13 SF 13 SF 50 SF 44 SF 156 SF 95 SF 96 SF 754 SF 1,786 SF 44 SF 125 SF 101 SF 11 SF 282 SF 639 SF 44 SF
B.1M B.1M B.1M B.1M B.1M B.1M B.1M TOTAL B.2 B.2 B.2 B.2 B.2 B.2	LEVEL 3 LEVEL 1 LEVEL 1 LEVEL 1 LEVEL 1 LEVEL 1 LEVEL 2 LEVEL 2	BED 3 W/D CLOSET CLOSET BATH PRIMARY CLOSET PRIMARY BED PRIMARY BATH HALLWAY M GSF BATH FLEX MUDROOM/ENTRY CLOSET LIVING / DINING / KITCHEN PANTRY POWDER	127 SF 34 SF 13 SF 13 SF 50 SF 44 SF 156 SF 95 SF 96 SF 754 SF 1,786 SF 125 SF 101 SF 11 SF 282 SF 639 SF 44 SF 32 SF
B.1M B.1M B.1M B.1M B.1M B.1M B.1M TOTAL B.2 B.2 B.2 B.2 B.2	LEVEL 3 LEVEL 1 LEVEL 1 LEVEL 1 LEVEL 1 LEVEL 1 LEVEL 2 LEVEL 2	BED 3 W/D CLOSET CLOSET BATH PRIMARY CLOSET PRIMARY BED PRIMARY BATH HALLWAY M GSF BATH FLEX MUDROOM/ENTRY CLOSET LIVING / DINING / KITCHEN PANTRY POWDER	127 SF 34 SF 13 SF 13 SF 50 SF 44 SF 156 SF 95 SF 96 SF 754 SF 1,786 SF 44 SF 125 SF 101 SF 11 SF 282 SF 639 SF 44 SF 32 SF 54 SF
B.1M B.1M B.1M B.1M B.1M B.1M B.1M TOTAL B.2 B.2 B.2 B.2 B.2 B.2	LEVEL 3 LEVEL 1 LEVEL 1 LEVEL 1 LEVEL 1 LEVEL 2 LEVEL 2 LEVEL 2	BED 3 W/D CLOSET CLOSET CLOSET BATH PRIMARY CLOSET PRIMARY BED PRIMARY BATH HALLWAY // GSF BATH FLEX MUDROOM/ENTRY CLOSET LIVING / DINING / KITCHEN PANTRY POWDER OFFICE	127 SF 34 SF 13 SF 13 SF 50 SF 44 SF 156 SF 95 SF 96 SF 754 SF 1,786 SF 44 SF 125 SF 101 SF 11 SF 282 SF 639 SF 44 SF 32 SF 54 SF 770 SF
B.1M B.1M B.1M B.1M B.1M B.1M B.1M TOTAL B.2 B.2 B.2 B.2 B.2 B.2 B.2	LEVEL 3 LEVEL 1 LEVEL 1 LEVEL 1 LEVEL 1 LEVEL 2 LEVEL 2 LEVEL 2 LEVEL 2 LEVEL 2	BED 3 W/D CLOSET CLOSET BATH PRIMARY CLOSET PRIMARY BED PRIMARY BATH HALLWAY A GSF BATH FLEX MUDROOM/ENTRY CLOSET LIVING / DINING / KITCHEN PANTRY POWDER OFFICE	127 SF 34 SF 13 SF 13 SF 50 SF 44 SF 156 SF 95 SF 96 SF 754 SF 1,786 SF 44 SF 125 SF 101 SF 11 SF 282 SF 639 SF 44 SF 32 SF 54 SF 770 SF 132 SF
B.1M B.1M B.1M B.1M B.1M B.1M B.1M TOTAL B.2 B.2 B.2 B.2 B.2 B.2 B.2 B.2	LEVEL 3 LEVEL 1 LEVEL 1 LEVEL 1 LEVEL 1 LEVEL 2 LEVEL 2 LEVEL 2 LEVEL 2 LEVEL 3	BED 3 W/D CLOSET CLOSET BATH PRIMARY CLOSET PRIMARY BED PRIMARY BATH HALLWAY M GSF BATH FLEX MUDROOM/ENTRY CLOSET LIVING / DINING / KITCHEN PANTRY POWDER OFFICE BED 2 BED 3	127 SF 34 SF 13 SF 13 SF 50 SF 44 SF 156 SF 95 SF 96 SF 754 SF 1,786 SF 125 SF 101 SF 11 SF 282 SF 639 SF 44 SF 32 SF 54 SF 770 SF 132 SF 127 SF
B.1M B.1M B.1M B.1M B.1M B.1M B.1M TOTAL B.2 B.2 B.2 B.2 B.2 B.2 B.2 B.2 B.2 B.2	LEVEL 3 LEVEL 1 LEVEL 1 LEVEL 1 LEVEL 1 LEVEL 2 LEVEL 2 LEVEL 2 LEVEL 2 LEVEL 3 LEVEL 3	BED 3 W/D CLOSET CLOSET CLOSET BATH PRIMARY CLOSET PRIMARY BED PRIMARY BATH HALLWAY MGSF BATH FLEX MUDROOM/ENTRY CLOSET LIVING / DINING / KITCHEN PANTRY POWDER OFFICE BED 2 BED 3 W/D	127 SF 34 SF 13 SF 13 SF 50 SF 44 SF 156 SF 95 SF 96 SF 754 SF 1,786 SF 44 SF 125 SF 101 SF 11 SF 282 SF 639 SF 44 SF 32 SF 54 SF 770 SF 132 SF 127 SF 36 SF
B.1M B.1M B.1M B.1M B.1M B.1M B.1M TOTAL B.2 B.2 B.2 B.2 B.2 B.2 B.2 B.2 B.2 B.2	LEVEL 3 LEVEL 1 LEVEL 1 LEVEL 1 LEVEL 1 LEVEL 2 LEVEL 2 LEVEL 2 LEVEL 2 LEVEL 3 LEVEL 3 LEVEL 3 LEVEL 3	BED 3 W/D CLOSET CLOSET CLOSET BATH PRIMARY CLOSET PRIMARY BED PRIMARY BATH HALLWAY MGSF BATH FLEX MUDROOM/ENTRY CLOSET LIVING / DINING / KITCHEN PANTRY POWDER OFFICE BED 2 BED 3 W/D CLOSET	127 SF 34 SF 13 SF 13 SF 50 SF 44 SF 156 SF 95 SF 96 SF 754 SF 1,786 SF 44 SF 125 SF 101 SF 11 SF 282 SF 639 SF 44 SF 32 SF 54 SF 770 SF 132 SF 127 SF 36 SF 14 SF
B.1M B.1M B.1M B.1M B.1M B.1M B.1M TOTAL B.2 B.2 B.2 B.2 B.2 B.2 B.2 B.2 B.2 B.2	LEVEL 3 LEVEL 1 LEVEL 1 LEVEL 1 LEVEL 1 LEVEL 2 LEVEL 2 LEVEL 2 LEVEL 2 LEVEL 3	BED 3 W/D CLOSET CLOSET CLOSET BATH PRIMARY CLOSET PRIMARY BED PRIMARY BATH HALLWAY A GSF BATH FLEX MUDROOM/ENTRY CLOSET LIVING / DINING / KITCHEN PANTRY POWDER OFFICE BED 2 BED 3 W/D CLOSET CLOSET	127 SF 34 SF 13 SF 13 SF 50 SF 44 SF 156 SF 95 SF 96 SF 754 SF 1,786 SF 44 SF 125 SF 101 SF 11 SF 282 SF 639 SF 44 SF 32 SF 54 SF 770 SF 132 SF 127 SF 36 SF 14 SF 13 SF
B.1M B.1M B.1M B.1M B.1M B.1M B.1M TOTAL B.2 B.2 B.2 B.2 B.2 B.2 B.2 B.2 B.2 B.2	LEVEL 3 LEVEL 1 LEVEL 1 LEVEL 1 LEVEL 1 LEVEL 2 LEVEL 2 LEVEL 2 LEVEL 2 LEVEL 3	BED 3 W/D CLOSET CLOSET BATH PRIMARY CLOSET PRIMARY BED PRIMARY BATH HALLWAY A GSF BATH FLEX MUDROOM/ENTRY CLOSET LIVING / DINING / KITCHEN PANTRY POWDER OFFICE BED 2 BED 3 W/D CLOSET CLOSET CLOSET BATH	127 SF 34 SF 13 SF 13 SF 50 SF 44 SF 156 SF 95 SF 96 SF 754 SF 1,786 SF 125 SF 101 SF 11 SF 282 SF 639 SF 44 SF 32 SF 54 SF 770 SF 132 SF 127 SF 36 SF 14 SF 13 SF 13 SF 50 SF
B.1M B.1M B.1M B.1M B.1M B.1M B.1M TOTAL B.2 B.2 B.2 B.2 B.2 B.2 B.2 B.2 B.2 B.2	LEVEL 3 LEVEL 1 LEVEL 1 LEVEL 1 LEVEL 1 LEVEL 2 LEVEL 2 LEVEL 2 LEVEL 2 LEVEL 2 LEVEL 3	BED 3 W/D CLOSET CLOSET CLOSET BATH PRIMARY CLOSET PRIMARY BED PRIMARY BATH HALLWAY MGSF BATH FLEX MUDROOM/ENTRY CLOSET LIVING / DINING / KITCHEN PANTRY POWDER OFFICE BED 2 BED 3 W/D CLOSET CLOSET CLOSET BATH PRIMARY CLOSET	127 SF 34 SF 13 SF 13 SF 50 SF 44 SF 156 SF 95 SF 96 SF 754 SF 1,786 SF 44 SF 125 SF 101 SF 282 SF 639 SF 44 SF 32 SF 54 SF 770 SF 132 SF 127 SF 132 SF 14 SF 13 SF 50 SF 46 SF
B.1M B.1M B.1M B.1M B.1M B.1M B.1M TOTAL B.2 B.2 B.2 B.2 B.2 B.2 B.2 B.2 B.2 B.2	LEVEL 3 LEVEL 1 LEVEL 1 LEVEL 1 LEVEL 1 LEVEL 2 LEVEL 2 LEVEL 2 LEVEL 2 LEVEL 2 LEVEL 3	BED 3 W/D CLOSET CLOSET CLOSET BATH PRIMARY CLOSET PRIMARY BED PRIMARY BATH HALLWAY A GSF BATH FLEX MUDROOM/ENTRY CLOSET LIVING / DINING / KITCHEN PANTRY POWDER OFFICE BED 2 BED 3 W/D CLOSET CLOSET CLOSET BATH PRIMARY CLOSET PRIMARY CLOSET	127 SF 34 SF 13 SF 13 SF 50 SF 44 SF 156 SF 95 SF 96 SF 754 SF 1,786 SF 44 SF 125 SF 101 SF 11 SF 282 SF 639 SF 44 SF 32 SF 54 SF 770 SF 132 SF 127 SF 36 SF 14 SF 13 SF 50 SF 46 SF
B.1M B.1M B.1M B.1M B.1M B.1M B.1M B.1M	LEVEL 3 LEVEL 1 LEVEL 1 LEVEL 1 LEVEL 1 LEVEL 2 LEVEL 2 LEVEL 2 LEVEL 2 LEVEL 3	BED 3 W/D CLOSET CLOSET CLOSET BATH PRIMARY CLOSET PRIMARY BED PRIMARY BATH HALLWAY A GSF BATH FLEX MUDROOM/ENTRY CLOSET LIVING / DINING / KITCHEN PANTRY POWDER OFFICE BED 2 BED 3 W/D CLOSET CLOSET CLOSET BATH PRIMARY CLOSET PRIMARY BED PRIMARY BED PRIMARY BED	127 SF 34 SF 13 SF 13 SF 50 SF 44 SF 156 SF 95 SF 96 SF 754 SF 1,786 SF 44 SF 125 SF 101 SF 11 SF 282 SF 639 SF 44 SF 32 SF 54 SF 770 SF 132 SF 127 SF 136 SF 14 SF 13 SF 50 SF 46 SF
B.1M B.1M B.1M B.1M B.1M B.1M B.1M TOTAL B.2 B.2 B.2 B.2 B.2 B.2 B.2 B.2 B.2 B.2	LEVEL 3 LEVEL 1 LEVEL 1 LEVEL 1 LEVEL 1 LEVEL 2 LEVEL 2 LEVEL 2 LEVEL 2 LEVEL 2 LEVEL 3	BED 3 W/D CLOSET CLOSET CLOSET BATH PRIMARY CLOSET PRIMARY BED PRIMARY BATH HALLWAY A GSF BATH FLEX MUDROOM/ENTRY CLOSET LIVING / DINING / KITCHEN PANTRY POWDER OFFICE BED 2 BED 3 W/D CLOSET CLOSET CLOSET BATH PRIMARY CLOSET PRIMARY CLOSET	127 SF 34 SF 13 SF 13 SF 50 SF 44 SF 156 SF 95 SF 96 SF 754 SF 1,786 SF 125 SF 101 SF 11 SF 282 SF 639 SF 44 SF 32 SF 54 SF 770 SF 132 SF 127 SF 36 SF 14 SF 13 SF 15 SF 16 SF 16 SF 16 SF
B.1M B.1M B.1M B.1M B.1M B.1M B.1M TOTAL B.2 B.2 B.2 B.2 B.2 B.2 B.2 B.2 B.2 B.2	LEVEL 3 LEVEL 1 LEVEL 1 LEVEL 1 LEVEL 1 LEVEL 2 LEVEL 2 LEVEL 2 LEVEL 2 LEVEL 3	BED 3 W/D CLOSET CLOSET CLOSET BATH PRIMARY CLOSET PRIMARY BED PRIMARY BATH HALLWAY A GSF BATH FLEX MUDROOM/ENTRY CLOSET LIVING / DINING / KITCHEN PANTRY POWDER OFFICE BED 2 BED 3 W/D CLOSET CLOSET CLOSET CLOSET BATH PRIMARY CLOSET PRIMARY BED PRIMARY BED PRIMARY BATH HALLWAY	127 SF 34 SF 13 SF 13 SF 50 SF 44 SF 156 SF 95 SF 96 SF 754 SF 1,786 SF 44 SF 125 SF 101 SF 11 SF 282 SF 639 SF 44 SF 32 SF 54 SF 770 SF 132 SF 127 SF 36 SF 14 SF 13 SF 50 SF 46 SF

A.1 A.1		DAIN	3135
Δ1	LEVEL 1	FLEX	132 SF
Λ. Ι	LEVEL 1	MUDROOM/ENTRY	104 SF
A.1	LEVEL 1	CLOSET	14 SF
			301 SF
A.1	LEVEL 2	LIVING / DINING / KITCHEN	667 SF
	LEVEL 2		43 SF
A.1		PANTRY	
A.1	LEVEL 2	POWDER	36 SF
A.1	LEVEL 2	OFFICE	61 SF
			807 SF
A.1	LEVEL 3	BED 2	137 SF
A.1	LEVEL 3	BED 3	131 SF
A.1	LEVEL 3	LAUNDRY	27 SF
A.1	LEVEL 3	CLOSET	14 SF
A.1	LEVEL 3	CLOSET	13 SF
A.1	LEVEL 3	BATH	49 SF
A.1	LEVEL 3	PRIMARY CLOSET	55 SF
A.1	LEVEL 3	PRIMARY BED	201 SF
A.1	LEVEL 3	PRIMARY BATH	83 SF
A.1	LEVEL 3	HALLWAY	97 SF
TOTAL	UNIT A.1	GSF	807 SF 1,914
A.1M	LEVEL 1	BATH	51 SF
	LEVEL 1	FLEX	132 SF
	LEVEL 1	MUDROOM/ENTRY	104 SF
A.1M	LEVEL 1	CLOSET	14 SF
			301 SF
A.1M	LEVEL 2	LIVING / DINING / KITCHEN	667 SF
	LEVEL 2	PANTRY	46 SF
	LEVEL 2	POWDER	33 SF
			61 SF
A. HVI	LEVEL 2	OFFICE	
	1		807 SF
A.1M	LEVEL 3	BED 2	137 SF
A.1M	LEVEL 3	BED 3	131 SF
A.1M	LEVEL 3	W/D	27 SF
	LEVEL 3	CLOSET	14 SF
	LEVEL 3	CLOSET	13 SF
	LEVEL 3	BATH	49 SF
A.1M	LEVEL 3	PRIMARY CLOSET	55 SF
A 4 N A	LEVEL 3	PRIMARY BED	201 SF
A. HVI	LEVEL 3	PRIMARY BATH	83 SF
			97 SF
A.1M	E\/E 2	HALLWAT	
A.1M	LEVEL 3		007.00
A.1M A.1M TOTAL	UNIT A.1		1,914
A.1M A.1M TOTAL A.2	UNIT A.1I	ВАТН	807 SF 1,914 S 49 SF
A.1M A.1M TOTAL	UNIT A.1		1,914 49 SF
A.1M A.1M TOTAL A.2	UNIT A.1I	ВАТН	1,914 S 49 SF 128 SF
A.1M A.1M TOTAL A.2 A.2	LEVEL 1	BATH FLEX	1,914 49 SF 128 SF
A.1M A.1M TOTAL A.2 A.2 A.2	LEVEL 1 LEVEL 1 LEVEL 1	BATH FLEX MUDROOM/ENTRY	1,914 = 49 SF
A.1M A.1M TOTAL A.2 A.2 A.2 A.2	LEVEL 1 LEVEL 1 LEVEL 1 LEVEL 1	BATH FLEX MUDROOM/ENTRY CLOSET	1,914 S 49 SF 128 SF 107 SF 14 SF 298 SF
A.1M A.1M TOTAL A.2 A.2 A.2 A.2	LEVEL 1 LEVEL 1 LEVEL 1 LEVEL 1 LEVEL 1 LEVEL 2	BATH FLEX MUDROOM/ENTRY CLOSET LIVING / DINING / KITCHEN	1,914 3 49 SF 128 SF 107 SF 14 SF 298 SF 649 SF
A.1M A.1M TOTAL A.2 A.2 A.2 A.2 A.2	LEVEL 1 LEVEL 1 LEVEL 1 LEVEL 1 LEVEL 2 LEVEL 2	BATH FLEX MUDROOM/ENTRY CLOSET LIVING / DINING / KITCHEN PANTRY	1,914 3 49 SF 128 SF 107 SF 14 SF 298 SF 649 SF 46 SF
A.1M A.1M TOTAL A.2 A.2 A.2 A.2	LEVEL 1 LEVEL 1 LEVEL 1 LEVEL 1 LEVEL 1 LEVEL 2	BATH FLEX MUDROOM/ENTRY CLOSET LIVING / DINING / KITCHEN PANTRY	1,914 3 49 SF 128 SF 107 SF 14 SF 298 SF 649 SF
A.1M A.1M TOTAL A.2 A.2 A.2 A.2 A.2	LEVEL 1 LEVEL 1 LEVEL 1 LEVEL 1 LEVEL 2 LEVEL 2	BATH FLEX MUDROOM/ENTRY CLOSET LIVING / DINING / KITCHEN PANTRY	1,914 S 49 SF 128 SF 107 SF 14 SF 298 SF 649 SF 46 SF
A.1M A.1M TOTAL A.2 A.2 A.2 A.2 A.2 A.2	LEVEL 1 LEVEL 1 LEVEL 1 LEVEL 1 LEVEL 2 LEVEL 2 LEVEL 2	BATH FLEX MUDROOM/ENTRY CLOSET LIVING / DINING / KITCHEN PANTRY POWDER	1,914 S 49 SF 128 SF 107 SF 14 SF 298 SF 649 SF 46 SF 33 SF 62 SF
A.1M A.1M TOTAL A.2 A.2 A.2 A.2 A.2 A.2 A.2	LEVEL 1 LEVEL 1 LEVEL 1 LEVEL 1 LEVEL 2 LEVEL 2 LEVEL 2 LEVEL 2	BATH FLEX MUDROOM/ENTRY CLOSET LIVING / DINING / KITCHEN PANTRY POWDER OFFICE	1,914 S 49 SF 128 SF 107 SF 14 SF 298 SF 649 SF 46 SF 33 SF 62 SF 790 SF
A.1M A.1M TOTAL A.2 A.2 A.2 A.2 A.2 A.2 A.2 A.2	LEVEL 1 LEVEL 1 LEVEL 1 LEVEL 1 LEVEL 2 LEVEL 2 LEVEL 2 LEVEL 2 LEVEL 3	BATH FLEX MUDROOM/ENTRY CLOSET LIVING / DINING / KITCHEN PANTRY POWDER OFFICE BED 2	1,914 S 49 SF 128 SF 107 SF 14 SF 298 SF 649 SF 46 SF 33 SF 62 SF 790 SF 132 SF
A.1M A.1M TOTAL A.2 A.2 A.2 A.2 A.2 A.2 A.2 A.2 A.2 A.2	LEVEL 1 LEVEL 1 LEVEL 1 LEVEL 1 LEVEL 2 LEVEL 2 LEVEL 2 LEVEL 2 LEVEL 3 LEVEL 3	BATH FLEX MUDROOM/ENTRY CLOSET LIVING / DINING / KITCHEN PANTRY POWDER OFFICE BED 2 BED 3	1,914 S 49 SF 128 SF 107 SF 14 SF 298 SF 649 SF 46 SF 33 SF 62 SF 790 SF 132 SF 131 SF
A.1M A.1M TOTAL A.2 A.2 A.2 A.2 A.2 A.2 A.2 A.2 A.2 A.2	LEVEL 1 LEVEL 1 LEVEL 1 LEVEL 1 LEVEL 2 LEVEL 2 LEVEL 2 LEVEL 2 LEVEL 3 LEVEL 3 LEVEL 3	BATH FLEX MUDROOM/ENTRY CLOSET LIVING / DINING / KITCHEN PANTRY POWDER OFFICE BED 2 BED 3 W/D	1,914 3 49 SF 128 SF 107 SF 14 SF 298 SF 649 SF 46 SF 33 SF 62 SF 790 SF 132 SF 131 SF 25 SF
A.1M A.1M TOTAL A.2 A.2 A.2 A.2 A.2 A.2 A.2 A.2 A.2 A.2	LEVEL 1 LEVEL 1 LEVEL 1 LEVEL 1 LEVEL 2 LEVEL 2 LEVEL 2 LEVEL 2 LEVEL 3 LEVEL 3	BATH FLEX MUDROOM/ENTRY CLOSET LIVING / DINING / KITCHEN PANTRY POWDER OFFICE BED 2 BED 3	1,914 S 49 SF 128 SF 107 SF 14 SF 298 SF 649 SF 46 SF 33 SF 62 SF 790 SF 132 SF 131 SF
A.1M A.1M TOTAL A.2 A.2 A.2 A.2 A.2 A.2 A.2 A.2 A.2 A.2	LEVEL 1 LEVEL 1 LEVEL 1 LEVEL 1 LEVEL 2 LEVEL 2 LEVEL 2 LEVEL 2 LEVEL 3 LEVEL 3 LEVEL 3	BATH FLEX MUDROOM/ENTRY CLOSET LIVING / DINING / KITCHEN PANTRY POWDER OFFICE BED 2 BED 3 W/D	1,914 3 49 SF 128 SF 107 SF 14 SF 298 SF 649 SF 46 SF 33 SF 62 SF 790 SF 132 SF 131 SF 25 SF
A.1M A.1M TOTAL A.2 A.2 A.2 A.2 A.2 A.2 A.2 A.2 A.2 A.2	LEVEL 1 LEVEL 1 LEVEL 1 LEVEL 1 LEVEL 2 LEVEL 2 LEVEL 2 LEVEL 2 LEVEL 3 LEVEL 3 LEVEL 3 LEVEL 3 LEVEL 3	BATH FLEX MUDROOM/ENTRY CLOSET LIVING / DINING / KITCHEN PANTRY POWDER OFFICE BED 2 BED 3 W/D CLOSET	1,914 3 49 SF 128 SF 107 SF 14 SF 298 SF 649 SF 46 SF 33 SF 62 SF 790 SF 132 SF 131 SF 25 SF 13 SF
A.1M A.1M TOTAL A.2 A.2 A.2 A.2 A.2 A.2 A.2 A.2 A.2 A.2	LEVEL 1 LEVEL 1 LEVEL 1 LEVEL 1 LEVEL 2 LEVEL 2 LEVEL 2 LEVEL 2 LEVEL 3 LEVEL 3 LEVEL 3 LEVEL 3 LEVEL 3 LEVEL 3	BATH FLEX MUDROOM/ENTRY CLOSET LIVING / DINING / KITCHEN PANTRY POWDER OFFICE BED 2 BED 3 W/D CLOSET CLOSET CLOSET BATH	1,914 s 49 SF 128 SF 107 SF 14 SF 298 SF 649 SF 46 SF 33 SF 62 SF 790 SF 131 SF 25 SF 13 SF 13 SF 49 SF
A.1M A.1M TOTAL A.2 A.2 A.2 A.2 A.2 A.2 A.2 A.2 A.2 A.2	LEVEL 1 LEVEL 1 LEVEL 1 LEVEL 1 LEVEL 2 LEVEL 2 LEVEL 2 LEVEL 2 LEVEL 3	BATH FLEX MUDROOM/ENTRY CLOSET LIVING / DINING / KITCHEN PANTRY POWDER OFFICE BED 2 BED 3 W/D CLOSET CLOSET CLOSET BATH PRIMARY CLOSET	1,914 3 49 SF 128 SF 107 SF 14 SF 298 SF 649 SF 46 SF 33 SF 62 SF 790 SF 131 SF 25 SF 13 SF 49 SF 52 SF
A.1M A.1M TOTAL A.2 A.2 A.2 A.2 A.2 A.2 A.2 A.2 A.2 A.2	LEVEL 1 LEVEL 1 LEVEL 1 LEVEL 1 LEVEL 2 LEVEL 2 LEVEL 2 LEVEL 2 LEVEL 3	BATH FLEX MUDROOM/ENTRY CLOSET LIVING / DINING / KITCHEN PANTRY POWDER OFFICE BED 2 BED 3 W/D CLOSET CLOSET CLOSET BATH PRIMARY CLOSET PRIMARY BED	1,914 3 49 SF 128 SF 107 SF 14 SF 298 SF 649 SF 46 SF 33 SF 62 SF 790 SF 131 SF 25 SF 13 SF 13 SF 49 SF 52 SF
A.1M A.1M TOTAL A.2 A.2 A.2 A.2 A.2 A.2 A.2 A.2 A.2 A.2	LEVEL 1 LEVEL 1 LEVEL 1 LEVEL 1 LEVEL 2 LEVEL 2 LEVEL 2 LEVEL 2 LEVEL 3	BATH FLEX MUDROOM/ENTRY CLOSET LIVING / DINING / KITCHEN PANTRY POWDER OFFICE BED 2 BED 3 W/D CLOSET CLOSET CLOSET BATH PRIMARY CLOSET	1,914 3 49 SF 128 SF 107 SF 14 SF 298 SF 649 SF 46 SF 33 SF 62 SF 790 SF 131 SF 25 SF 13 SF 49 SF 52 SF
A.1M A.1M TOTAL A.2 A.2 A.2 A.2 A.2 A.2 A.2 A.2 A.2 A.2	LEVEL 1 LEVEL 1 LEVEL 1 LEVEL 1 LEVEL 2 LEVEL 2 LEVEL 2 LEVEL 2 LEVEL 3	BATH FLEX MUDROOM/ENTRY CLOSET LIVING / DINING / KITCHEN PANTRY POWDER OFFICE BED 2 BED 3 W/D CLOSET CLOSET CLOSET BATH PRIMARY CLOSET PRIMARY BED	1,914 S 49 SF 128 SF 107 SF 14 SF 298 SF 649 SF 46 SF 790 SF 131 SF 25 SF 13 SF 49 SF 49 SF 195 SF
A.1M A.1M TOTAL A.2 A.2 A.2 A.2 A.2 A.2 A.2 A.2 A.2 A.2	LEVEL 1 LEVEL 1 LEVEL 1 LEVEL 1 LEVEL 2 LEVEL 2 LEVEL 2 LEVEL 2 LEVEL 3	BATH FLEX MUDROOM/ENTRY CLOSET LIVING / DINING / KITCHEN PANTRY POWDER OFFICE BED 2 BED 3 W/D CLOSET CLOSET CLOSET BATH PRIMARY CLOSET PRIMARY BED PRIMARY BATH	1,914 S 49 SF 128 SF 107 SF 14 SF 298 SF 649 SF 46 SF 790 SF 132 SF 131 SF 25 SF 13 SF 13 SF 49 SF 52 SF 195 SF
A.1M A.1M TOTAL A.2 A.2 A.2 A.2 A.2 A.2 A.2 A.2 A.2 A.2	LEVEL 1 LEVEL 1 LEVEL 1 LEVEL 1 LEVEL 2 LEVEL 2 LEVEL 2 LEVEL 2 LEVEL 3	BATH FLEX MUDROOM/ENTRY CLOSET LIVING / DINING / KITCHEN PANTRY POWDER OFFICE BED 2 BED 3 W/D CLOSET CLOSET CLOSET BATH PRIMARY CLOSET PRIMARY BED PRIMARY BATH HALLWAY	1,914 3 49 SF 128 SF 107 SF 14 SF 298 SF 649 SF 46 SF 33 SF 62 SF 790 SF 132 SF 131 SF 25 SF 13 SF 49 SF 52 SF 195 SF 83 SF

BLDG 5-PACK

UNIT	LEVEL	NAME	AREA
		10000	1.1127
B.1	LEVEL 1	BATH	43 SF
B.1	LEVEL 1	FLEX	121 SF
B.1	LEVEL 1	MUDROOM/ENTRY	101 SF
B.1	LEVEL 1	CLOSET	12 SF
		1	276 SF
B.1	LEVEL 2	LIVING / DINING / KITCHEN	624 SF
B.1	LEVEL 2	PANTRY	44 SF
B.1	LEVEL 2	POWDER	32 SF
B.1	LEVEL 2	OFFICE	54 SF
			754 SF
B.1	LEVEL 3	BED 2	127 SF
B.1	LEVEL 3	BED 3	127 SF
B.1	LEVEL 3	W/D	25 SF
B.1	LEVEL 3	CLOSET	13 SF
B.1	LEVEL 3	CLOSET	13 SF
B.1	LEVEL 3	BATH	50 SF
B.1	LEVEL 3	PRIMARY CLOSET	50 SF
B.1	LEVEL 3	PRIMARY BED	156 SF
B.1	LEVEL 3	PRIMARY BATH	95 SF
B.1	LEVEL 3	HALLWAY	98 SF
ΤΩΤΔΙ	UNIT B.1	GSE	754 SF
IUIAL	OINII D.I	doi	1,784 S
			1,7010
			1,7010
B.1M	LEVEL 1	ВАТН	43 SF
	LEVEL 1 LEVEL 1	BATH FLEX	
B.1M			43 SF
B.1M B.1M	LEVEL 1	FLEX	43 SF 121 SF
B.1M B.1M	LEVEL 1	FLEX MUDROOM/ENTRY	43 SF 121 SF 101 SF
B.1M B.1M B.1M B.1M	LEVEL 1 LEVEL 1 LEVEL 1	FLEX MUDROOM/ENTRY	43 SF 121 SF 101 SF 12 SF 276 SF 624 SF
B.1M B.1M B.1M B.1M B.1M	LEVEL 1 LEVEL 1 LEVEL 1 LEVEL 2 LEVEL 2	FLEX MUDROOM/ENTRY CLOSET LIVING / DINING / KITCHEN PANTRY	43 SF 121 SF 101 SF 12 SF 276 SF 624 SF 44 SF
B.1M B.1M B.1M B.1M B.1M	LEVEL 1 LEVEL 1 LEVEL 1	FLEX MUDROOM/ENTRY CLOSET LIVING / DINING / KITCHEN	43 SF 121 SF 101 SF 12 SF 276 SF 624 SF
B.1M B.1M B.1M B.1M B.1M B.1M	LEVEL 1 LEVEL 1 LEVEL 1 LEVEL 2 LEVEL 2	FLEX MUDROOM/ENTRY CLOSET LIVING / DINING / KITCHEN PANTRY	43 SF 121 SF 101 SF 12 SF 276 SF 624 SF 44 SF 32 SF 54 SF
B.1M B.1M B.1M B.1M B.1M B.1M B.1M	LEVEL 1 LEVEL 1 LEVEL 1 LEVEL 2 LEVEL 2 LEVEL 2 LEVEL 2	FLEX MUDROOM/ENTRY CLOSET LIVING / DINING / KITCHEN PANTRY POWDER	43 SF 121 SF 101 SF 12 SF 276 SF 624 SF 44 SF 32 SF
B.1M B.1M B.1M B.1M B.1M B.1M B.1M	LEVEL 1 LEVEL 1 LEVEL 2 LEVEL 2 LEVEL 2 LEVEL 2 LEVEL 3	FLEX MUDROOM/ENTRY CLOSET LIVING / DINING / KITCHEN PANTRY POWDER OFFICE BED 2	43 SF 121 SF 101 SF 12 SF 276 SF 624 SF 44 SF 32 SF 54 SF 754 SF 127 SF
B.1M B.1M B.1M B.1M B.1M B.1M B.1M B.1M	LEVEL 1 LEVEL 1 LEVEL 2 LEVEL 2 LEVEL 2 LEVEL 2 LEVEL 3 LEVEL 3	FLEX MUDROOM/ENTRY CLOSET LIVING / DINING / KITCHEN PANTRY POWDER OFFICE BED 2 BED 3	43 SF 121 SF 101 SF 12 SF 276 SF 624 SF 44 SF 32 SF 54 SF 754 SF 127 SF
B.1M B.1M B.1M B.1M B.1M B.1M B.1M B.1M	LEVEL 1 LEVEL 1 LEVEL 2 LEVEL 2 LEVEL 2 LEVEL 2 LEVEL 3 LEVEL 3 LEVEL 3	FLEX MUDROOM/ENTRY CLOSET LIVING / DINING / KITCHEN PANTRY POWDER OFFICE BED 2 BED 3 W/D	43 SF 121 SF 101 SF 12 SF 276 SF 624 SF 44 SF 32 SF 54 SF 754 SF 127 SF 127 SF 25 SF
B.1M B.1M B.1M B.1M B.1M B.1M B.1M B.1M	LEVEL 1 LEVEL 1 LEVEL 2 LEVEL 2 LEVEL 2 LEVEL 2 LEVEL 3 LEVEL 3 LEVEL 3 LEVEL 3	FLEX MUDROOM/ENTRY CLOSET LIVING / DINING / KITCHEN PANTRY POWDER OFFICE BED 2 BED 3 W/D CLOSET	43 SF 121 SF 101 SF 12 SF 276 SF 624 SF 44 SF 32 SF 54 SF 754 SF 127 SF 127 SF 25 SF 13 SF
B.1M B.1M B.1M B.1M B.1M B.1M B.1M B.1M	LEVEL 1 LEVEL 1 LEVEL 2 LEVEL 2 LEVEL 2 LEVEL 3 LEVEL 3 LEVEL 3 LEVEL 3 LEVEL 3 LEVEL 3	FLEX MUDROOM/ENTRY CLOSET LIVING / DINING / KITCHEN PANTRY POWDER OFFICE BED 2 BED 3 W/D	43 SF 121 SF 101 SF 12 SF 276 SF 624 SF 44 SF 32 SF 54 SF 754 SF 127 SF 127 SF 13 SF 13 SF
B.1M B.1M B.1M B.1M B.1M B.1M B.1M B.1M	LEVEL 1 LEVEL 1 LEVEL 2 LEVEL 2 LEVEL 2 LEVEL 3	FLEX MUDROOM/ENTRY CLOSET LIVING / DINING / KITCHEN PANTRY POWDER OFFICE BED 2 BED 3 W/D CLOSET	43 SF 121 SF 101 SF 12 SF 276 SF 624 SF 44 SF 32 SF 54 SF 754 SF 127 SF 127 SF 125 SF 13 SF 13 SF 50 SF
B.1M B.1M B.1M B.1M B.1M B.1M B.1M B.1M	LEVEL 1 LEVEL 1 LEVEL 2 LEVEL 2 LEVEL 2 LEVEL 2 LEVEL 3	FLEX MUDROOM/ENTRY CLOSET LIVING / DINING / KITCHEN PANTRY POWDER OFFICE BED 2 BED 3 W/D CLOSET CLOSET	43 SF 121 SF 101 SF 12 SF 276 SF 624 SF 44 SF 32 SF 54 SF 754 SF 127 SF 127 SF 127 SF 13 SF 13 SF 50 SF 50 SF
B.1M B.1M B.1M B.1M B.1M B.1M B.1M B.1M	LEVEL 1 LEVEL 1 LEVEL 2 LEVEL 2 LEVEL 2 LEVEL 3	FLEX MUDROOM/ENTRY CLOSET LIVING / DINING / KITCHEN PANTRY POWDER OFFICE BED 2 BED 3 W/D CLOSET CLOSET BATH PRIMARY CLOSET PRIMARY BED	43 SF 121 SF 101 SF 12 SF 276 SF 624 SF 44 SF 32 SF 54 SF 754 SF 127 SF 127 SF 13 SF 13 SF 50 SF 50 SF
B.1M B.1M B.1M B.1M B.1M B.1M B.1M B.1M	LEVEL 1 LEVEL 1 LEVEL 2 LEVEL 2 LEVEL 2 LEVEL 2 LEVEL 3	FLEX MUDROOM/ENTRY CLOSET LIVING / DINING / KITCHEN PANTRY POWDER OFFICE BED 2 BED 3 W/D CLOSET CLOSET BATH PRIMARY CLOSET PRIMARY BED	43 SF 121 SF 101 SF 12 SF 276 SF 624 SF 44 SF 32 SF 54 SF 754 SF 127 SF 127 SF 127 SF 13 SF 13 SF 50 SF 50 SF
B.1M B.1M B.1M B.1M B.1M B.1M B.1M B.1M	LEVEL 1 LEVEL 1 LEVEL 2 LEVEL 2 LEVEL 2 LEVEL 3	FLEX MUDROOM/ENTRY CLOSET LIVING / DINING / KITCHEN PANTRY POWDER OFFICE BED 2 BED 3 W/D CLOSET CLOSET CLOSET BATH PRIMARY CLOSET PRIMARY BED PRIMARY BATH	43 SF 121 SF 101 SF 12 SF 276 SF 624 SF 44 SF 32 SF 54 SF 754 SF 127 SF 127 SF 13 SF 13 SF 50 SF 50 SF
B.1M B.1M B.1M B.1M B.1M B.1M B.1M B.1M	LEVEL 1 LEVEL 2 LEVEL 2 LEVEL 2 LEVEL 2 LEVEL 3	FLEX MUDROOM/ENTRY CLOSET LIVING / DINING / KITCHEN PANTRY POWDER OFFICE BED 2 BED 3 W/D CLOSET CLOSET CLOSET BATH PRIMARY CLOSET PRIMARY BED PRIMARY BATH HALLWAY	43 SF 121 SF 101 SF 12 SF 276 SF 624 SF 44 SF 32 SF 54 SF 754 SF 127 SF 127 SF 13 SF 13 SF 50 SF 50 SF 55 SF
B.1M B.1M B.1M B.1M B.1M B.1M B.1M B.1M	LEVEL 1 LEVEL 1 LEVEL 2 LEVEL 2 LEVEL 2 LEVEL 3	FLEX MUDROOM/ENTRY CLOSET LIVING / DINING / KITCHEN PANTRY POWDER OFFICE BED 2 BED 3 W/D CLOSET CLOSET CLOSET BATH PRIMARY CLOSET PRIMARY BED PRIMARY BATH HALLWAY	43 SF 121 SF 101 SF 12 SF 276 SF 624 SF 44 SF 32 SF 54 SF 754 SF 127 SF 127 SF 13 SF 13 SF 50 SF 50 SF 156 SF 95 SF

UNIT	LEVEL	NAME	AREA
O.III		TO THE STATE OF TH	711127
B.1	LEVEL 1	BATH	43 SF
B.1	LEVEL 1	FLEX	121 SF
B.1	LEVEL 1	MUDROOM/ENTRY	101 SF
B.1	LEVEL 1	CLOSET	12 SF
		19292.	276 SF
B.1	LEVEL 2	LIVING / DINING / KITCHEN	624 SF
B.1	LEVEL 2	PANTRY	44 SF
B.1	LEVEL 2	POWDER	32 SF
B.1	LEVEL 2	OFFICE	54 SF
		1-11-1-1	754 SF
B.1	LEVEL 3	BED 2	127 SF
B.1	LEVEL 3	BED 3	127 SF
B.1	LEVEL 3	W/D	25 SF
B.1	LEVEL 3	CLOSET	13 SF
B.1	LEVEL 3	CLOSET	13 SF
B.1	LEVEL 3	BATH	50 SF
B.1	LEVEL 3	PRIMARY CLOSET	50 SF
B.1	LEVEL 3	PRIMARY BED	156 SF
B.1	LEVEL 3	PRIMARY BATH	95 SF
B.1	LEVEL 3	HALLWAY	98 SF
			754 SF
TUTAL	UNIT B.1	G5F	1,784 S
B.1M	LEVEL 1	BATH	43 SF
B.1M	LEVEL 1	FLEX	121 SF
B.1M	LEVEL 1	MUDROOM/ENTRY	101 SF
B.1M	LEVEL 1	CLOSET	12 SF
			276 SF
B.1M	LEVEL 2	LIVING / DINING / KITCHEN	624 SF
B.1M	LEVEL 2	PANTRY	44 SF
B.1M	LEVEL 2	POWDER	32 SF
B.1M	LEVEL 2	OFFICE	54 SF
			754 SF
B.1M	LEVEL 3	BED 2	127 SF
B.1M	LEVEL 3	BED 3	127 SF
B.1M	LEVEL 3	W/D	25 SF
B.1M	LEVEL 3	CLOSET	13 SF
B.1M	LEVEL 3	CLOSET	13 SF
B.1M	LEVEL 3	BATH	50 SF
B.1M	LEVEL 3	PRIMARY CLOSET	50 SF
B.1M	LEVEL 3	PRIMARY BED	156 SF
B.1M	LEVEL 3	PRIMARY BATH	95 SF
B.1M	LEVEL 3	HALLWAY	98 SF
TOTAL	LINIT R 1	M CCE	754 SF

FAR CALCULATION SUMMARY

179,130 SF X 0.75 = **134,347 SF**

126,989 / 179,130 SF = **0.71**

EXCLUDING STRUCTURED PARKING, MECHANICAL EQUIPMENT ROOMS AND ELEVATOR SHAFTS, DIVIDED BY LOT AREA.

UNHEATED AREA THAT IS WITHIN OR COVERED BY A STRUCTURE OR PORTION OF A STRUCTURE SHALL BE EXCLUDED

QUANTITY

TOTAL

3,744 SF

59,160 SF

46,365 SF

17,720 SF

126,989 SF

PER BMC DEFINITION OF GROSS FLOOR AREA. THE GROSS FLOOR AREA DIMENSIONS PROVIDED ARE MEASURED TO

FLOOR AREA RATIO (FAR) IS CALCULATED AS THE GROSS SQUARE FOOTAGE OF USABLE SPACE IN A BUILDING,

WHOLE BUILDING GSF (HEATED AREA)

3,744 SF

7,395 SF

9,273 SF

4,430 SF

179,130 SF

IN GROSS FLOOR AREA CALCULATION (GARAGE, EXTERIOR DECK, PORCH ETC.)

GROSS FLOOR AREA

THE OUTSIDE FACE OF STUDS OF THE EXTERIOR WALLS

PER BMC 20.28.140.C BULK AND MASSING

TOTAL FAR PERMITTED

PERMITTED GROSS FLOOR AREA

PROPOSED GROSS FLOOR AREA

PROPOSED FLOOR AREA RATIO

LOT AREA


2 PACK A-B

4 PACK A-B-A-B

5 PACK A-B-A-B-A

PATIO HOME C-C


TOTAL SITE GROSS FLOOR AREA

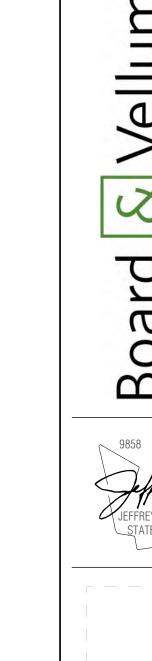

LEGEND

PROPOSED CONDITIONED SPACE

PROPOSED UNCONDITIONED SPACE

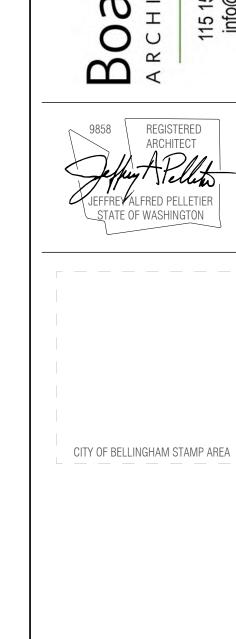

BELLINGHAM MES STREAM B TOWNHON

REVISION DATE DESCRIPTION

ISSUANCES

DATE DESCRIPTION 7/29/2022 LAND USE APPLICATION

1/13/2023 LAND USE APP RESUBMITTAL 4/14/2023 LAND USE APP RESUBMITTAL

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BOARD & VELLUM PROJECT #: 2021170.00 COB PROJECT #: 2021-0105

PLOT DATE: 04.12.2023

FAR CALCULATION

SHEET NO.:



TOTAL UNIT B.2 GSF TOTAL 4-PACK GSF

TOTAL 4-PACK GSF

UNIT	LEVEL	AREA
C.1	LEVEL 1	1,389 SF
C.1	LEVEL 2	826 SF
		2,215 SF
C.1M	LEVEL 1	1,389 SF
C.1M	LEVEL 2	826 SF
		2,215 SF
TOTAL PATIO H	HOME GSF	4,430 SF

Б	LUG Z	2-PACK
UNIT	LEVEL	AREA
A.1	LEVEL 1	303 SF
A.1	LEVEL 2	807 SF
A.1	LEVEL 3	807 SF
		1,916 SF
B.2	LEVEL 1	285 SF
B.2	LEVEL 2	770 SF
B.2	LEVEL 3	773 SF

TOTAL 2-PACK GSF

1,827 SF

3,744 SF

UNIT	LEVEL	AREA
A.1	LEVEL 1	298 SF
A.1	LEVEL 2	807 SF
A.1	LEVEL 3	807 SF
		1,911 SF
A.2M	LEVEL 1	297 SF
A.2M	LEVEL 2	790 SF
A.2M	LEVEL 3	790 SF
		1,877 SF
B.1M	LEVEL 1	279 SF
B.1M	LEVEL 2	754 SF
B.1M	LEVEL 3	754 SF
		1,786 SF
B.2	LEVEL 1	282 SF
B.2	LEVEL 2	770 SF
B.2	LEVEL 3	770 SF
		1,821 SF

7,395 SF

ACK	В	LDG 5	-PA
AREA	UNIT	LEVEL	
	A.1	LEVEL 1	301 SF
	A.1	LEVEL 2	807 SF
	A.1	LEVEL 3	807 SF
)F			1,914 S
	A.1M	LEVEL 1	301 SF
	A.1M	LEVEL 2	807 SF
	A.1M	LEVEL 3	807 SF
SF	[,		1,914 S
	A.2	LEVEL 1	298 SF
	A.2	LEVEL 2	790 SF
	A.2	LEVEL 3	790 SF
SF .		•	1,878 S
	B.1	LEVEL 1	276 SF
	B.1	LEVEL 2	754 SF
	B.1	LEVEL 3	754 SF
 }F		,	1.784 S

TOTAL 5-PACK GSF

1,821 SF

7,395 SF

A.1	LEVEL 1	301 SF	
A.1	LEVEL 2	807 SF	
A.1	LEVEL 3	807 SF	
		1,914 SF	
A.1M	LEVEL 1	301 SF	
A.1M	LEVEL 2	807 SF	
A.1M	LEVEL 3	807 SF	
		1,914 SF	
A.2	LEVEL 1	298 SF	
A.2	LEVEL 2	790 SF	
A.2	LEVEL 3	790 SF	
		1,878 SF	
B.1	LEVEL 1	276 SF	
B.1	LEVEL 2	754 SF	
D 1	1.57.451.0	75405	

		1,878 SF
B.1	LEVEL 1	276 SF
B.1	LEVEL 2	754 SF
B.1	LEVEL 3	754 SF
		1,784 SF
B.1M	LEVEL 1	276 SF
B.1M	LEVEL 2	754 SF
B.1M	LEVEL 3	754 SF
		1,784 SF

ASSESSOR PARCEL NO:

APN 380213 546133 000 LEGAL DESCRIPTION: PER CHICAGO TITLE COMPANY ORDER NO. 245444100 UPDATE #3 COMMITMENT DATE: SEPTEMBER 27, 2022.

> LOT 2, AS DELINEATED ON BG & CC SHORT PLAT, ACCORDING TO THE PLAT THEREOF, RECORDED UNDER AUDITOR'S FILE NO. 2022-0800206, RECORDS OF WHATCOM COUNTY, WASHINGTON.

> > SITUATE IN WHATCOM COUNTY, WASHINGTON.

DEMO SITE PLAN KEY

PROPERTY LINE

GENERAL NOTES - SITE PLAN

1. SITE INFORMATION CONTAINED HEREIN IS BASED ON A SURVEY BY LAND DEVELOPMENT ENGINEERING & SURVEYING,

2. INSTALLATION OF EROSION CONTROL MEASURES IS REQUIRED PRIOR TO ANY GROUND DISTURBANCE PER CIVIL

3. CONTRACTOR IS RESPONSIBLE FOR SCHEDULING A "FIRST GROUND DISTURBANCE INSPECTION" AFTER THE BUILDING PERMIT IS ISSUED TO MEET WITH THE SITE INSPECTOR.

REFER TO CIVIL FOR ALL WORK PROPOSED IN THE RIGHT OF WAY.
 REFER TO LANDSCAPE FOR TREE PRESERVATION AND RETENTION PLAN.

CITY OF BELLINGHAM STAMP AREA

SITE BELLINGHAM STREAM

REVISION DATE DESCRIPTION

ISSUANCES

DATE DESCRIPTION

7/29/2022 LAND USE APPLICATION 1/13/2023 LAND USE APP RESUBMITTAL 4/14/2023 LAND USE APP RESUBMITTAL

2021-0105

04.12.2023


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PLOT DATE:

COB PROJECT #:

DEMOLITION SITE PLAN

SHEET NO.:

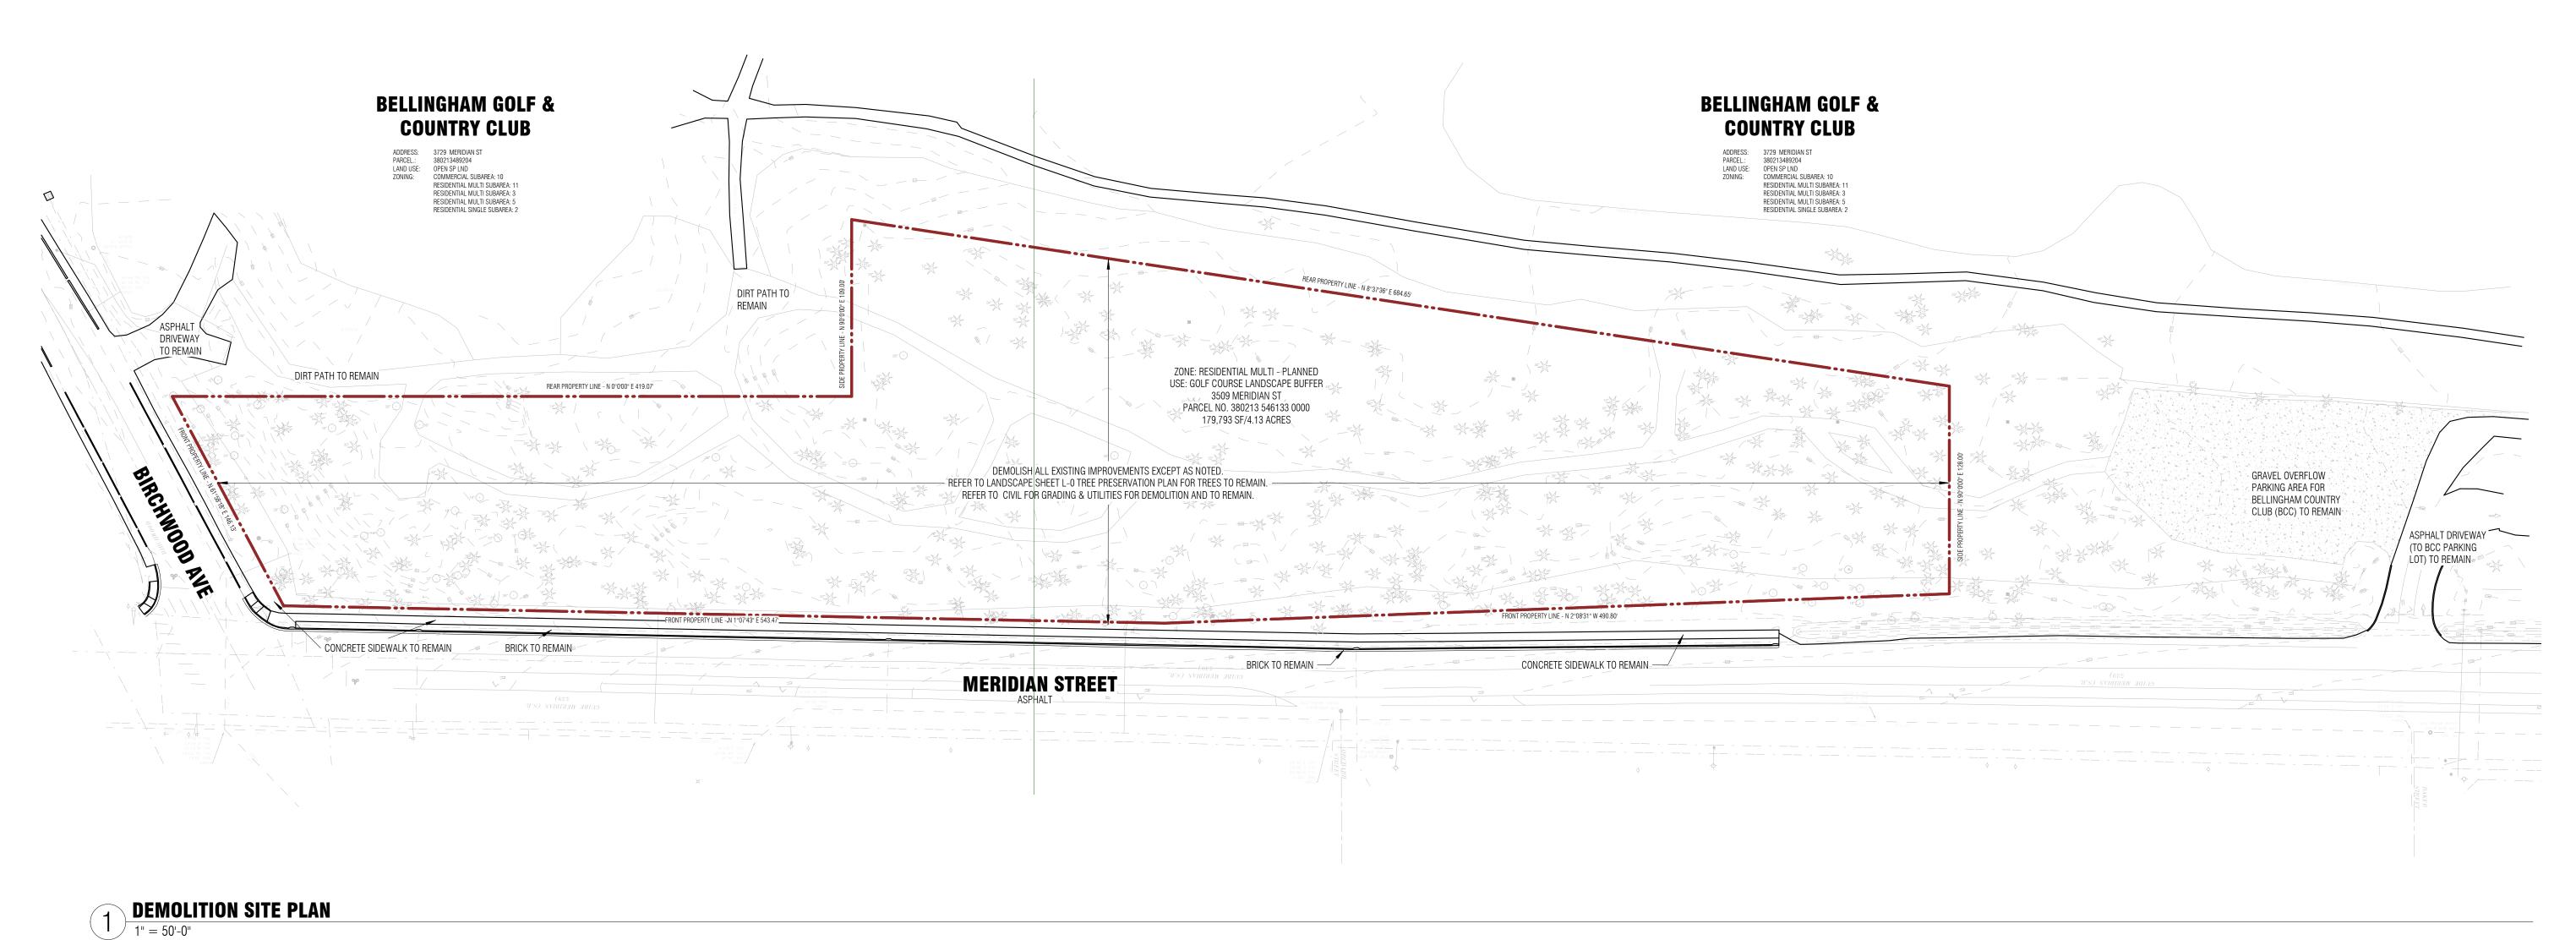


GENERAL NOTES - SITE PLAN

- 1. SITE INFORMATION CONTAINED HEREIN IS BASED ON A SURVEY BY LAND DEVELOPMENT ENGINEERING & SURVEYING, DATED 02/02/2022, GATHERED BY FIELD TRAVERSE UTILIZING ELECTRONIC DATA COLLECTION IN APRIL, MAY, & OCTOBER,
- 2. INSTALLATION OF EROSION CONTROL MEASURES IS REQUIRED PRIOR TO ANY GROUND DISTURBANCE PER CIVIL
- 3. CONTRACTOR IS RESPONSIBLE FOR SCHEDULING A "FIRST GROUND DISTURBANCE INSPECTION" AFTER THE BUILDING
- PERMIT IS ISSUED TO MEET WITH THE SITE INSPECTOR. 4. REFER TO CIVIL FOR ALL WORK PROPOSED IN THE RIGHT OF WAY.

 5. REFER TO LANDSCAPE FOR TREE PRESERVATION AND RETENTION PLAN.

SITE PLAN KEY

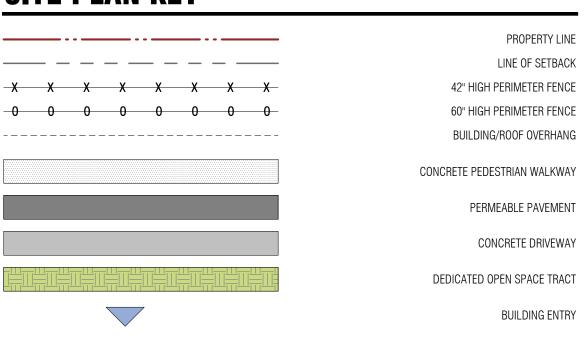

GARAGE ENTRY



SITE PLAN SHEET NO.:

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2021-0105

04.12.2023

COB PROJECT #:

PLOT DATE:

CITY OF BELLINGHAM STAMP AREA

SITE

ELLINGHAM

 $\overline{\mathbf{\omega}}$

STREAM

REVISION DATE

ISSUANCES

DATE DESCRIPTION

7/29/2022 LAND USE APPLICATION

1/13/2023 LAND USE APP RESUBMITTAL 4/14/2023 LAND USE APP RESUBMITTAL

DESCRIPTION

PROPOSED ARCHITECTURAL SITE PLAN

1 EAST SITE ELEVATION - NORTH

1/16" = 1'-0"



2 EAST SITE ELEVATION - CENTRAL 1/16" = 1'-0"




3 EAST SITE ELEVATION - SOUTH 1/16" = 1'-0"



EAST SITE ELEVATION - OVERALL

1" = 40'-0"

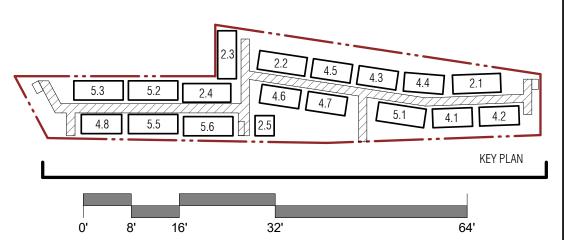

Board & Vellur

ARCHITECTURE AND DESIGN 115 15th Ave E. Suite 100 Seattle, WA 98112 info@boardandvellum.com | 206.707.8895

9858

REGISTERED
ARCHITECT

JEFFREV ALFRED PELLETIER
STATE OF WASHINGTON

CITY OF BELLINGHAM STAMP AREA

CITY OF BELLINGHAM STAMP A

STREAM BELLINGHAM - SITE PROJECT ADDRESS: 3509 MERIDIAN STREET, BELLINGHAM, WA 98225

PROJECT ADI
3509 MERIDIA
OWNER:

DESCRIPTION

REVISION DATE

ISSUANCES

DATE DESCRIPTION

7/29/2022 LAND USE APPLICATION
1/13/2023 LAND USE APP RESUBMITTAL
4/14/2023 LAND USE APP RESUBMITTAL

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ORIGINAL SHEET SIZE IS 22"x34"

BOARD & VELLUM PROJECT #: 2021170
COB PROJECT #: 2021-0

04.12.2023

PLOT DATE:

SITE ELEVATIONS

A1.31



WEST SITE ELEVATION - NORTH

1/16" = 1'-0"



WEST SITE ELEVATION - CENTRAL

1/16" = 1'-0"




3 WEST SITE ELEVATION - SOUTH 1/16" = 1'-0"



WEST SITE ELEVATION - OVERALL

1" = 40'-0"

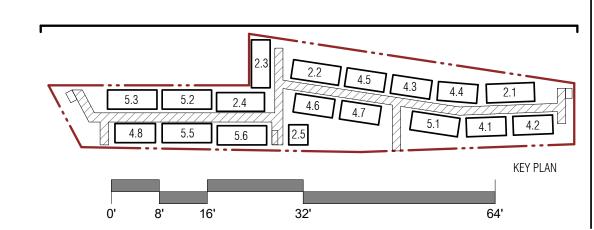

Board

CITY OF BELLINGHAM STAMP AREA

SITE BELLINGHAM

STREAM

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BOARD & VELLUM PROJECT #: 2021170.00 COB PROJECT #: 2021-0105

PLOT DATE:

SITE ELEVATIONS


04.12.2023



PERSPECTIVE LOOKING SOUTH FROM DEVELOPMENT ENTRY ON MERIDIAN



PERSPECTIVE LOOKING SOUTH FROM GOLF COURSE TOWARD BLDGS 2.3 AND 2.4

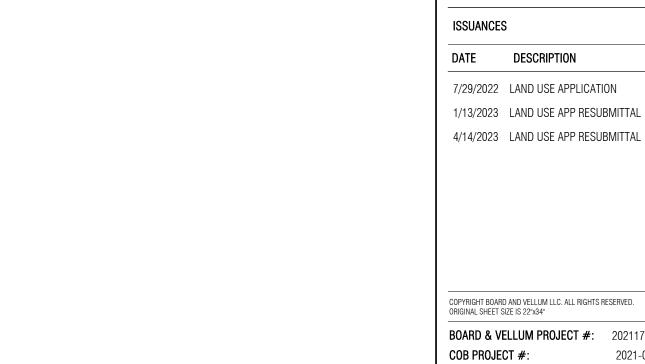

KEY PLAN

SITE PERSPECTIVES

04.12.2023

CITY OF BELLINGHAM STAMP AREA

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PERSPECTIVE AT 5-HOME BUILDINGS FRONTING MERIDIAN AVENUE



PERSPECTIVE AT 4-HOME BUILDINGS FRONTING MERIDIAN AVENUE



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COB PROJECT #:

PLOT DATE:

04.12.2023

SITE PERSPECTIVES

SOLID WASTE ENCLOSURE				
LOCATION	CAPACITY	BUILDING	NO. OF UNITS	
CONSOLIDATED GARBAGE/RECYCLING ENCLOSURE #1	2-YD GARBAGE 3-YD GARBAGE 4-YD CARDBOARD 5 90 GAL PAPER 5 90 GAL BOTTLE / CAN 3 60 GAL F+	2.1, 4.1, 4.2, 4.3, 4.4, 5.1	23	
CONSOLIDATED GARBAGE/RECYCLING ENCLOSURE #2	4-YD GARBAGE 4-YD CARDBOARD 4 90 GAL PAPER 4 90 GAL BOTTLE / CAN 3 60 GAL F+	2.2, 2.3, 2.5, 4.5, 4.6, 4.7	18	
CONSOLIDATED GARBAGE/RECYCLING ENCLOSURE #3	3-YD GARBAGE 3-YD GARBAGE 3-YD CARDBOARD 6 90 GAL PAPER 6 90 GAL BOTTLE / CAN 4 60 GAL F+	2.4, 5.2, 5.3, 5.4, 5.5, 5.6	27	

68 (TOTAL)

<u>NOTE:</u> REFER TO SITE PLAN A1.11 FOR BUILDING NUMBER DESIGNATION.

16' - 0" 5' - 4" 90 GAL
TOTER
BOTTLE/
CAN

90 GAL
TOTER
TOTER
TOTER
BOTTLE/
CAN


90 GAL
TOTER
TOTER
TOTER
BOTTLE/
CAN

CAN

90 GAL
TOTER
TOTER
BOTTLE/
CAN
CAN

CAN 90 GAL TOTER PAPER 2-YD DUMPSTER GARBAGE 3-YD DUMPSTER GARBAGE 60 GAL 60 GAL TOTER TOTER F+ F+ F+ A1.51 1 3-YD DUMPSTER CARDBOARD 90 GAL 90 GAL 90 GAL TOTER TOTER PAPER PAPER PAPER PAPER FULL GATE SWING OPENS FLUSH TO ENCLOSURE - ALLOWS BINS TO BE MANUEVERED OUT, TYP. 5' - 3" 5' - 3" TENANT ACCESS - 40" CLEAR FULL GATE SWING 16' - 0" OPENS FLUSH TO ENCLOSURE ——— A1.51



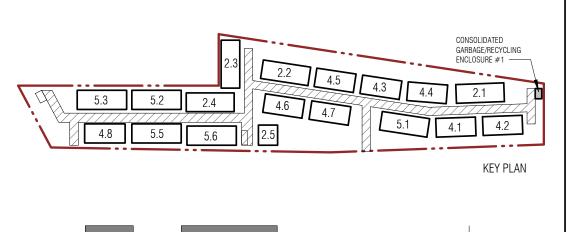

Board & Vellur ARCHITECTURE AND DESIGN 115 15th Ave E. Suite 100 Seattle, WA 98112 info@boardandvellum.com | 206.707.8895

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JEFFREY ALFRED PELLETIER
STATE OF WASHINGTON

CITY OF BELLINGHAM STAMP AREA

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9 MERIDIAN STREET, BELLINGHAM, WA 98225
NER:

STREAM REAL ESTATE

SOUNNER:
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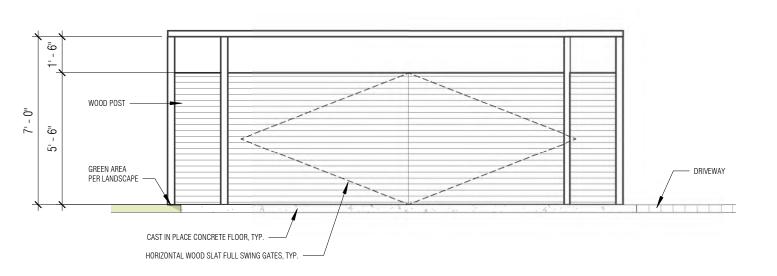
PLOT DATE: 04.12.2023

CONSOLIDATED

GARBAGE/RECYCLING


ENCLOSURE #1
SHEET NO.:

A1.5




CONSOLIDATED GARBAGE/RECYCLING ENCLOSURE #1 - W ELEVATION

1/4" = 1'-0"

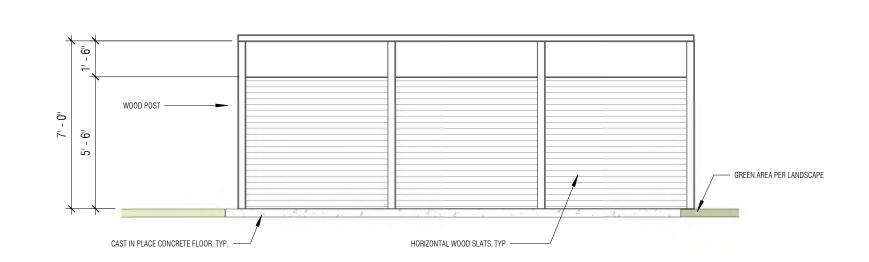


CONSOLIDATED GARBAGE/RECYCLING ENCLOSURE #1 - E ELEVATION

1/4" = 1'-0"

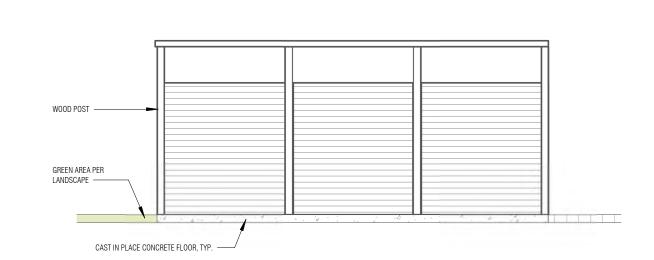

CONSOLIDATED GARBAGE/RECYCLINGENCLOSURE #1 - N ELEVATION


1/4" = 1'-0"

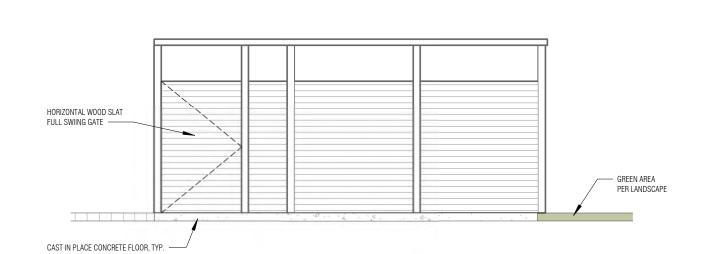


CONSOLIDATED GARBAGE/RECYCLING ENCLOSURE #1 - S ELEVATION 1/4" = 1'-0"

	NCLOSURE		
LOCATION	CAPACITY	BUILDING	NO. OF UNITS
CONSOLIDATED GARBAGE/RECYCLING ENCLOSURE #1	2-YD GARBAGE 3-YD GARBAGE 4-YD CARDBOARD 5 90 GAL PAPER 5 90 GAL BOTTLE / CAN 3 60 GAL F+	2.1, 4.1, 4.2, 4.3, 4.4, 5.1	23
CONSOLIDATED GARBAGE/RECYCLING ENCLOSURE #2	4-YD GARBAGE 4-YD CARDBOARD 4 90 GAL PAPER 4 90 GAL BOTTLE / CAN 3 60 GAL F+	2.2, 2.3, 2.5, 4.5, 4.6, 4.7	18
CONSOLIDATED GARBAGE/RECYCLING ENCLOSURE #3	3-YD GARBAGE 3-YD GARBAGE 3-YD CARDBOARD 6 90 GAL PAPER 6 90 GAL BOTTLE / CAN 4 60 GAL F+	2.4, 5.2, 5.3, 5.4, 5.5, 5.6	27
	,	,	68 (TOTAL)


NOTE: REFER TO SITE PLAN A1.11 FOR BUILDING NUMBER DESIGNATION.

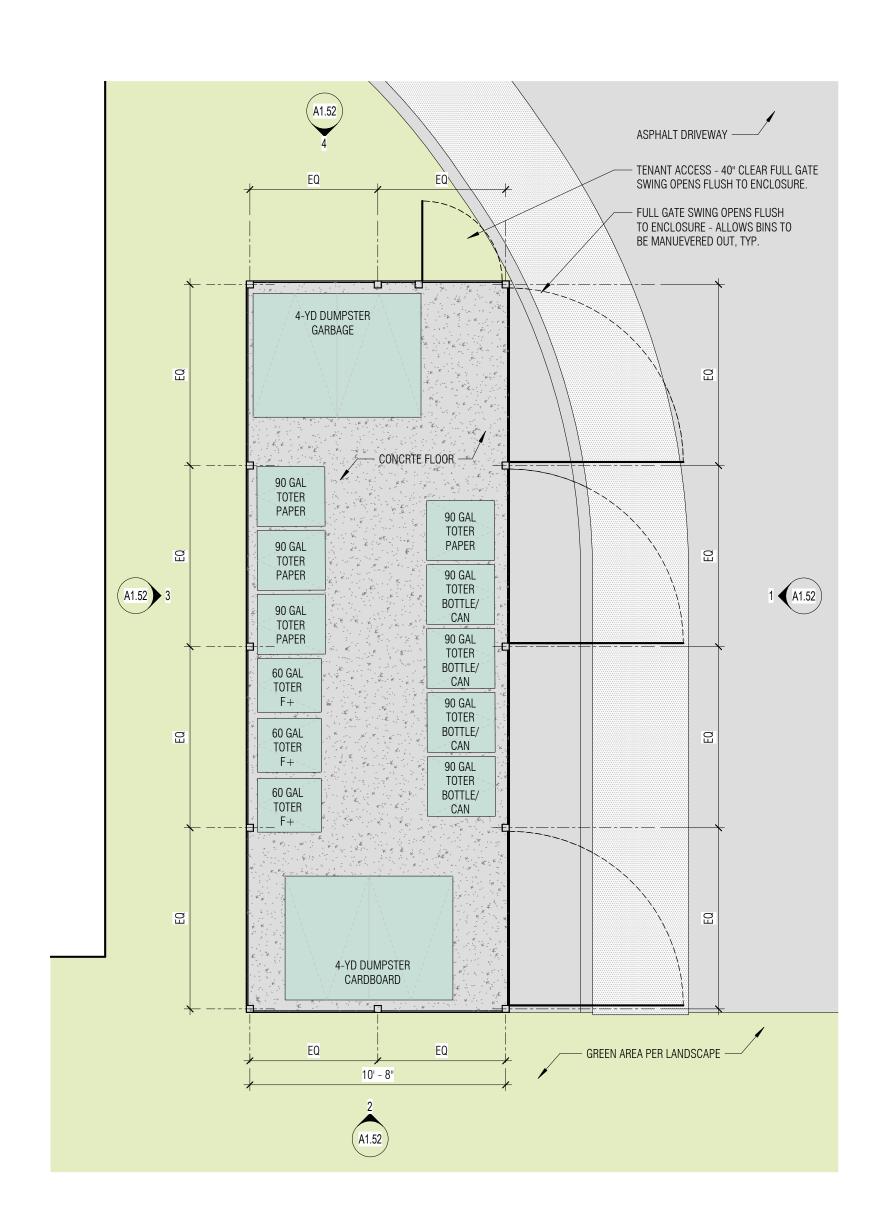

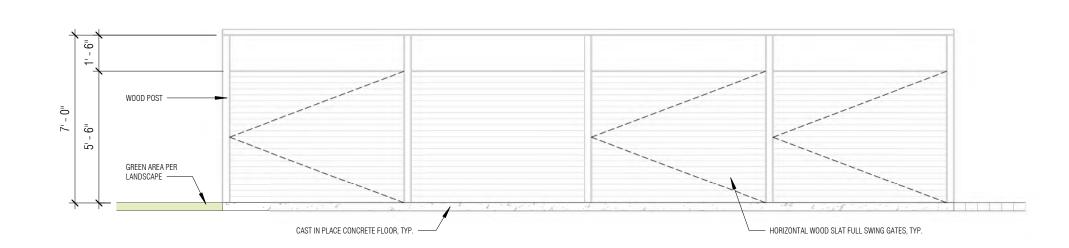


CONSOLIDATED GARBAGE/RECYCLING ENCLOSURE #2 - E ELEVATION

1/4" = 1'-0"

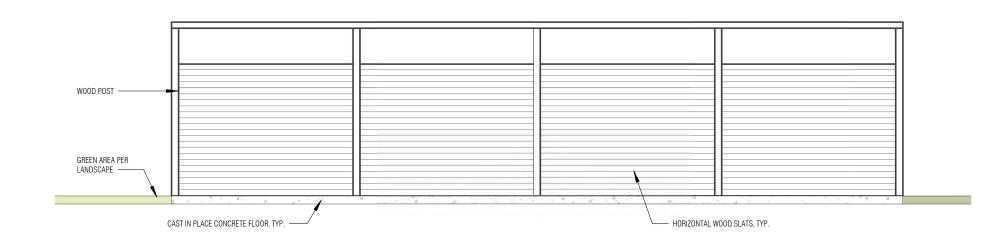


CONSOLIDATED GARBAGE/RECYCLING ENCLOSURE #2 - W ELEVATION

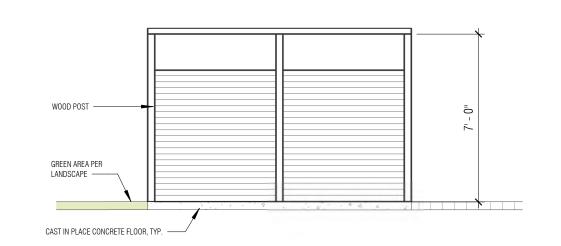


CONSOLIDATED GARBAGE/RECYCLING ENCLOSURE #2 - S ELEVATION

1/4" = 1'-0"

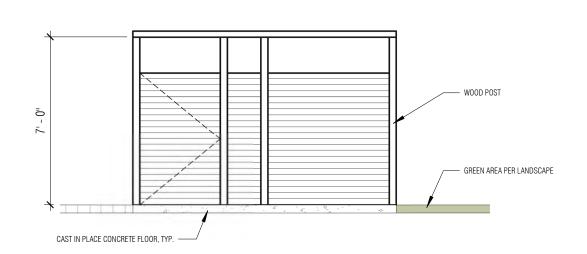

CONSOLIDATED GARBAGE/RECYCLING ENCLOSURE #2 - N ELEVATION 1/4" = 1'-0"



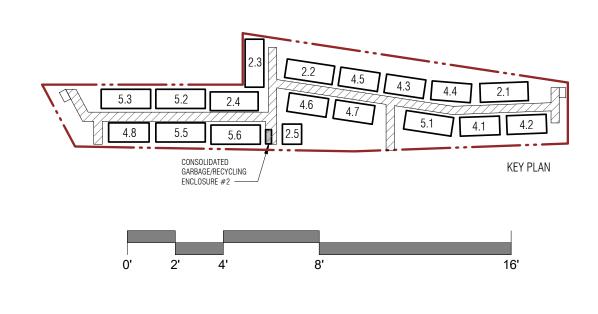

CITY OF BELLINGHAM STAMP AREA

SITE BELLINGHAM

DESCRIPTION

STREAM

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PLOT DATE: 04.12.2023 CONSOLIDATED GARBAGE/RECYCLING ENCLOSURE #2

SHEET NO.:

SOLID WASTE ENCLOSURE				
LOCATION	CAPACITY	BUILDING	NO. OF UNITS	
CONSOLIDATED GARBAGE/RECYCLING ENCLOSURE #1	2-YD GARBAGE 3-YD GARBAGE 4-YD CARDBOARD 5 90 GAL PAPER 5 90 GAL BOTTLE / CAN 3 60 GAL F+	2.1, 4.1, 4.2, 4.3, 4.4, 5.1	23	
CONSOLIDATED GARBAGE/RECYCLING ENCLOSURE #2	4-YD GARBAGE 4-YD CARDBOARD 4 90 GAL PAPER 4 90 GAL BOTTLE / CAN 3 60 GAL F+	2.2, 2.3, 2.5, 4.5, 4.6, 4.7	18	
CONSOLIDATED GARBAGE/RECYCLING ENCLOSURE #3	3-YD GARBAGE 3-YD GARBAGE 3-YD CARDBOARD 6 90 GAL PAPER 6 90 GAL BOTTLE / CAN 4 60 GAL F+	2.4, 5.2, 5.3, 5.4, 5.5, 5.6	27	


NOTE: REFER TO SITE PLAN A1.11 FOR BUILDING NUMBER DESIGNATION.

FULL GATE SWING OPENS FLUSH TO ENCLOSURE - ALLOWS BINS TO BE MANUEVERED OUT, TYP. RETAINING WALL PER LANDSCAPE 90 GAL TOTER BOTTLE/ CAN 90 GAL
TOTER
BOTTLE/
CAN

90 GAL
TOTER
BOTTLE/
CAN

90 GAL
TOTER
BOTTLE/
CAN 90 GAL TOTER BOTTLE/ CAN 3-YD DUMPSTER GARBAGE 3-YD DUMPSTER GARBAGE 4-YD DUMPSTER CARDBOARD A1.53 3 90 GAL TOTER PAPER 90 GAL TOTER PAPER TENANT ACCESS - 40" CLEAR
FULL GATE SWING OPENS
FLUSH TO ENCLOSURE. A1.53

CONSOLIDATED GARBAGE/RECYCLING ENCLOSURE #3

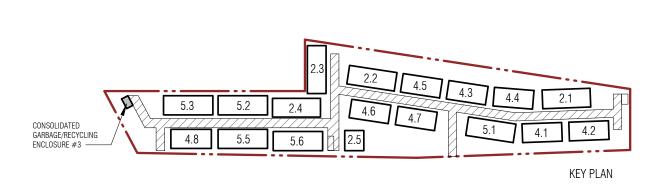

68 (TOTAL)

CITY OF BELLINGHAM STAMP AREA

SITE BELLINGHAM

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COB PROJECT #: 2021-0105


PLOT DATE: 04.12.2023 CONSOLIDATED GARBAGE/RECYCLING ENCLOSURE #3

SHEET NO.:

HORIZONTAL WOOD SLAT FULL SWING GATES, TYP. ——— HORIZONTAL WOOD SLAT, TYP ——


CONSOLIDATED GARBAGE/RECYCLING ENCLOSURE #3 - NE ELEVATION

1/4" = 1'-0"

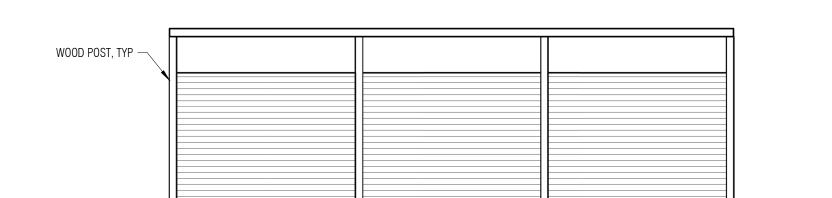


CONSOLIDATED GARBAGE/RECYCLING ENCLOSURE #3 - W ELEVATION

1/4" = 1'-0"

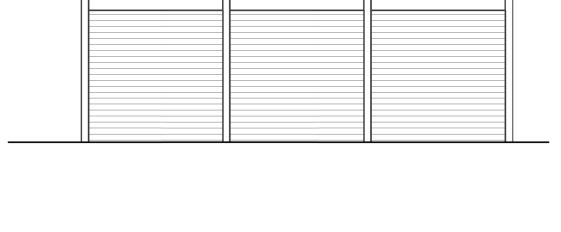


CONSOLIDATED GARBAGE/RECYCLING ENCLOSURE #3 - E ELEVATION

1/4" = 1'-0"

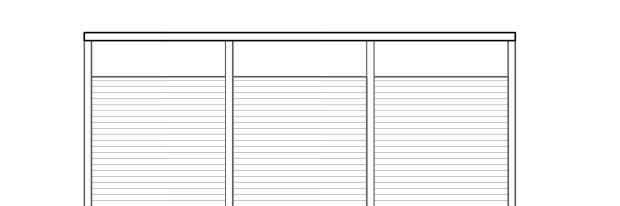

CONSOLIDATED GARBAGE/RECYCLING ENCLOSURE #3- N ELEVATION

1/4" = 1'-0"

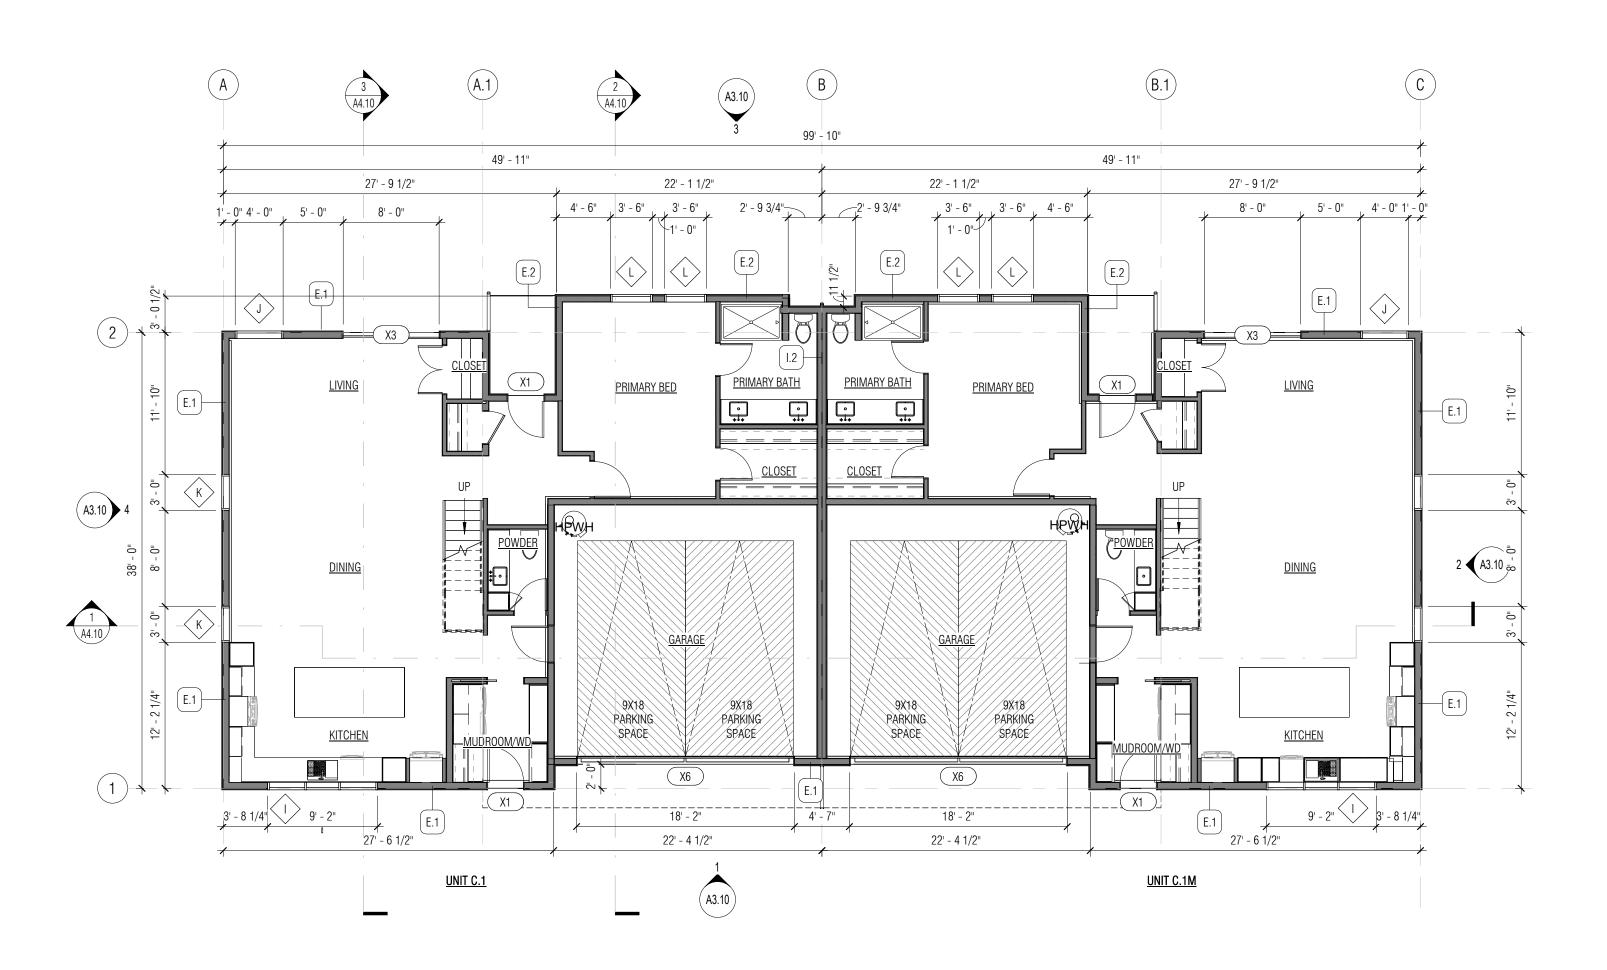

2-PACK TOWNHOUSE (C-C) FLOOR PLAN - LEVEL 1

1/8" = 1'-0"

GENERAL NOTES - FLOOR PLANS


- 1. ALL INTERIOR WALLS ARE I.O UNO. PROVIDE 3-1/2" SOUND INSULATION IN COMMON PARTY WALLS.
- ALL EXTERIOR WALLS ARE E.1 UNO.
 ALL EXTERIOR DIMENSIONS ARE MEASURED FROM GRID LINE TO GRID LINE OR FACE OF FRAMING. ALL INTERIOR
- DIMENSIONS ARE FROM FACE OF STUD.

 4. GRIDS ARE ALIGNED WITH THE EXTERIOR FACE OF FRAMING AT EXTERIOR WALLS AND ALIGNED WITH THE CENTER OF THE PARTY-WALLS.
- 5. DIMENSIONS AT POSTS ARE TO CENTERLINES UNO VERIFY ALL STRUCTURAL LOCATIONS WITH FRAMING PLANS
 6. WINDOW DIMENSIONS ARE GIVEN AS NOMINAL MEASUREMENTS.
 7. DOOR ROUGH OPENINGS ARE 4" OFF STUD FACE OF PERP. WALL (TO HINGED SIDE OF THE DOOR) UNO
 8. ALL FINISH FLOOR MATERIALS TO ALIGN WITH ADJACED OF FINISH

SOLAR READY ZONE

9. SEE GENERAL SHEETS FOR CODE, DIMENSIONING AND GENERAL NOTES 10. SEE SHEETS A5.11 TO A5.14 FOR ENLARGED 1/4" = 1'-0" PLANS

FLOOR PLAN KEY

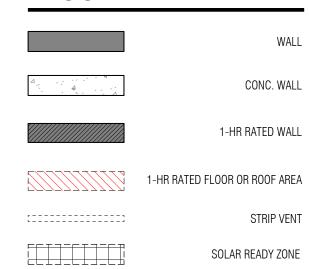



Δ ₹





BELLINGHAM MES STREAM B TOWNHON

REVISION DATE

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COB PROJECT #:

PLOT DATE:

04.12.2023 FLOOR PLANS - FDN & FIRST FLOOR - 2-PACK TH "C-C" UNITS

SHEET NO.:

99' - 10" 2' - 9 3/4" 2' - 9 3/4" 22' - 1" 25' - 0" 47' - 1 1/4" GUARD RAIL PER ELEVATION 10' - 0" 8' - 0" GUTTER PER ELEVATION -**Q** 2 A3.10 4 OPEN TO BELOW OPEN TO BELOW — 2 **A**3.10 A4.10

2'-0" WIDE 1-HR FIRE PROTECTED OVERHANG EACH

SIDE OF COMMON PARTY WALL PER R302.2 - TYP

 $| \langle N \rangle | | \langle M \rangle |$

E.1

8' - 10"

UNIT C.1M

7' - 5 3/4" 5' - 4"

|M|

2' - 6"8" 4' - 6"

E.2

9' - 10"

2-PACK TOWNHOUSE (C-C) FLOOR PLAN - LEVEL 2

1/8" = 1'-0"

1

BED 1

2-PACK TOWNHOUSE (C-C) ROOF PLAN

GENERAL NOTES - FLOOR PLANS

1. ALL INTERIOR WALLS ARE I.O UNO. PROVIDE 3-1/2" SOUND INSULATION IN COMMON PARTY WALLS.

2. ALL EXTERIOR WALLS ARE E.1 UNO. 3. ALL EXTERIOR DIMENSIONS ARE MEASURED FROM GRID LINE TO GRID LINE OR FACE OF FRAMING. ALL INTERIOR

DIMENSIONS ARE FROM FACE OF STUD. 4. GRIDS ARE ALIGNED WITH THE EXTERIOR FACE OF FRAMING AT EXTERIOR WALLS AND ALIGNED WITH THE CENTER OF THE PARTY-WALLS.


5. DIMENSIONS AT POSTS ARE TO CENTERLINES UNO - VERIFY ALL STRUCTURAL LOCATIONS WITH FRAMING PLANS


6. WINDOW DIMENSIONS ARE GIVEN AS NOMINAL MEASUREMENTS.

7. DOOR ROUGH OPENINGS ARE 4" OFF STUD FACE OF PERP. WALL (TO HINGED SIDE OF THE DOOR) UNO 8. ALL FINISH FLOOR MATERIALS TO ALIGN WITH ADJACENT FLOOR FINISH

9. SEE GENERAL SHEETS FOR CODE, DIMENSIONING AND GENERAL NOTES 10. SEE SHEETS A5.11 TO A5.14 FOR ENLARGED 1/4" = 1'-0" PLANS


FLOOR PLAN KEY

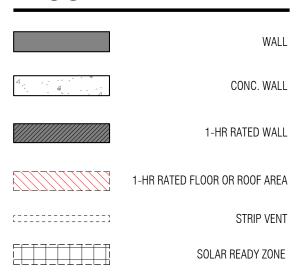

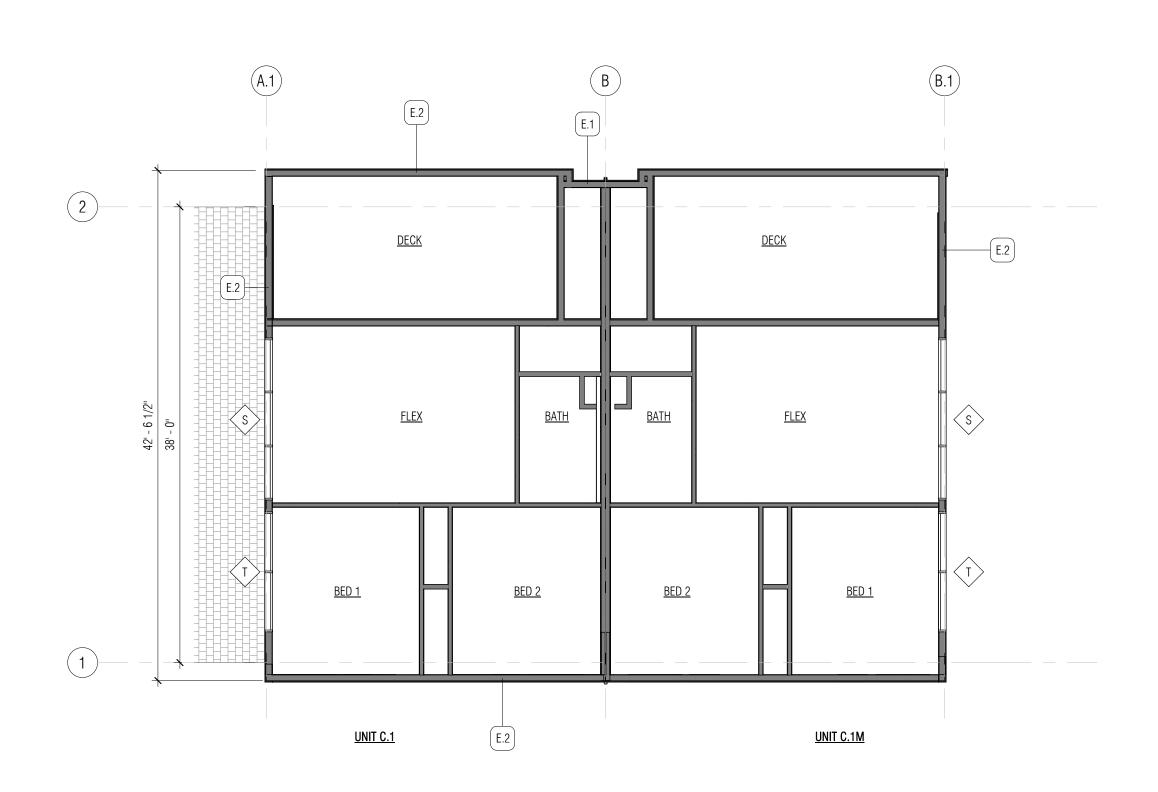

3 2-PACK TOWNHOUSE (C-C) PARTIAL LEVEL 2 PLAN

1/8" = 1'-0"

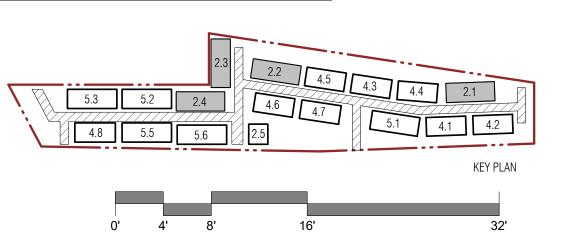

Vellum AND DESIGN

9858 | REGISTERED ARCHITECT

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CITY OF BELLINGHAM STAMP AREA

BELLINGHAM MES STREAM B TOWNHON

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COB PROJECT #: 2021-0105

04.12.2023 PLOT DATE: FLOOR PLANS - SECOND FLOOR & ROOF - 2-PACK TH

"C-C" UNITS

SHEET NO.:


GENERAL NOTES - FLOOR PLANS

- ALL INTERIOR WALLS ARE I.O UNO. PROVIDE 3-1/2" SOUND INSULATION IN COMMON PARTY WALLS.
 ALL EXTERIOR WALLS ARE E.1 UNO.
- 3. ALL EXTERIOR DIMENSIONS ARE MEASURED FROM GRID LINE TO GRID LINE OR FACE OF FRAMING. ALL INTERIOR DIMENSIONS ARE FROM FACE OF STUD.
- 4. GRIDS ARE ALIGNED WITH THE EXTERIOR FACE OF FRAMING AT EXTERIOR WALLS AND ALIGNED WITH THE CENTER OF THE PARTY-WALLS.
- 5. DIMENSIONS AT POSTS ARE TO CENTERLINES UNO VERIFY ALL STRUCTURAL LOCATIONS WITH FRAMING PLANS
- 6. WINDOW DIMENSIONS ARE GIVEN AS NOMINAL MEASUREMENTS. 7. DOOR ROUGH OPENINGS ARE 4" OFF STUD FACE OF PERP. WALL (TO HINGED SIDE OF THE DOOR) UNO
- 8. ALL FINISH FLOOR MATERIALS TO ALIGN WITH ADJACENT FLOOR FINISH
- 9. SEE GENERAL SHEETS FOR CODE, DIMENSIONING AND GENERAL NOTES 10. SEE SHEETS A5.11 TO A5.14 FOR ENLARGED 1/4" = 1'-0" PLANS

FLOOR PLAN KEY

WALL CONC. WALL 1-HR RATED WALL 1-HR RATED FLOOR OR ROOF AREA

[----] STRIP VENT SOLAR READY ZONE

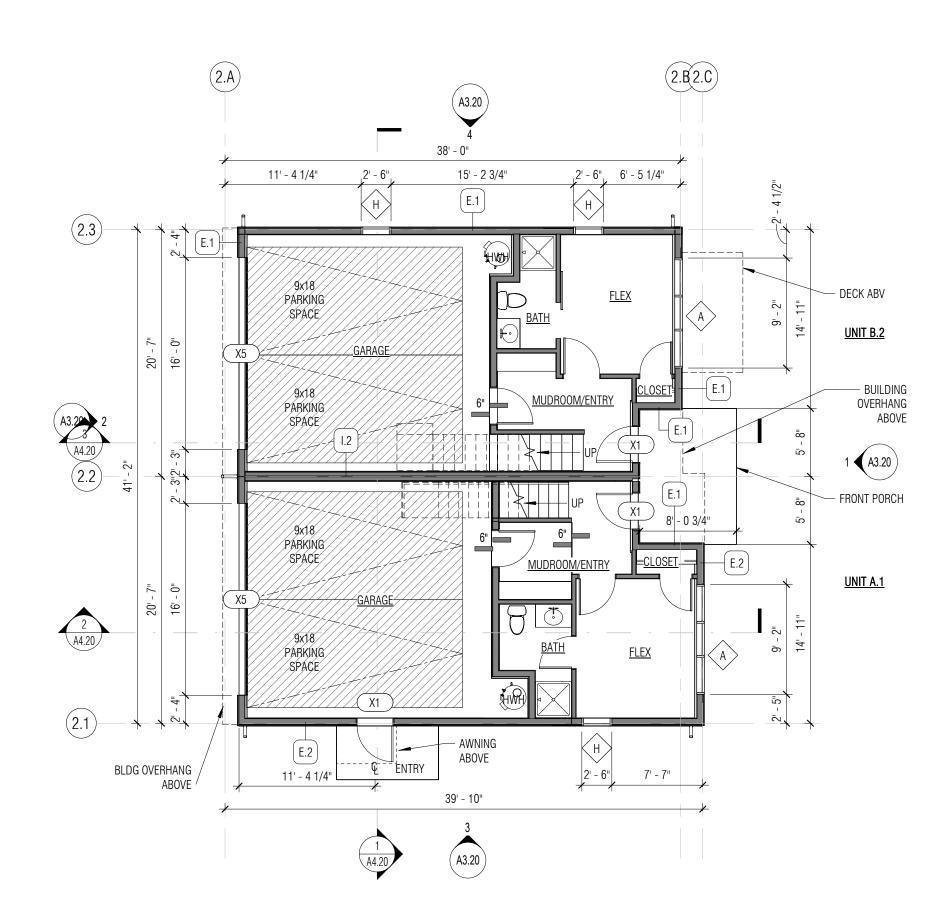

2-PACK TOWNHOUSE (A-B) FLOOR PLAN - LEVEL 1

1/8" = 1'-0"



CITY OF BELLINGHAM STAMP AREA

BELLINGHAM MES STREAM B TOWNHON

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SHEET NO.:

ROOF VENTILATION CALCULATIONS

REFERENCE: 2018 INTERNATIONAL RESIDENTIAL CODE SECTION R806

- 1. ENCLOSED ATTICS AND ENCLOSED RAFTER SPACES FORMED WHERE CEILINGS ARE APPLIED DIRECTLY TO THE UNDERSIDE OF ROOF RAFTERS SHALL HAVE CROSS VENTILATION FOR EACH SEPARATE SPACE BY VENTILATING OPENINGS PROTECTED AGAINST THE ENTRANCE OF RAIN OR SNOW.
- 2. VENTILATING OPENINGS SHALL BE PROVIDED WITH CORROSION-RESISTANT WIRE MESH WITH 1/8 INCH MINIMUM TO 1/4 INCH MAXIMUM OPENINGS.
- 3. THE TOTAL NET FREE VENTILATING AREA SHALL NOT BE LESS THAN 1/150 OF THE AREA OF THE SPACE VENTILATED, BUT MAY BE REDUCED TO 1/300, PROVIDED THAT AT LEAST 40 PERCENT AND NOT MORE THAN 50 PERCENT OF THE REQUIRED VENTILATING AREA IS PROVIDED BY VENTILATORS LOCATED IN THE UPPER PORTION OF THE SPACE TO BE VENTILATED NO MORE THAN 3 FEET BELOW THE RIDGE OR HIGHEST POINT OF THE SPACE, MEASURED VERTICALLY, WITH THE BALANCE OF THE REQUIRED VENTILATION PROVIDED BY EAVE OR CORNICE VENTS.
- 4. WHERE THE LOCATION OF WALL OR ROOF FRAMING MEMBERS CONFLICTS WITH THE INSTALLATION OF UPPER VENTILATORS, INSTALLATION MORE THAN 3 FEET BELOW THE RIDGE OR HIGHEST POINT OF THE SPACE SHALL BE PERMITTED. AS AN ALTERNATIVE, THE NET FREE CROSS-VENTILATION AREA MAY BE REDUCED TO 1/300 WHEN A VAPOR BARRIER HAVING A TRANSMISSION RATE NOT EXCEEDING 1 PERM IS INSTALLED ON THE WARM-IN-THE-WINTER SIDE OF
- 5. WHERE EAVE OR CORNICE VENTS ARE INSTALLED, INSULATION SHALL NOT BLOCK THE FREE FLOW OF AIR. A MINIMUM OF A 1-INCH SPACE SHALL BE PROVIDED BETWEEN THE INSULATION AND THE ROOF SHEATHING AND AT THE LOCATION OF THE VENT.


UNIT	AREA OF VENTED ATTIC (SF)	TOTAL REQ. VENT AREA = 1/300 OF AREA	VENTS PROVIDED	NET FREE OPENING AREA PER LINEAL FOOT (SI)	AREA PROVIDED (SI)	% OF REQ'D	
A.1 / A.1M , A.2	/ 767	368 SI	RIDGE VENT: (1) 20' LONG STRIP VENT: (1) 20' LONG		200 200	50% 50%	UPPER LOWER
MIN. REQ'D	NET FREE AREA	368 SI	Р	ROVIDED NET FREE AREA	400 SI		

IVIIIV. IILQ	D NET THEE AREA	000 01	J L	THOUBED IVET THEE MILEN	100 01		
UNIT	AREA OF VENTED ATTIC (SF)	TOTAL REQ. VENT AREA = 1/300 OF AREA	VENTS PROVIDED	NET FREE OPENING AREA PER LINEAL FOOT (SI)	Area Provided (SI)	% of Req'd	
B.1 / B.1M B.2	730	351 SI	RIDGE VENT: (1) 20' LOI STRIP VENT: (1) 20' LOI		200 200	50% 50%	UPPER LOWER
MIN. REQ'	D NET FREE AREA	351 SI		PROVIDED NET FREE AREA	400 SI		

GENERAL	NOTES -	FLOOR	PLAN
----------------	----------------	--------------	-------------


- 1. ALL INTERIOR WALLS ARE I.O UNO. PROVIDE 3-1/2" SOUND INSULATION IN COMMON PARTY WALLS.
- . ALL EXTERIOR WALLS ARE E.1 UNO.
- 3. ALL EXTERIOR DIMENSIONS ARE MEASURED FROM GRID LINE TO GRID LINE OR FACE OF FRAMING. ALL INTERIOR DIMENSIONS ARE FROM FACE OF STUD.
- 4. GRIDS ARE ALIGNED WITH THE EXTERIOR FACE OF FRAMING AT EXTERIOR WALLS AND ALIGNED WITH THE CENTER OF
- TIONS WITH FRAMING PLANS
- F THE DOOR) UNO
- 10. SEE SHEETS A5.11 TO A5.14 FOR ENLARGED 1/4" = 1'-0" PLANS

	THE PARTY-WALLS.
5.	DIMENSIONS AT POSTS ARE TO CENTERLINES UNO - VERIFY ALL STRUCTURAL LOCATION
6.	WINDOW DIMENSIONS ARE GIVEN AS NOMINAL MEASUREMENTS.
7.	DOOR ROUGH OPENINGS ARE 4" OFF STUD FACE OF PERP. WALL (TO HINGED SIDE OF
8.	ALL FINISH FLOOR MATERIALS TO ALIGN WITH ADJACENT FLOOR FINISH
9.	SEE GENERAL SHEETS FOR CODE, DIMENSIONING AND GENERAL NOTES

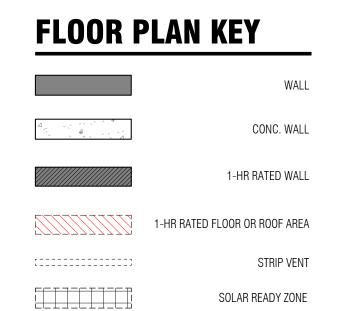

	A3.20 4	
1 1/2	38' - 0"	ou
	OUTLINE OF BUILDING BELOW, TYP	∕— DECK BELOW
(2.3)————	20' - 0" STRIP VENT, TYP	DEGINBLEOW
	RC.1	
	TYP 20' - 0" RIDGE VENT, TYP	
		UNIT B.2
A3.20 2	CRICKET	
(2.2)———————————————————————————————————	2"/12"	1 (A3.20)
MINIMUM CLASS C ROOF COVERING WITH FRTW SHEATHING FOR A DISTANCE OF 2 FEET ON EACH SIDE OF THE COMMON WALL - NO PENETRATIONS IN THIS AREA, TYP	38' - 0 3/16"	
		UNIT A.1
JULIET BALCONY BELOW —	10 1/2 1 15	SOLAR READY ZONE AREA, NON-NORTH FACING ROOF PLANE EA UNIT PER IRC 2018 'APPENDIX T'
(2.1)		
	AWNING BELOW	
1 1/2	39' - 10"	2 3/4"
	A3.20	



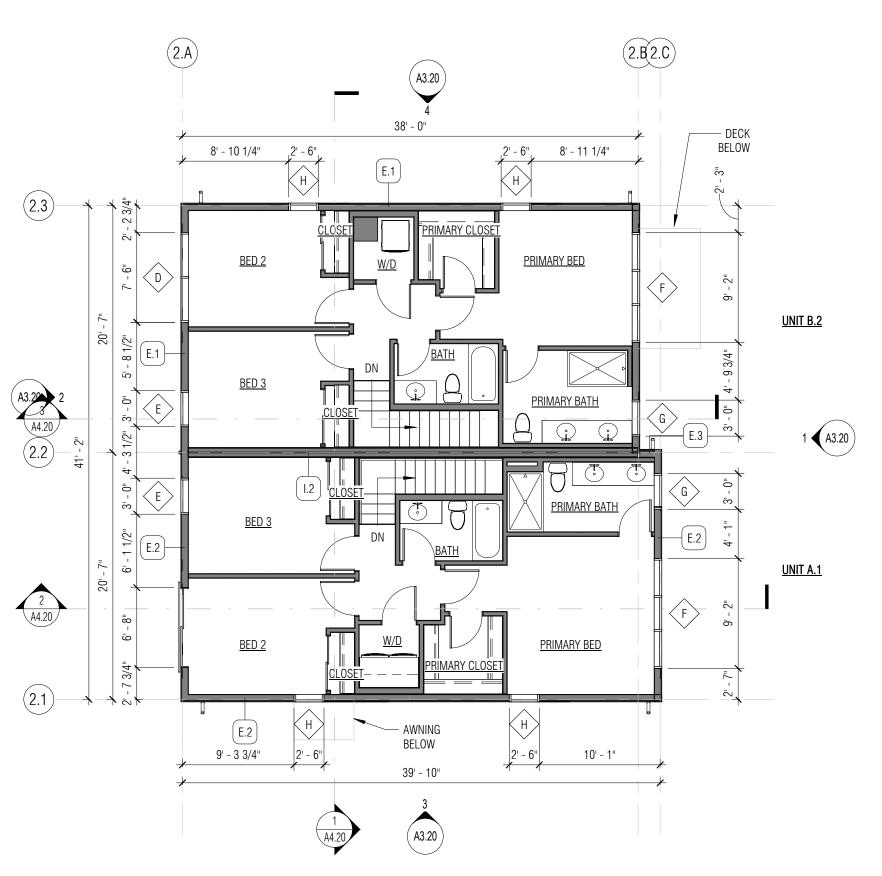

AREA OF VENTED REQUIRED

ATTIC SPACE (SF) 1/300 (SI)

368 SI

367 SI

350 SI

351 SI

767 SF

764 SF

728 SF

730 SF

NUMBER


UNIT A.2

UNIT B.2

UNIT A.1 / A.1M


UNIT B.1 / B.1M

2-PACK TOWNHOUSE (A-B) FLOOR PLAN - LEVEL 3

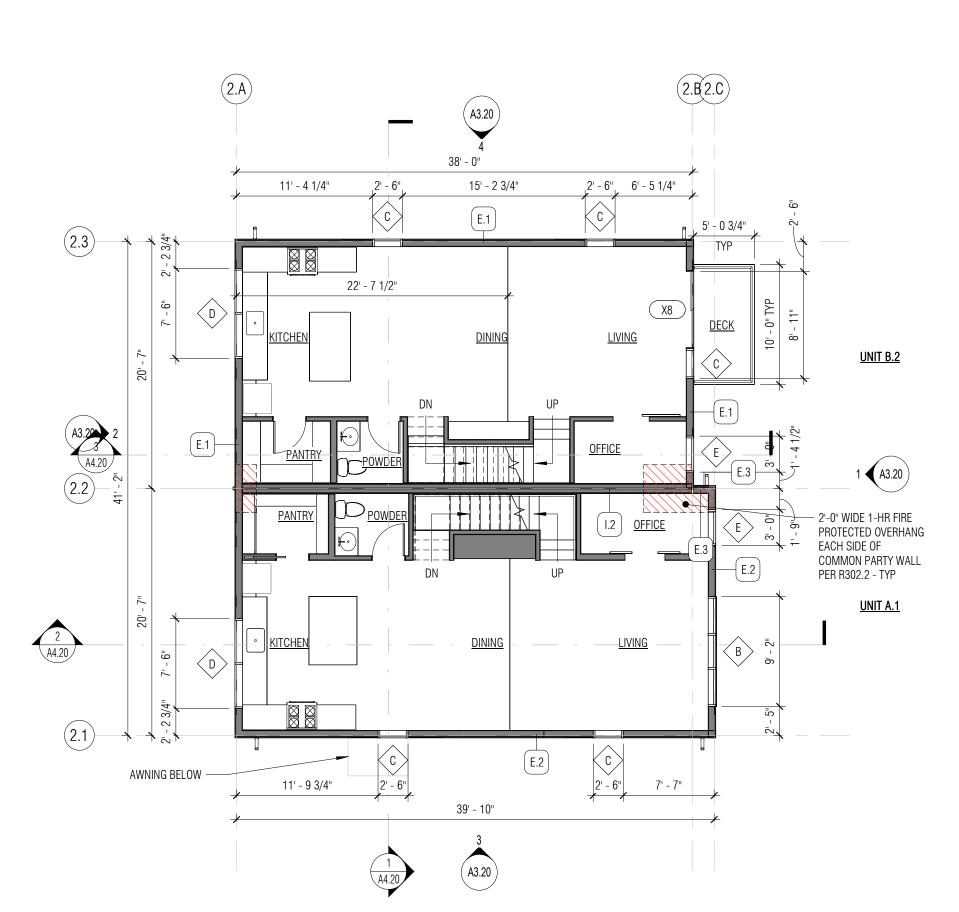

2-PACK TOWNHOUSE (A-B) FLOOR PLAN - LEVEL 2

1/8" = 1'-0"

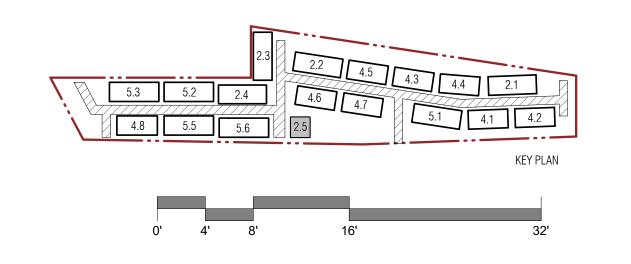



CITY OF BELLINGHAM STAMP AREA

BELLINGHAM MES STREAM E TOWNHON

REVISION DATE

DESCRIPTION

ISSUANCES

DATE DESCRIPTION 7/29/2022 LAND USE APPLICATION

1/13/2023 LAND USE APP RESUBMITTAL 4/14/2023 LAND USE APP RESUBMITTAL

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BOARD & VELLUM PROJECT #: 2021170.00 COB PROJECT #: 2021-0105

PLOT DATE: 04.12.2023 FLOOR PLANS - SECOND, THIRD FLOOR & ROOF -

2-PACK TH "A-B" UNITS SHEET NO.:

GENERAL NOTES - FLOOR PLANS


- ALL INTERIOR WALLS ARE I.O UNO. PROVIDE 3-1/2" SOUND INSULATION IN COMMON PARTY WALLS.
 ALL EXTERIOR WALLS ARE E.1 UNO.
- 3. ALL EXTERIOR DIMENSIONS ARE MEASURED FROM GRID LINE TO GRID LINE OR FACE OF FRAMING. ALL INTERIOR DIMENSIONS ARE FROM FACE OF STUD.

 3. ALL EXTERIOR DIMENSIONS ARE MEASURED FROM GRID LINE TO GRID LINE OR FACE OF FRAMING. ALL INTERIOR DIMENSIONS ARE FROM FACE OF STUD.
- 4. GRIDS ARE ALIGNED WITH THE EXTERIOR FACE OF FRAMING AT EXTERIOR WALLS AND ALIGNED WITH THE CENTER OF THE PARTY-WALLS.
- 5. DIMENSIONS AT POSTS ARE TO CENTERLINES UNO VERIFY ALL STRUCTURAL LOCATIONS WITH FRAMING PLANS
- 6. WINDOW DIMENSIONS ARE GIVEN AS NOMINAL MEASUREMENTS. 7. DOOR ROUGH OPENINGS ARE 4" OFF STUD FACE OF PERP. WALL (TO HINGED SIDE OF THE DOOR) UNO
- 8. ALL FINISH FLOOR MATERIALS TO ALIGN WITH ADJACENT FLOOR FINISH
- 9. SEE GENERAL SHEETS FOR CODE, DIMENSIONING AND GENERAL NOTES 10. SEE SHEETS A5.11 TO A5.14 FOR ENLARGED 1/4" = 1'-0" PLANS

FLOOR PLAN KEY


WALL CONC. WALL 1-HR RATED WALL 1-HR RATED FLOOR OR ROOF AREA [----] STRIP VENT

SOLAR READY ZONE

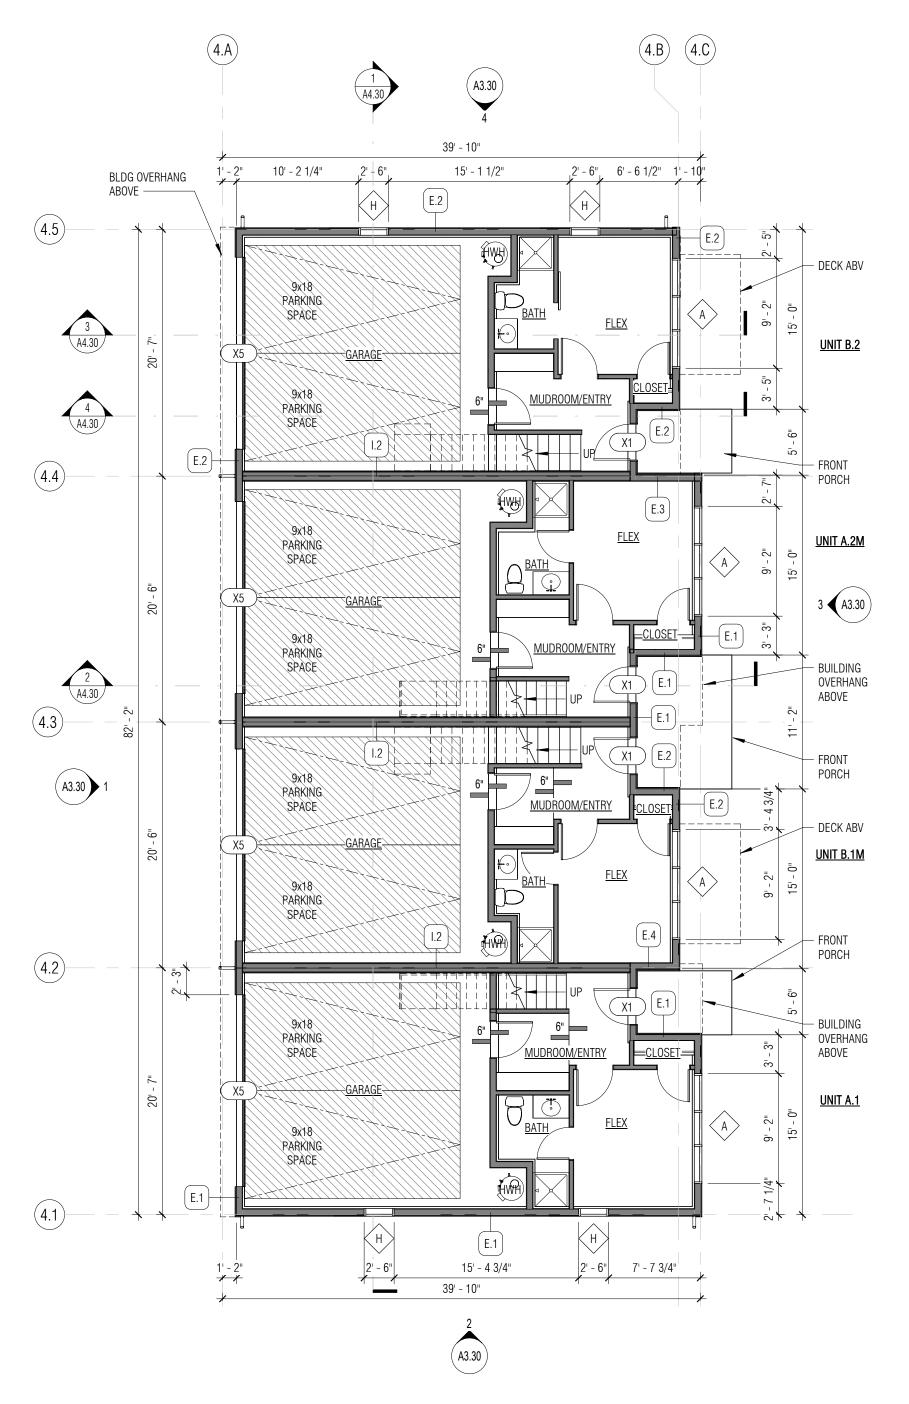

4-PACK TOWNHOUSE "A-B-A-B" FLOOR PLAN - LEVEL 1

FLOOR PLAN - LEVEL 1 FOR BLDGS 4.2, 4.7: SEE A2.31 FLOOR PLAN - LEVEL 1 FOR BLDG 4.5: SEE A2.32

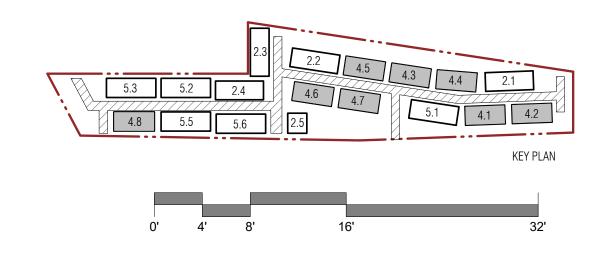





BELLINGHAM MES

STREAM B TOWNHON

REVISION DATE

DESCRIPTION

ISSUANCES

DATE DESCRIPTION

7/29/2022 LAND USE APPLICATION 1/13/2023 LAND USE APP RESUBMITTAL 4/14/2023 LAND USE APP RESUBMITTAL

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BOARD & VELLUM PROJECT #: 2021170.00 COB PROJECT #:

PLOT DATE:

04.12.2023 FLOOR PLANS - FDN & FIRST FLR - 4-PACK TH "A-B-A-B" UNITS (4.1, 4.3, 4.4, 4.6) SHEET NO.:

ROOF VENTILATION CALCULATIONS


REFERENCE: 2018 INTERNATIONAL RESIDENTIAL CODE SECTION R806

- 1. ENCLOSED ATTICS AND ENCLOSED RAFTER SPACES FORMED WHERE CEILINGS ARE APPLIED DIRECTLY TO THE UNDERSIDE OF ROOF RAFTERS SHALL HAVE CROSS VENTILATION FOR EACH SEPARATE SPACE BY VENTILATING OPENINGS PROTECTED AGAINST THE ENTRANCE OF RAIN OR SNOW.
- 2. VENTILATING OPENINGS SHALL BE PROVIDED WITH CORROSION-RESISTANT WIRE MESH WITH 1/8 INCH MINIMUM TO 1/4 INCH MAXIMUM OPENINGS 3. THE TOTAL NET FREE VENTILATING AREA SHALL NOT BE LESS THAN 1/150 OF THE AREA OF THE SPACE VENTILATED, BUT
- MAY BE REDUCED TO 1/300, PROVIDED THAT AT LEAST 40 PERCENT AND NOT MORE THAN 50 PERCENT OF THE REQUIRED VENTILATING AREA IS PROVIDED BY VENTILATORS LOCATED IN THE UPPER PORTION OF THE SPACE TO BE VENTILATED NO MORE THAN 3 FEET BELOW THE RIDGE OR HIGHEST POINT OF THE SPACE, MEASURED VERTICALLY, WITH THE BALANCE OF THE REQUIRED VENTILATION PROVIDED BY EAVE OR CORNICE VENTS. 4. WHERE THE LOCATION OF WALL OR ROOF FRAMING MEMBERS CONFLICTS WITH THE INSTALLATION OF UPPER
- VENTILATORS, INSTALLATION MORE THAN 3 FEET BELOW THE RIDGE OR HIGHEST POINT OF THE SPACE SHALL BE PERMITTED. AS AN ALTERNATIVE, THE NET FREE CROSS-VENTILATION AREA MAY BE REDUCED TO 1/300 WHEN A VAPOR BARRIER HAVING A TRANSMISSION RATE NOT EXCEEDING 1 PERM IS INSTALLED ON THE WARM-IN-THE-WINTER SIDE OF
- 5. WHERE EAVE OR CORNICE VENTS ARE INSTALLED, INSULATION SHALL NOT BLOCK THE FREE FLOW OF AIR. A MINIMUM OF A 1-INCH SPACE SHALL BE PROVIDED BETWEEN THE INSULATION AND THE ROOF SHEATHING AND AT THE LOCATION OF THE VENT.


A.2 STRIP VENT: (1) 20' LONG 10 200 50% LOW	UNIT	AREA OF VENTED ATTIC (SF)	TOTAL REQ. VENT AREA = 1/300 OF AREA	VENTS PROVIDED	NET FREE OPENING AREA PER LINEAL FOOT (SI)	AREA PROVIDED (SI)	% OF REQ'D	
MIN DECID NET EDEE ADEA 269 CI DEDOVIDED NET EDEE ADEA 400 CI		/ 767	368 SI					UPPER LOWER
WIN. HEQD NET THE AREA 400 SI	MIN. REQ'D	NET FREE AREA	368 SI		PROVIDED NET FREE AREA	400 SI		

UNIT	AREA OF VENTED ATTIC (SF)	TOTAL REQ. VENT AREA = 1/300 OF AREA	VENTS PROVIDED	NET FREE OPENING AREA PER LINEAL FOOT (SI)	AREA PROVIDED (SI)	% OF REQ'D	
B.1 / B.1M , B.2	/ 730	351 SI	RIDGE VENT: (1) 20' LONG STRIP VENT: (1) 20' LONG		200 200	50% 50%	UPPEF LOWEF
MIN. REQ'D	NET FREE AREA	351 SI	Р	PROVIDED NET FREE AREA	400 SI		

UNIT	AREA OF VENTED	REQUIRE
NUMBER	ATTIC SPACE (SF)	1/300 (S
UNIT A.1 / A.1M	767 SF	368 SI
UNIT A.2	764 SF	367 SI
UNIT B.1 / B.1M	728 SF	350 SI
UNIT B.2	730 SF	351 SI

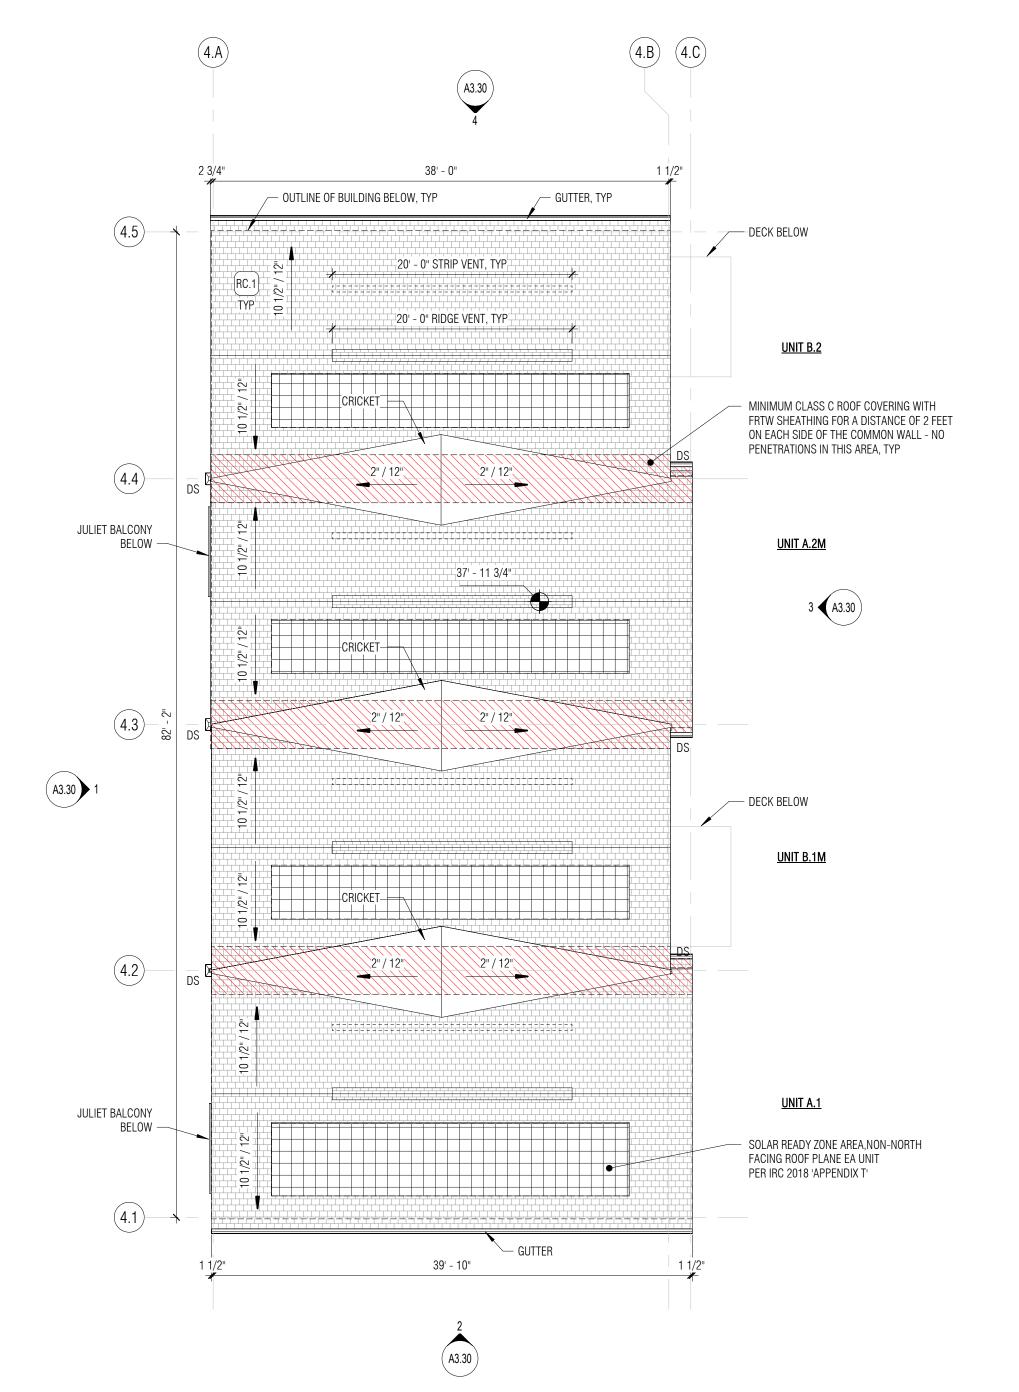



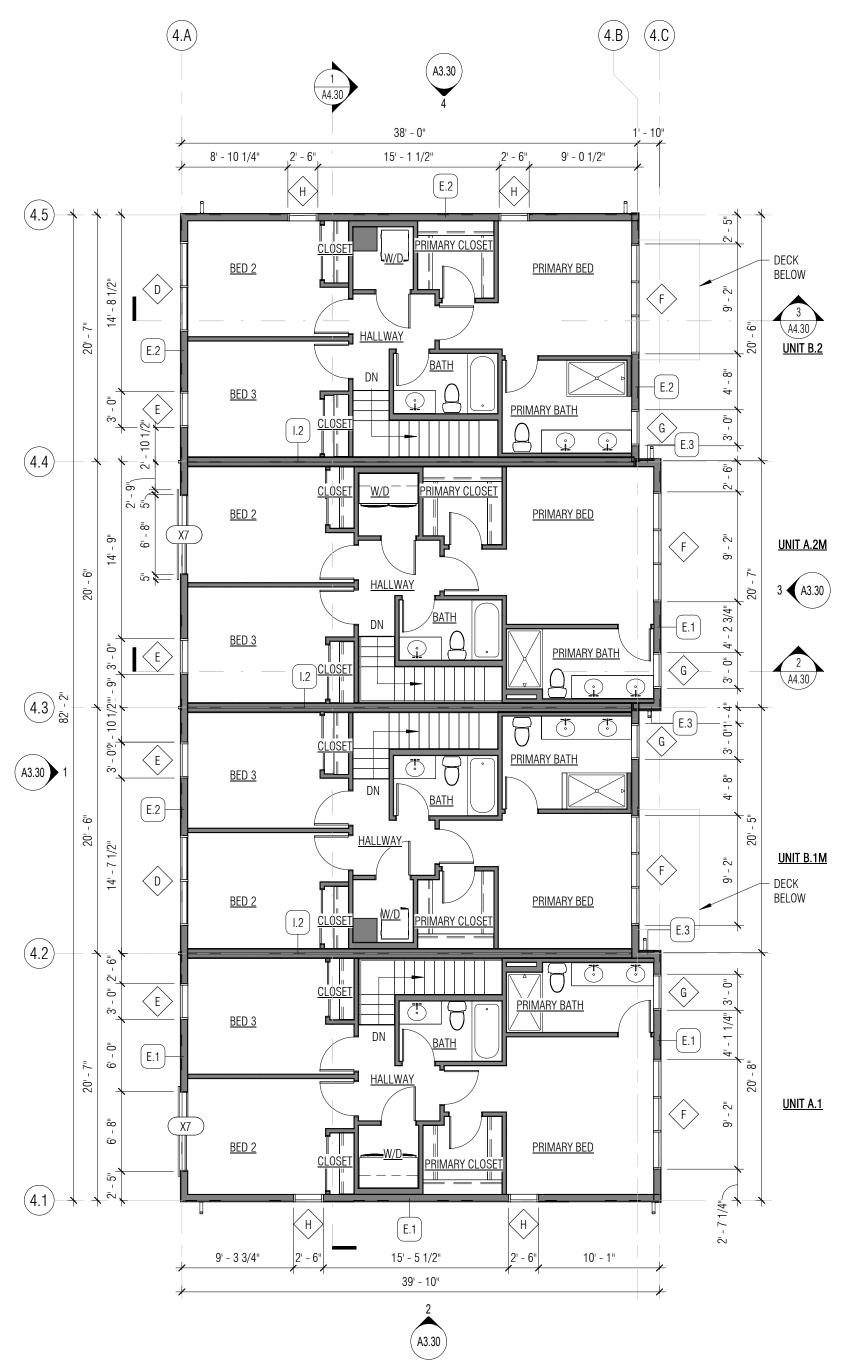

4-PACK TOWNHOUSE "A-B-A-B" FLOOR PLAN - LEVEL 3

GENERAL NOTES - FLOOR PLANS

- 1. ALL INTERIOR WALLS ARE I.O UNO. PROVIDE 3-1/2" SOUND INSULATION IN COMMON PARTY WALLS.
- 2. ALL EXTERIOR WALLS ARE E.1 UNO. 3. ALL EXTERIOR DIMENSIONS ARE MEASURED FROM GRID LINE TO GRID LINE OR FACE OF FRAMING. ALL INTERIOR
- DIMENSIONS ARE FROM FACE OF STUD.
- 4. GRIDS ARE ALIGNED WITH THE EXTERIOR FACE OF FRAMING AT EXTERIOR WALLS AND ALIGNED WITH THE CENTER OF
- THE PARTY-WALLS. DIMENSIONS AT POSTS ARE TO CENTERLINES UNO - VERIFY ALL STRUCTURAL LOCATIONS WITH FRAMING PLANS
- WINDOW DIMENSIONS ARE GIVEN AS NOMINAL MEASUREMENTS. DOOR ROUGH OPENINGS ARE 4" OFF STUD FACE OF PERP. WALL (TO HINGED SIDE OF THE DOOR) UNO
- 8. ALL FINISH FLOOR MATERIALS TO ALIGN WITH ADJACENT FLOOR FINISH 9. SEE GENERAL SHEETS FOR CODE, DIMENSIONING AND GENERAL NOTES
- 10. SEE SHEETS A5.11 TO A5.14 FOR ENLARGED 1/4" = 1'-0" PLANS


FLOOR PLAN KEY

WALL CONC. WALL 1-HR RATED WALL


1-HR RATED FLOOR OR ROOF AREA

[----] STRIP VENT

SOLAR READY ZONE

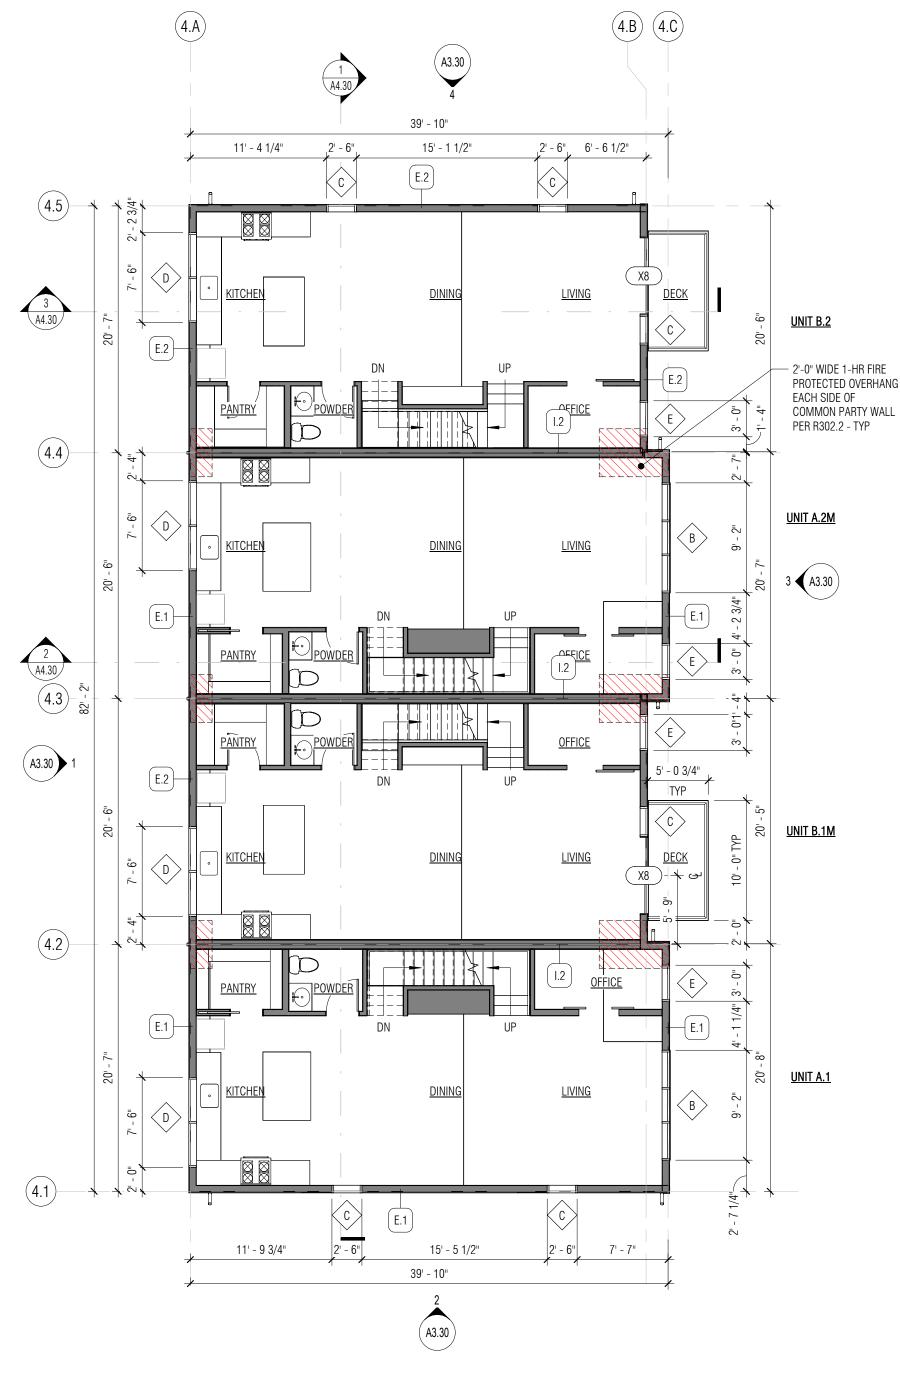



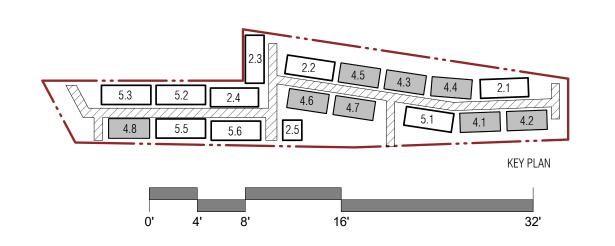

Δ ₹

9858 | REGISTERED STATE OF WASHINGTON

CITY OF BELLINGHAM STAMP AREA

BELLINGHAM MES

STREAM B TOWNHON

REVISION DATE DESCRIPTION

ISSUANCES DATE DESCRIPTION 7/29/2022 LAND USE APPLICATION

1/13/2023 LAND USE APP RESUBMITTAL 4/14/2023 LAND USE APP RESUBMITTAL

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COB PROJECT #: 2021-0105

PLOT DATE: 04.12.2023 FLOOR PLANS - SECOND, THIRD FLOOR & ROOF -

4-PACK TH "A-B-A-B" UNITS SHEET NO.:

GENERAL NOTES - FLOOR PLANS

- ALL INTERIOR WALLS ARE I.O UNO. PROVIDE 3-1/2" SOUND INSULATION IN COMMON PARTY WALLS.
 ALL EXTERIOR WALLS ARE E.1 UNO.
- 3. ALL EXTERIOR DIMENSIONS ARE MEASURED FROM GRID LINE TO GRID LINE OR FACE OF FRAMING. ALL INTERIOR DIMENSIONS ARE FROM FACE OF STUD.

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- 4. GRIDS ARE ALIGNED WITH THE EXTERIOR FACE OF FRAMING AT EXTERIOR WALLS AND ALIGNED WITH THE CENTER OF THE PARTY-WALLS.
- 5. DIMENSIONS AT POSTS ARE TO CENTERLINES UNO VERIFY ALL STRUCTURAL LOCATIONS WITH FRAMING PLANS 6. WINDOW DIMENSIONS ARE GIVEN AS NOMINAL MEASUREMENTS.
- 7. DOOR ROUGH OPENINGS ARE 4" OFF STUD FACE OF PERP. WALL (TO HINGED SIDE OF THE DOOR) UNO
- 8. ALL FINISH FLOOR MATERIALS TO ALIGN WITH ADJACENT FLOOR FINISH 9. SEE GENERAL SHEETS FOR CODE, DIMENSIONING AND GENERAL NOTES

10. SEE SHEETS A5.11 TO A5.14 FOR ENLARGED 1/4" = 1'-0" PLANS

WALL CONC. WALL


FLOOR PLAN KEY

1-HR RATED WALL

1-HR RATED FLOOR OR ROOF AREA

[----] STRIP VENT

SOLAR READY ZONE

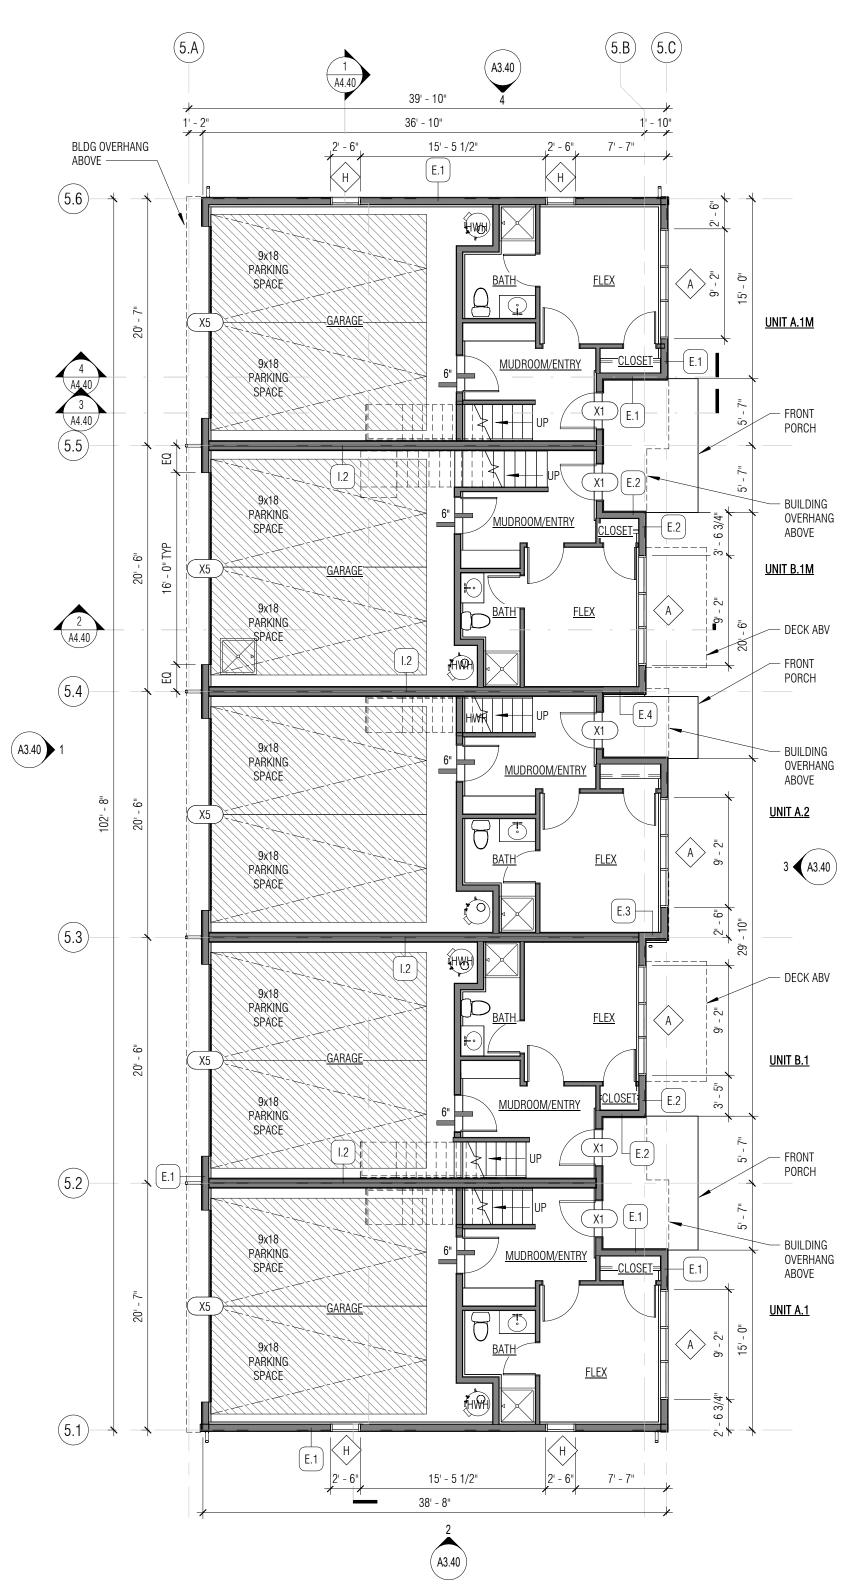


5-PACK TOWNHOUSE "A-B-A-B-A" FLOOR PLAN - LEVEL 1

FLOOR PLAN - LEVEL 1 FOR BLDGS 5.2, 5.3: SEE A2.41 FLOOR PLAN - LEVEL 1 FOR BLDGS 5.4, 5.5, 5.6: SEE A2.42

5.3 5.2 2.4



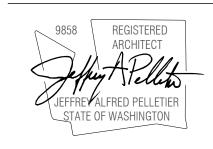



BELLINGHAM MES STREAM B TOWNHON

REVISION DATE DESCRIPTION

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DATE DESCRIPTION

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BOARD & VELLUM PROJECT #: 2021170.00 COB PROJECT #: 2021-0105

PLOT DATE:

SHEET NO.:

04.12.2023 FLOOR PLANS - FDN & FIRST FLR - 5-PACK TH "A-B-A-B-A" UNITS (5.1)

ROOF VENTILATION CALCULATIONS

REFERENCE: 2018 INTERNATIONAL RESIDENTIAL CODE SECTION R806

- ENCLOSED ATTICS AND ENCLOSED RAFTER SPACES FORMED WHERE CEILINGS ARE APPLIED DIRECTLY TO THE UNDERSIDE OF ROOF RAFTERS SHALL HAVE CROSS VENTILATION FOR EACH SEPARATE SPACE BY VENTILATING OPENINGS PROTECTED AGAINST THE ENTRANCE OF RAIN OR SNOW.
- PROTECTED AGAINST THE ENTRANCE OF RAIN OR SNOW.

 2. VENTILATING OPENINGS SHALL BE PROVIDED WITH CORROSION-RESISTANT WIRE MESH WITH 1/8 INCH MINIMUM TO 1/4 INCH MAXIMUM OPENINGS.
- 3. THE TOTAL NET FREE VENTILATING AREA SHALL NOT BE LESS THAN 1/150 OF THE AREA OF THE SPACE VENTILATED, BUT MAY BE REDUCED TO 1/300, PROVIDED THAT AT LEAST 40 PERCENT AND NOT MORE THAN 50 PERCENT OF THE REQUIRED VENTILATING AREA IS PROVIDED BY VENTILATORS LOCATED IN THE UPPER PORTION OF THE SPACE TO BE VENTILATED NO MORE THAN 3 FEET BELOW THE RIDGE OR HIGHEST POINT OF THE SPACE, MEASURED VERTICALLY, WITH THE BALANCE OF THE REQUIRED VENTILATION PROVIDED BY EAVE OR CORNICE VENTS.
- 4. WHERE THE LOCATION OF WALL OR ROOF FRAMING MEMBERS CONFLICTS WITH THE INSTALLATION OF UPPER VENTILATORS, INSTALLATION MORE THAN 3 FEET BELOW THE RIDGE OR HIGHEST POINT OF THE SPACE SHALL BE PERMITTED. AS AN ALTERNATIVE, THE NET FREE CROSS-VENTILATION AREA MAY BE REDUCED TO 1/300 WHEN A VAPOR BARRIER HAVING A TRANSMISSION RATE NOT EXCEEDING 1 PERM IS INSTALLED ON THE WARM-IN-THE-WINTER SIDE OF THE CEILING.
- 5. WHERE EAVE OR CORNICE VENTS ARE INSTALLED, INSULATION SHALL NOT BLOCK THE FREE FLOW OF AIR. A MINIMUM OF A 1-INCH SPACE SHALL BE PROVIDED BETWEEN THE INSULATION AND THE ROOF SHEATHING AND AT THE LOCATION OF THE VENT.

UNIT	AREA OF VENTED ATTIC (SF)	TOTAL REQ. VENT AREA = 1/300 OF AREA	VENTS PROVIDED	NET FREE OPENING AREA PER LINEAL FOOT (SI)	AREA PROVIDED (SI)	% OF REQ'D	
A.1 / A.1M , A.2	767	368 SI	RIDGE VENT: (1) 20' LONG STRIP VENT: (1) 20' LONG		200 200	50% 50%	UPPER LOWER
MIN. REQ'D	NET FREE AREA	368 SI	P	PROVIDED NET FREE AREA	400 SI		

50%	LOWER	
		UNIT A.1 / A.1M UNIT A.2
% OF REQ'D		UNIT B.1 / B.1M UNIT B.2

AREA OF VENTED REQUIRED

ATTIC SPACE (SF) 1/300 (SI)

368 SI

367 SI

350 SI

351 SI


767 SF

764 SF

728 SF

730 SF

UNIT	AREA OF VENTED ATTIC (SF)	TOTAL REQ. VENT AREA = 1/300 OF AREA	VENTS PROVIDED	NET FREE OPENING AREA PER LINEAL FOOT (SI)	AREA PROVIDED (SI)	% OF REQ'D	
B.1 / B.1M , B.2	/ 730	351 SI	RIDGE VENT: (1) 20' LONG STRIP VENT: (1) 20' LONG		200 200	50% 50%	UPPER LOWER
MIN. REQ'D	NET FREE AREA	351 SI	PI	ROVIDED NET FREE AREA	400 SI		

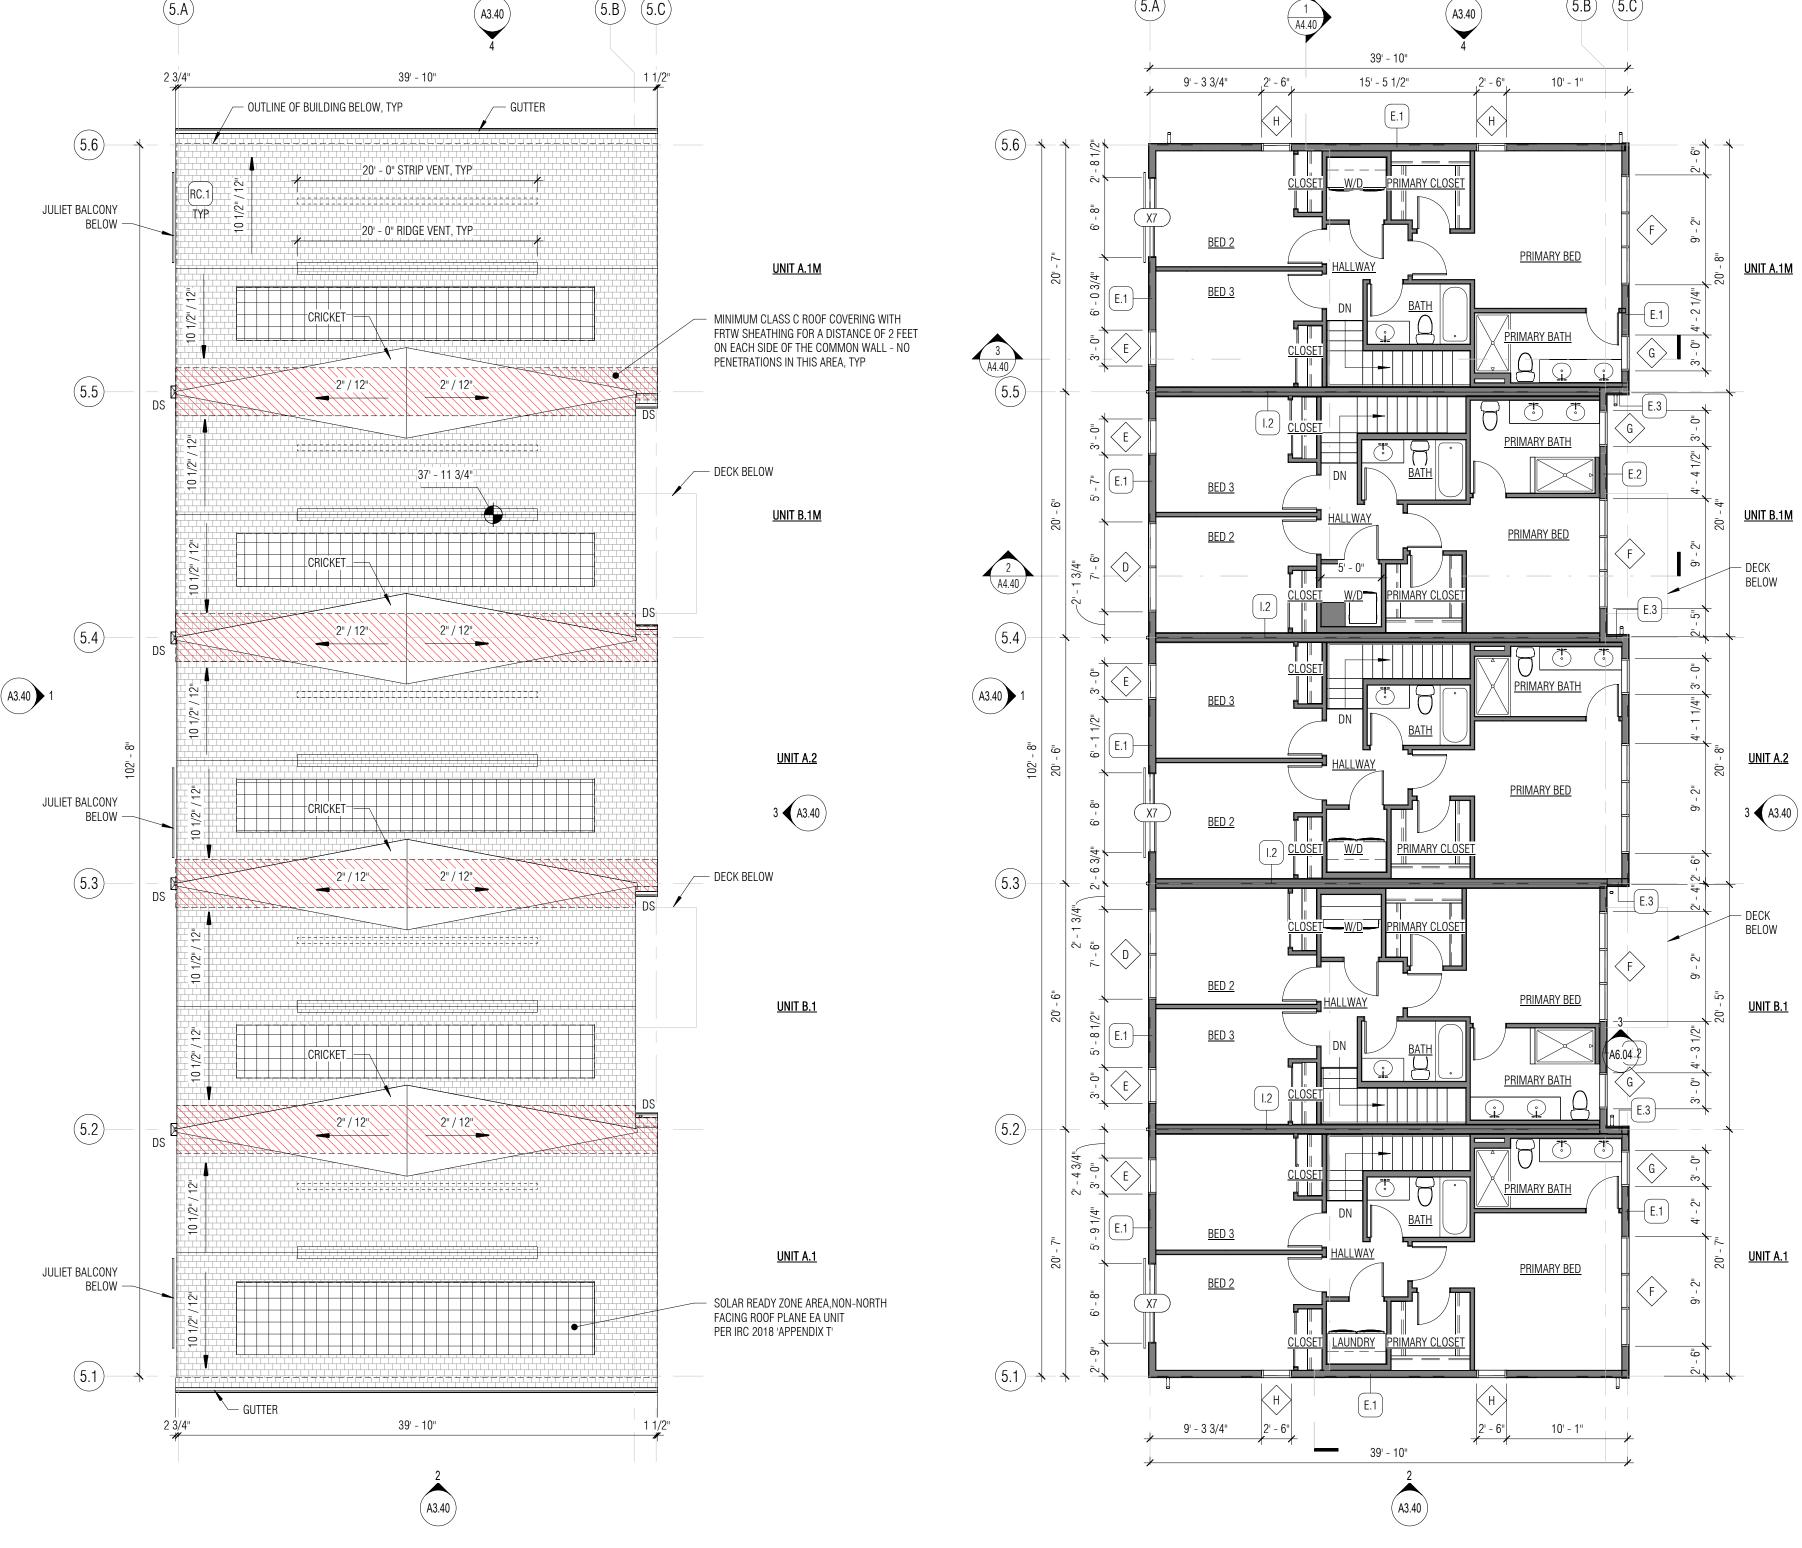

3 5-PACK TOWNHOUSE "A-B-A-B-A" ROOF PLAN

1/8" = 1'-0"

5-PACK TOWNHOUSE "A-B-A-B-A" FLOOR PLAN - LEVEL 3

GENERAL NOTES - FLOOR PLANS

- 1. ALL INTERIOR WALLS ARE I.O UNO. PROVIDE 3-1/2" SOUND INSULATION IN COMMON PARTY WALLS.
- ALL EXTERIOR WALLS ARE E.1 UNO.
 ALL EXTERIOR DIMENSIONS ARE MEASURED FROM GRID LINE TO GRID LINE OR FACE OF FRAMING. ALL INTERIOR
- DIMENSIONS ARE FROM FACE OF STUD.

 4. GRIDS ARE ALIGNED WITH THE EXTERIOR FACE OF FRAMING AT EXTERIOR WALLS AND ALIGNED WITH THE CENTER OF
- THE PARTY-WALLS.

 5. DIMENSIONS AT POSTS ARE TO CENTERLINES LINO VERIEV ALL STRUCTURAL LOCATIONS WITH ERAMING PLANS
- 5. DIMENSIONS AT POSTS ARE TO CENTERLINES UNO VERIFY ALL STRUCTURAL LOCATIONS WITH FRAMING PLANS
- . WINDOW DIMENSIONS ARE GIVEN AS NOMINAL MEASUREMENTS. . DOOR ROUGH OPENINGS ARE 4" OFF STUD FACE OF PERP. WALL (TO HINGED SIDE OF THE DOOR) UNO


11' - 9 3/4"


- 8. ALL FINISH FLOOR MATERIALS TO ALIGN WITH ADJACENT FLOOR FINISH
- 9. SEE GENERAL SHEETS FOR CODE, DIMENSIONING AND GENERAL NOTES
 10. SEE SHEETS A5.11 TO A5.14 FOR ENLARGED 1/4" = 1'-0" PLANS

5.4

A3.40 1

5.2

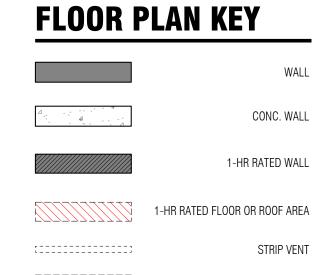


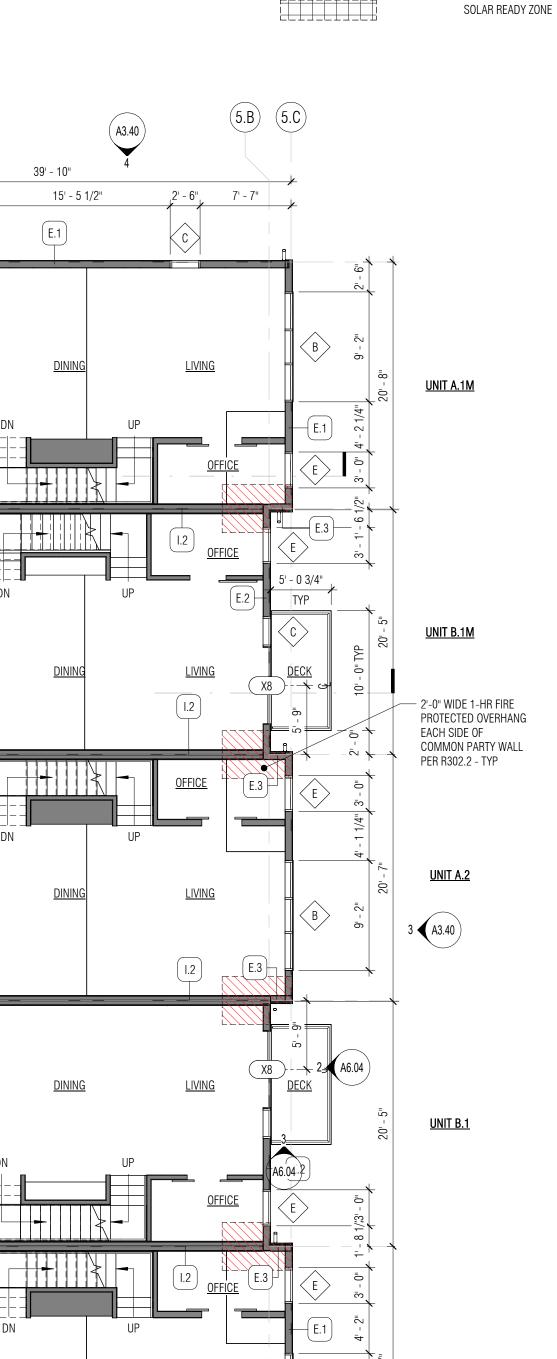



(A3.40)

11' - 9 3/4"

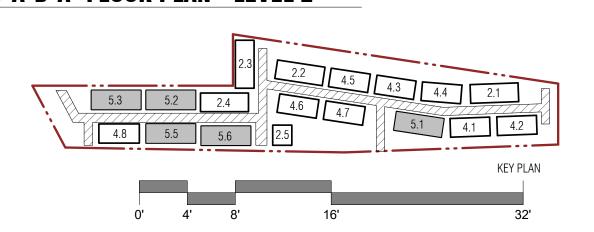



9858 REGISTERED
ARCHITECT

JEFFREY ALFRED PELLETIER
STATE OF WASHINGTON

Δ ₹

CITY OF BELLINGHAM STAMP AREA

STREAM BELLINGHAM
TOWNHOMES
PROJECT ADDRESS:
3509 MERIDIAN STREET, BELLINGHAM, WA 98225

REVISION DATE DESCRIPTION

NON DATE DE

ISSUANCES

DATE DESCRIPTION

7/29/2022 LAND USE APPLICATION
1/13/2023 LAND USE APP RESUBMITTAL
4/14/2023 LAND USE APP RESUBMITTAL

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ORIGINAL SHEET SIZE IS 24*x36*

BOARD & VELLUM PROJECT #: 202117

PLOT DATE: 04.12.2023

FLOOR PLANS - SECOND


FLOOR PLANS - SECOND,
THIRD FLR & ROOF - 5-PACK
TH "A-B-A-B-A" UNITS
SHEET NO.:

EXTERIOR MATERIAL SCHEDULE

1 ASPHALT SHINGLE ROOFING CHARCOAL GRAY



FIBER CEMENT SIDING VERTICAL BOARD AND BATTEN
5/16" FIBER CEMENT PANEL WITH BATTENS
2-1/2" WIDE X 3/4" DEEP
RANDOMIZE BATTEN SPACING PER
PAINT COLOR: SW6252 ICE CUBE

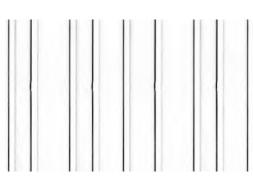

FIBER CEMENT SIDING VERTICAL BOARD AND BATTEN
5/16" FIBER CEMENT PANEL WITH BATTENS
2-1/2" WIDE X 3/4" DEEP
RANDOMIZE BATTEN SPACING PER
PAINT COLOR: SW6991 BLACK MAGIC



FIBER CEMENT SIDING - WOOD LOOK 5/16" FIBER CEMENT PANEL



5 NOT USED

6 FASCIA - BLACK METAL





7 VINYL WINDOW FRAME - BLACK



8 VINYL DOOR - BLACK



9 VINYL SLIDING DOOR - BLACK














 \sum_{α}^{4} 9858 REGISTERED
ARCHITECT

JEFFREY ALFRED PELLETIER
STATE OF MASURMOTON

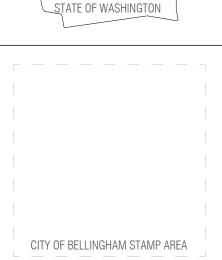



STREAM B TOWNHON

BELLINGHAM MES

REVISION DATE

DESCRIPTION

ISSUANCES DATE DESCRIPTION

7/29/2022 LAND USE APPLICATION 1/13/2023 LAND USE APP RESUBMITTAL 4/14/2023 LAND USE APP RESUBMITTAL


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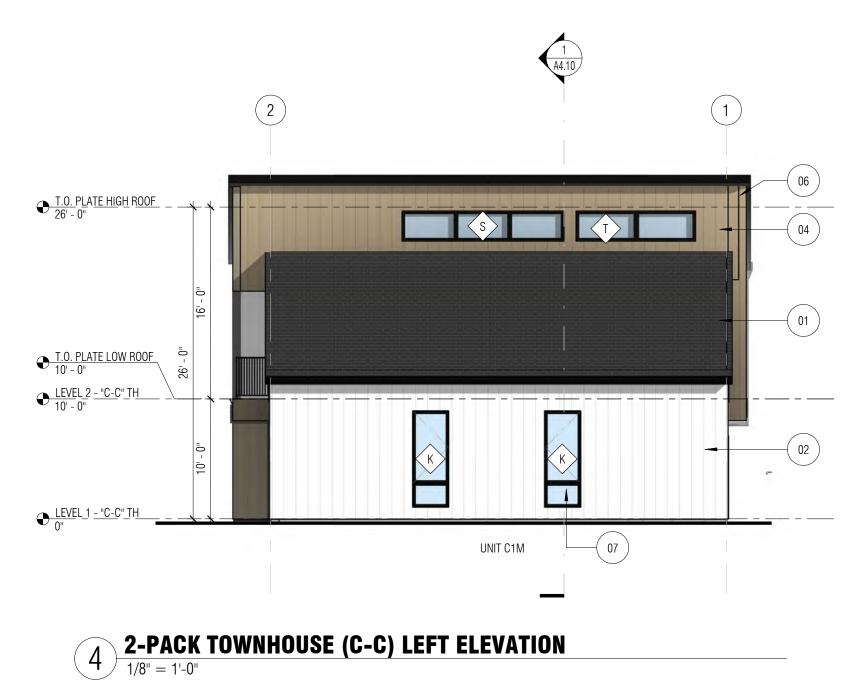
BOARD & VELLUM PROJECT #: 2021170.00 COB PROJECT #: 2021-0105

PLOT DATE:

BUILDING ELEVATIONS -MATERIALS

04.12.2023



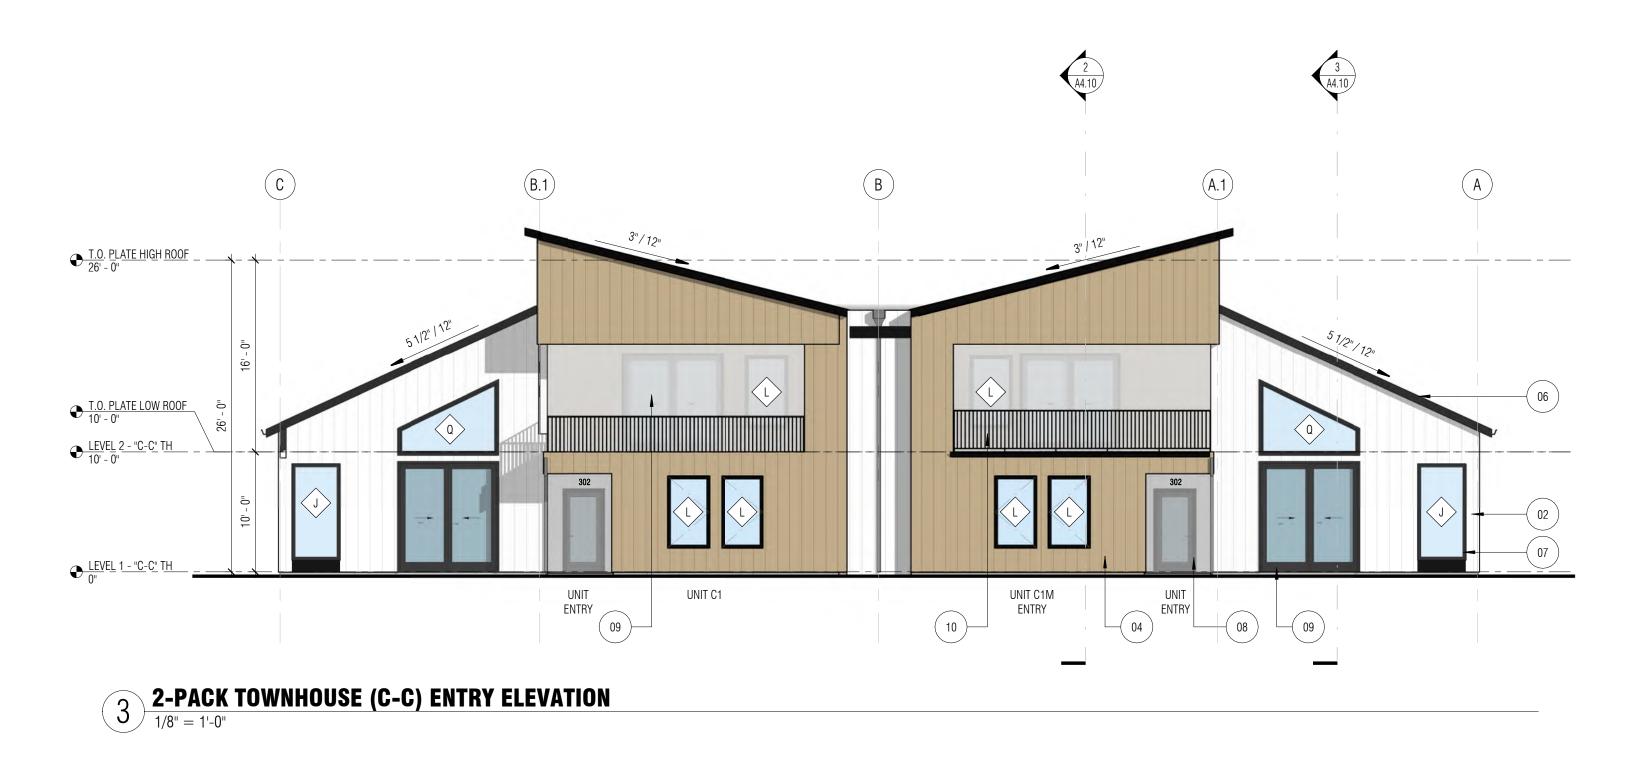


2-PACK TOWNHOUSE (C-C) GARAGE ELEVATION


1/8" = 1'-0"



2-PACK TOWNHOUSE (C-C) RIGHT ELEVATION

1/8" = 1'-0"

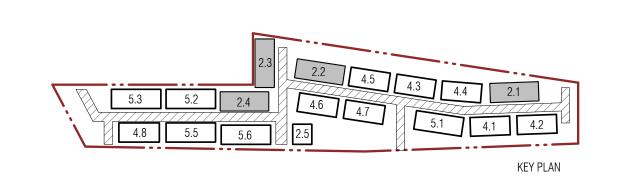

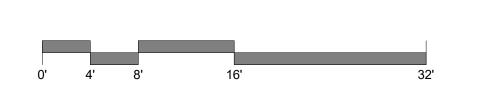

GENERAL NOTES

- REFER TO SHEET A2.00 FOR EXTERIOR BUILDING PRODUCT IMAGES.
 REFER TO SHEET G1.02 FOR ZONING HEIGHT LIMIT AND GRADE INFORMATION.
 REFER TO ENLARGED SITE PLAN A1 21 AND A1 22 FOR LINIT FINISH FLOOR
- 2. REFER TO SHEET G1.02 FOR ZONING HEIGHT LIMIT AND GRADE INFORMATION

 3. REFER TO ENLARGED SITE PLAN A1.21 AND A1.22 FOR UNIT FINISH FLOOR
 ELEVATIONS.
- 4. EXHAUST DUCTS AND OPENINGS SHALL TERMINATE NOT LESS THAN 3 FEET FROM OPERABLE WINDOWS, OPENINGS INTO THE BUILDING AND FROM THE PROPERYT LINE AND FIRE SPEARATION LINES.


EXTERIOR MATERIAL SCHEDULE

- 1 ASPHALT SHINGLE ROOFING CHARCOAL GRAY
- FIBER CEMENT SIDING VERTICAL BOARD AND BATTEN
 5/16" FIBER CEMENT PANEL WITH BATTENS 2-1/2" WIDE X 3/4" DEEP
 RANDOMIZE BATTEN SPACING PER
 PAINT COLOR: SW6252 ICE CUBE
- FIBER CEMENT SIDING VERTICAL BOARD AND BATTEN
 5/16" FIBER CEMENT PANEL WITH BATTENS 2-1/2" WIDE X 3/4" DEEP
 RANDOMIZE BATTEN SPACING PER
 PAINT COLOR: SW6991 BLACK MAGIC
- FIBER CEMENT SIDING WOOD LOOK 5/16" FIBER CEMENT PANEL
- 5 NOT USED
- 6 FASCIA BLACK METAL
- 7 VINYL WINDOW FRAME BLACK
- 8 VINYL DOOR BLACK
- 9 VINYL SLIDING DOOR BLACK
- 10 METAL RAILING BLACK
- (11) GARAGE DOOR BLACK
- DOWNSPOUT / GUTTER BLACK



Board & Vellum
ARCHITECTURE AND DESIGN
115 15th Ave E. Suite 100 Seattle, WA 98112
info@boardandvellum.com | 206.707.8895



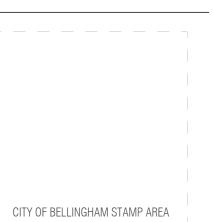

STREAM BELLINGHAM
TOWNHOMES

FROJECT

DESCRIPTION

REVISION DATE

DATE DESCRIPTION

7/29/2022 LAND USE APPLICATION
1/13/2023 LAND USE APP RESUBMITTAL
4/14/2023 LAND USE APP RESUBMITTAL

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BOARD & VELLUM PROJECT #: 2021170

COB PROJECT #: 2021-0105

PLOT DATE: 04.12.2023

BUILDING ELEVATIONS -


2-PACK TH "C-C" UNITS
SHEET NO.:

A3.10







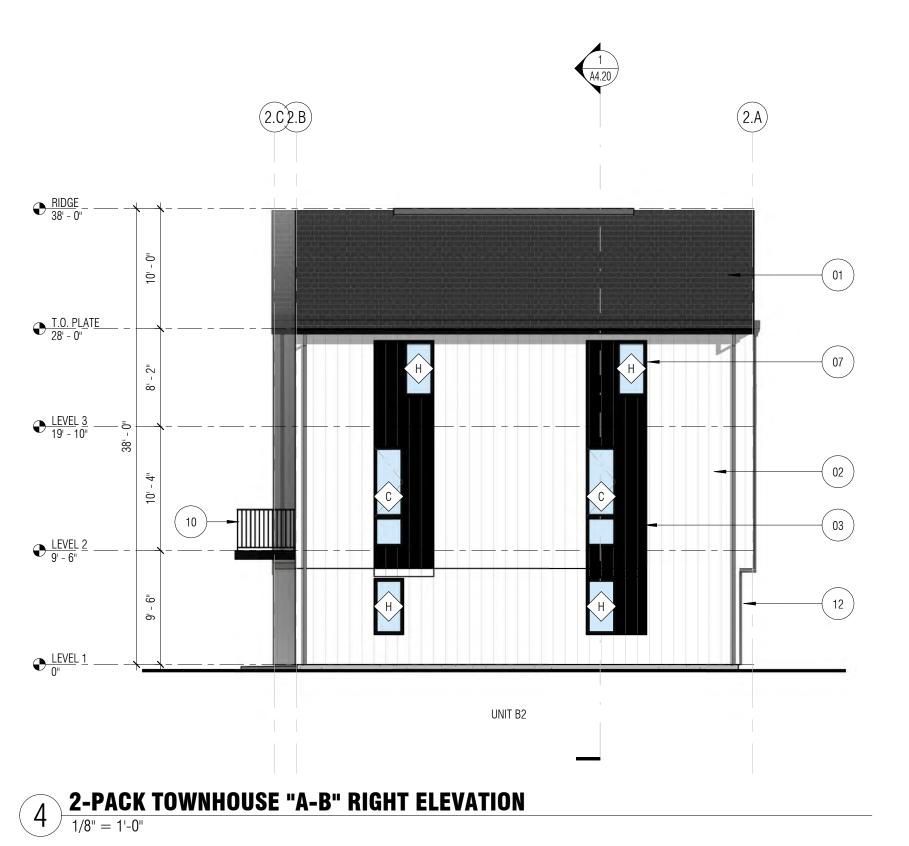

GENERAL NOTES

- REFER TO SHEET A2.00 FOR EXTERIOR BUILDING PRODUCT IMAGES.
 REFER TO SHEET G1.02 FOR ZONING HEIGHT LIMIT AND GRADE INFORMATION.
 REFER TO ENLARGED SITE PLAN A1.21 AND A1.22 FOR UNIT FINISH FLOOR ELEVATIONS.
- ELEVATIONS.


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- 10 METAL RAILING BLACK
- (11) GARAGE DOOR BLACK
- (12) DOWNSPOUT / GUTTER BLACK



Vellum



CITY OF BELLINGHAM STAMP AREA

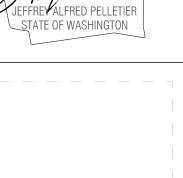STREAM BELLINGHAM TOWNHOMES

É

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ISSUANCES

DATE DESCRIPTION

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4/14/2023 LAND USE APP RESUBMITTAL

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BOARD & VELLUM PROJECT #: 2021170.0

2021-0105

04.12.2023

PLOT DATE:

COB PROJECT #:

BUILDING ELEVATIONS -2-PACK TH "A-B" UNITS

A3.20


0' 4' 8' 16' 32'

2.3 2.2 4.5 4.3 4.4 2.1 5.3 5.2 2.4 4.6 4.7 5.1 4.1 4.2 KEY PLAN








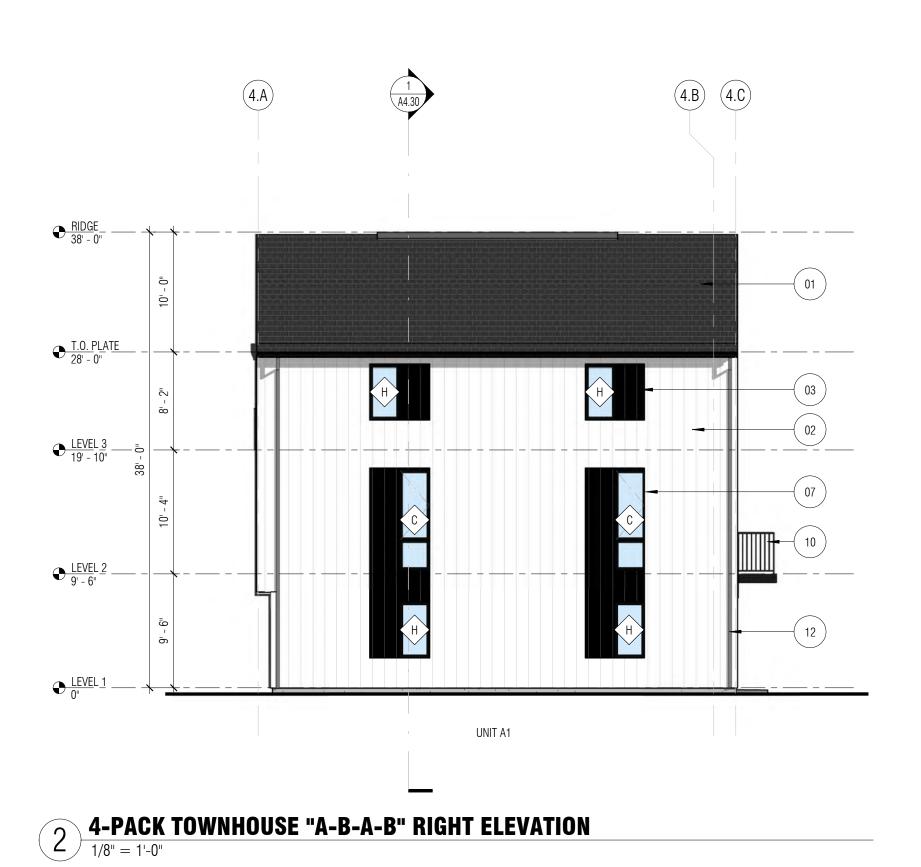



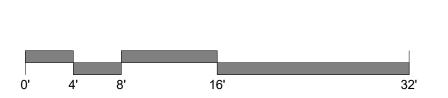

GENERAL NOTES


- REFER TO SHEET A2.00 FOR EXTERIOR BUILDING PRODUCT IMAGES.
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- 9 VINYL SLIDING DOOR BLACK
- 10 METAL RAILING BLACK
- (11) GARAGE DOOR BLACK
- 12 DOWNSPOUT / GUTTER BLACK

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BELLINGHAM MES

STREAM B TOWNHON

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2021-0105

PLOT DATE: 04.12.2023

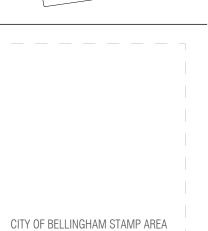COB PROJECT #:

BUILDING ELEVATIONS -

4-PACK TH "A-B-A-B" UNITS

SHEET NO.:



(5.2)

GARAGE ENTRY

UNIT A1

5.1

(5.6)

GARAGE ENTRY

UNIT A1M

5-PACK TOWNHOUSE "A-B-A-B-A" GARAGE ELEVATION

1/8" = 1'-0"

GARAGE ENTRY


UNIT B1M


GARAGE ENTRY

UNIT A2


GARAGE ENTRY

UNIT B1

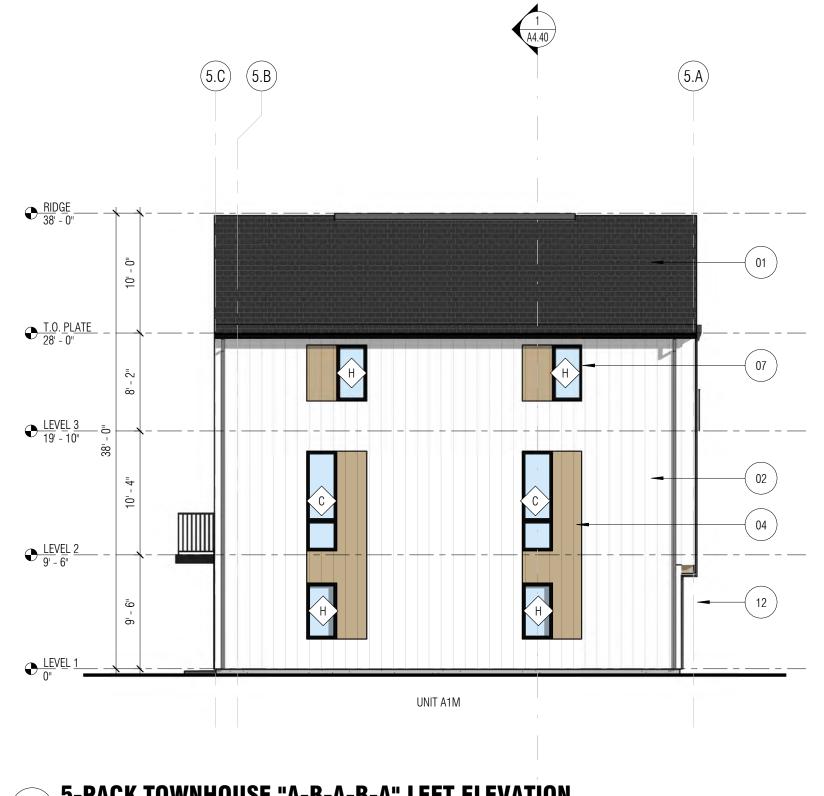

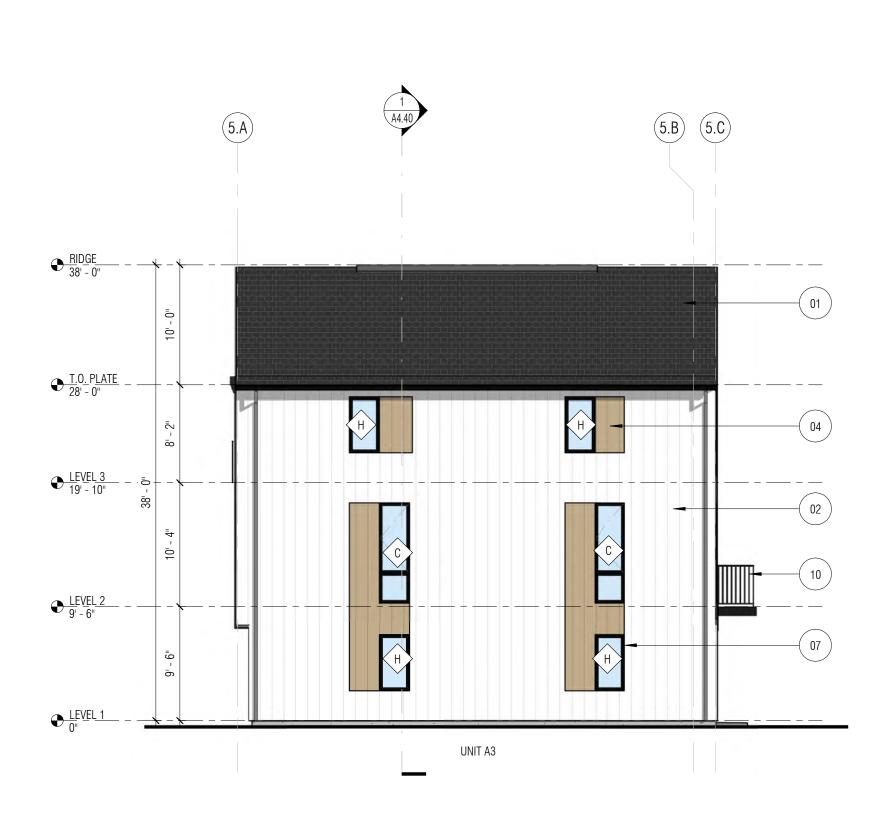

5-PACK TOWNHOUSE "A-B-A-B-A" RIGHT ELEVATION 1/8" = 1'-0"

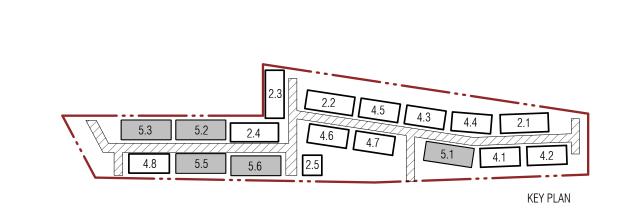

GENERAL NOTES

- REFER TO SHEET A2.00 FOR EXTERIOR BUILDING PRODUCT IMAGES.
 REFER TO SHEET G1.02 FOR ZONING HEIGHT LIMIT AND GRADE INFORMATION.
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- 8 VINYL DOOR BLACK
- 9 VINYL SLIDING DOOR BLACK
- 10 METAL RAILING BLACK
- (11) GARAGE DOOR BLACK 12 DOWNSPOUT / GUTTER - BLACK

CITY OF BELLINGHAM STAMP AREA

Vellum

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9858 REGISTERED ARCHITECT

STATE OF WASHINGTON

BELLINGHAM MES STREAM B TOWNHON

REVISION DATE DESCRIPTION

ISSUANCES DATE DESCRIPTION

7/29/2022 LAND USE APPLICATION 1/13/2023 LAND USE APP RESUBMITTAL 4/14/2023 LAND USE APP RESUBMITTAL

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COB PROJECT #: 2021-0105

PLOT DATE: 04.12.2023

BUILDING ELEVATIONS -5-PACK TH 'A-B-A-B-A" UNITS

SHEET NO.:



5-PACK TOWNHOUSE "A-B-A-B-A" LEFT ELEVATION 1/8" = 1'-0"


BED 2 T.O. PLATE LOW ROOF 10' - 0" F.1 <u>LEVEL 2 - "C-C" TH</u> -—(E.1) E.1 <u>LIVING / DINING / KITCHEN</u> LIVING/DINING/KITCHEN UNIT C1 UNIT C1M

<u>KITCHEN</u>

2-PACK TOWNHOUSE (C-C) - BUILDING SECTION - LONGITUDINAL

1/8" = 1'-0"

 $3 \frac{\text{2-PACK TOWNHOUSE (C-C)} - \text{BUILDING SECTION THROUGH LIVING}}{1/8" = 1"-0"}$

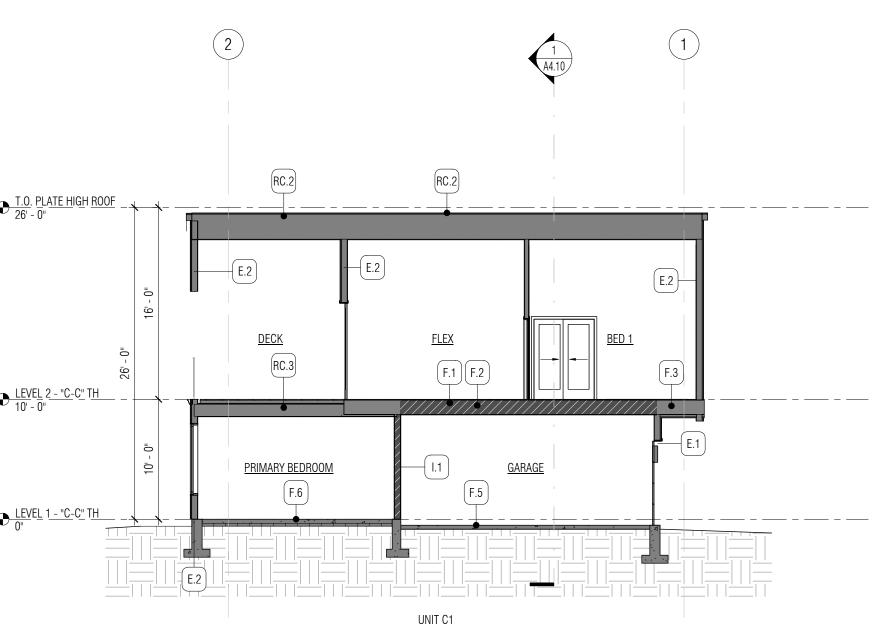

2-PACK TOWNHOUSE (C-C) - BUILDING SECTION THROUGH GARAGE



WALL LEGEND

NEW WALL NEW CONC WALL

1-HR RATED ASSEMBLY

Board

CITY OF BELLINGHAM STAMP AREA

BELLINGHAM MES

DESCRIPTION

STREAM B TOWNHON

ISSUANCES

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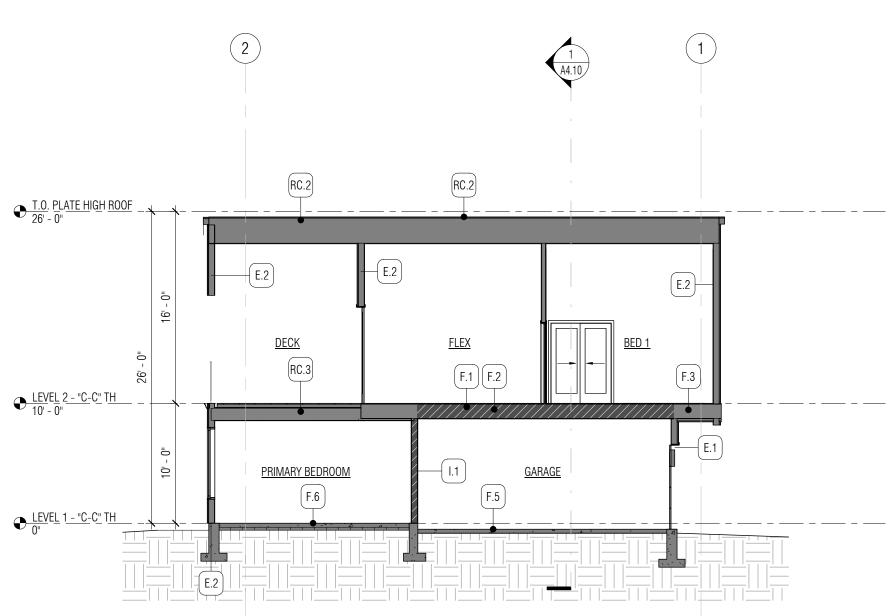
COB PROJECT #:


PLOT DATE:

BUILDING SECTIONS -2-PACK TH "C-C" UNITS SHEET NO.:


A4.10

04.12.2023



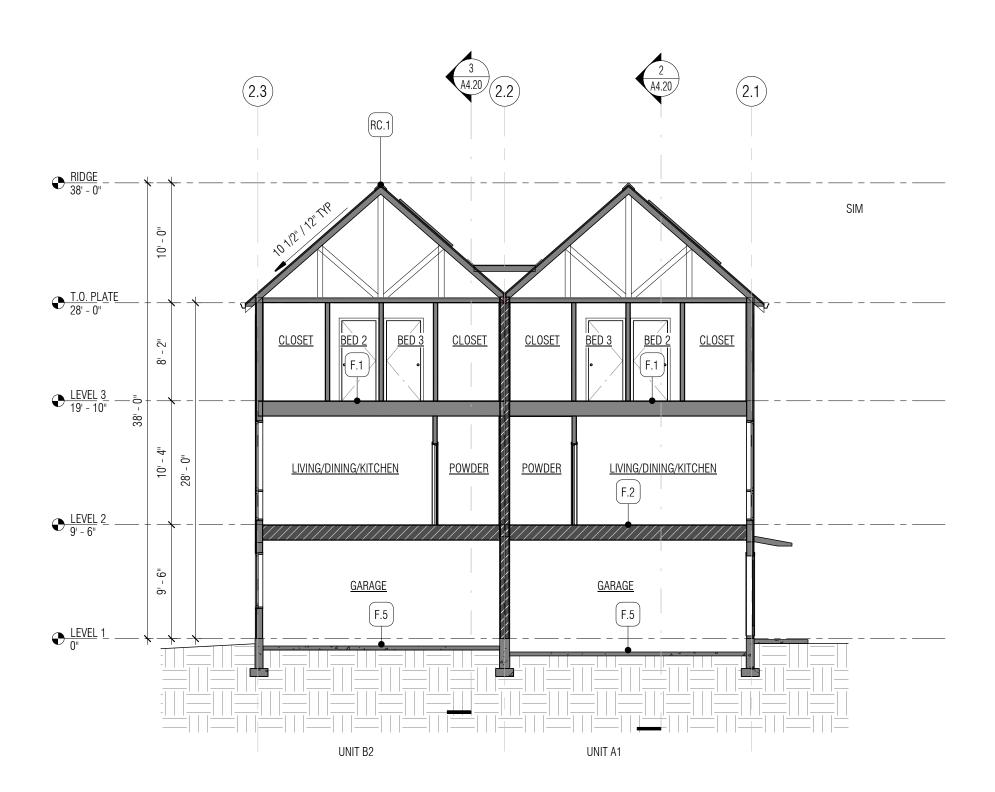

2-PACK TOWNHOUSE (A-B) - LONG SECTION

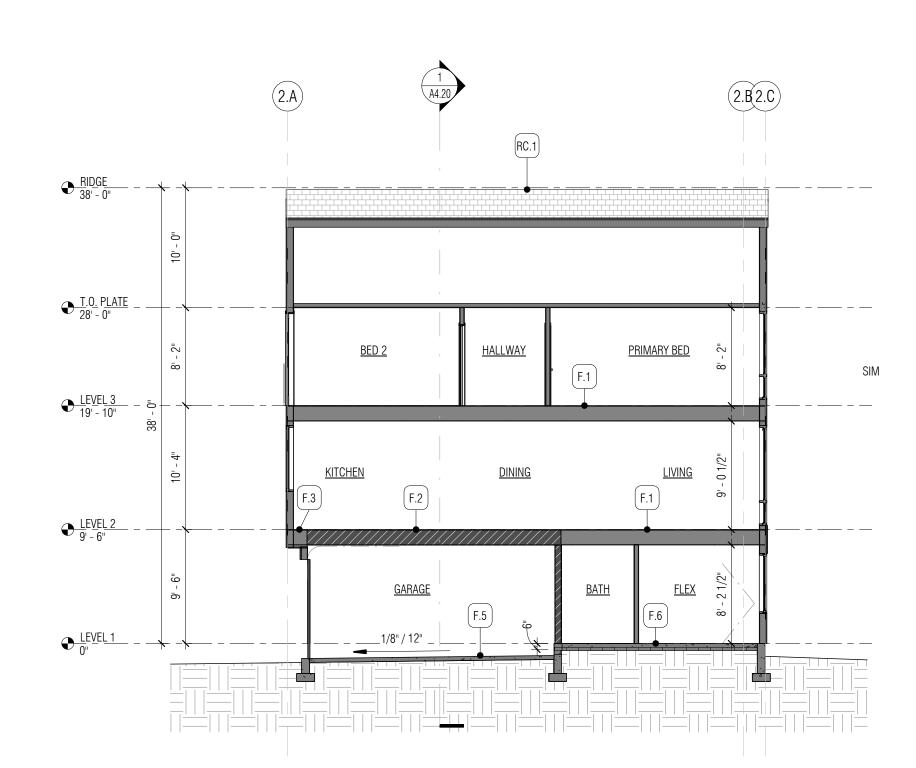



2-PACK TOWNHOUSE (A-B) - SHORT SECTION THROUGH UNIT A.1 1/8" = 1'-0"

GENERAL NOTES - BUILDING SECTIONS


SEE SHEET FOR GRADES FOR ALL BUILDINGS.
 REFER TO ENLARGED SITE PLAN A1.21 AND A1.22 FOR FINISH FLOOR ELEVATIONS.
 FOR INSULATION VALUES, REFER TO HORIZONTAL ASSEMBLIES SHEET A2.01 AND VERTICAL ASSMEBLIES SHEET A2.02.

WALL LEGEND

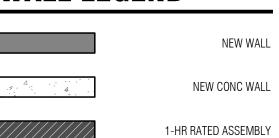

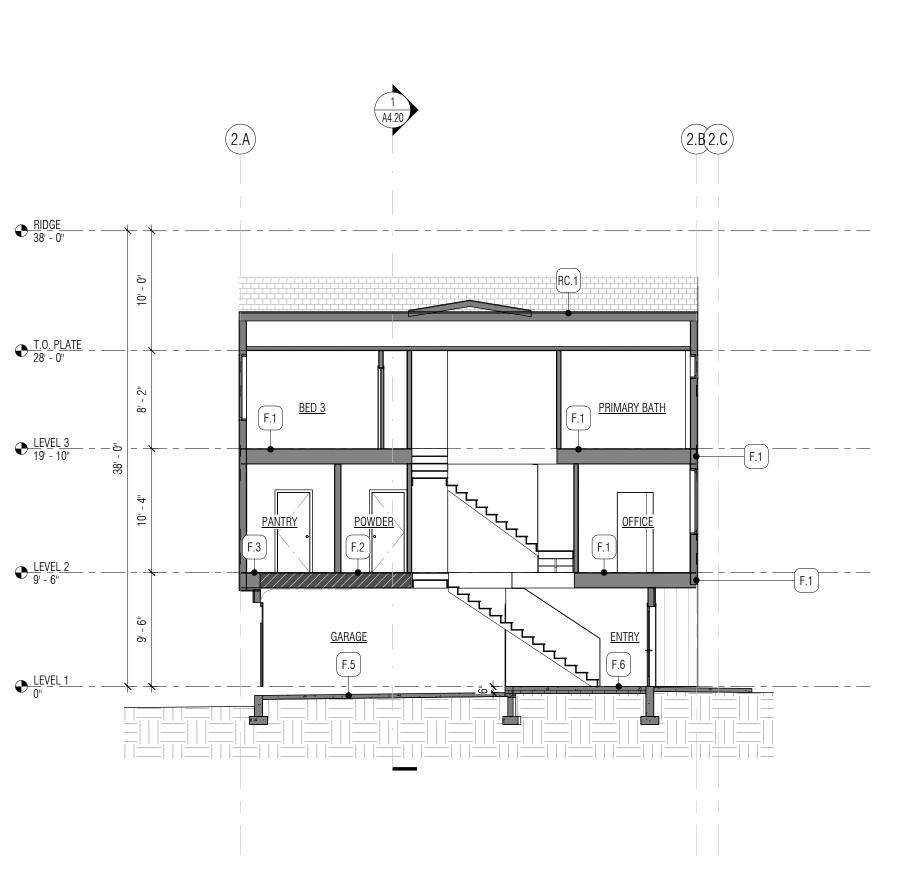

2-PACK TOWNHOUSE (A-B) - SHORT SECTION THROUGH UNIT B.2

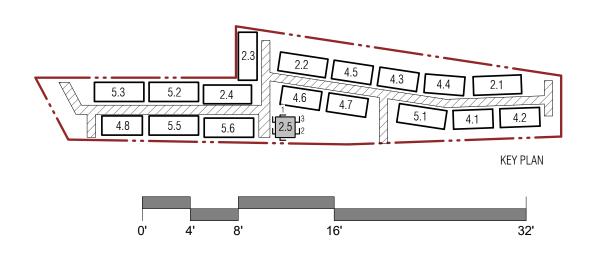

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CITY OF BELLINGHAM STAMP AREA

BELLINGHAM MES STREAM B TOWNHON

REVISION DATE DESCRIPTION

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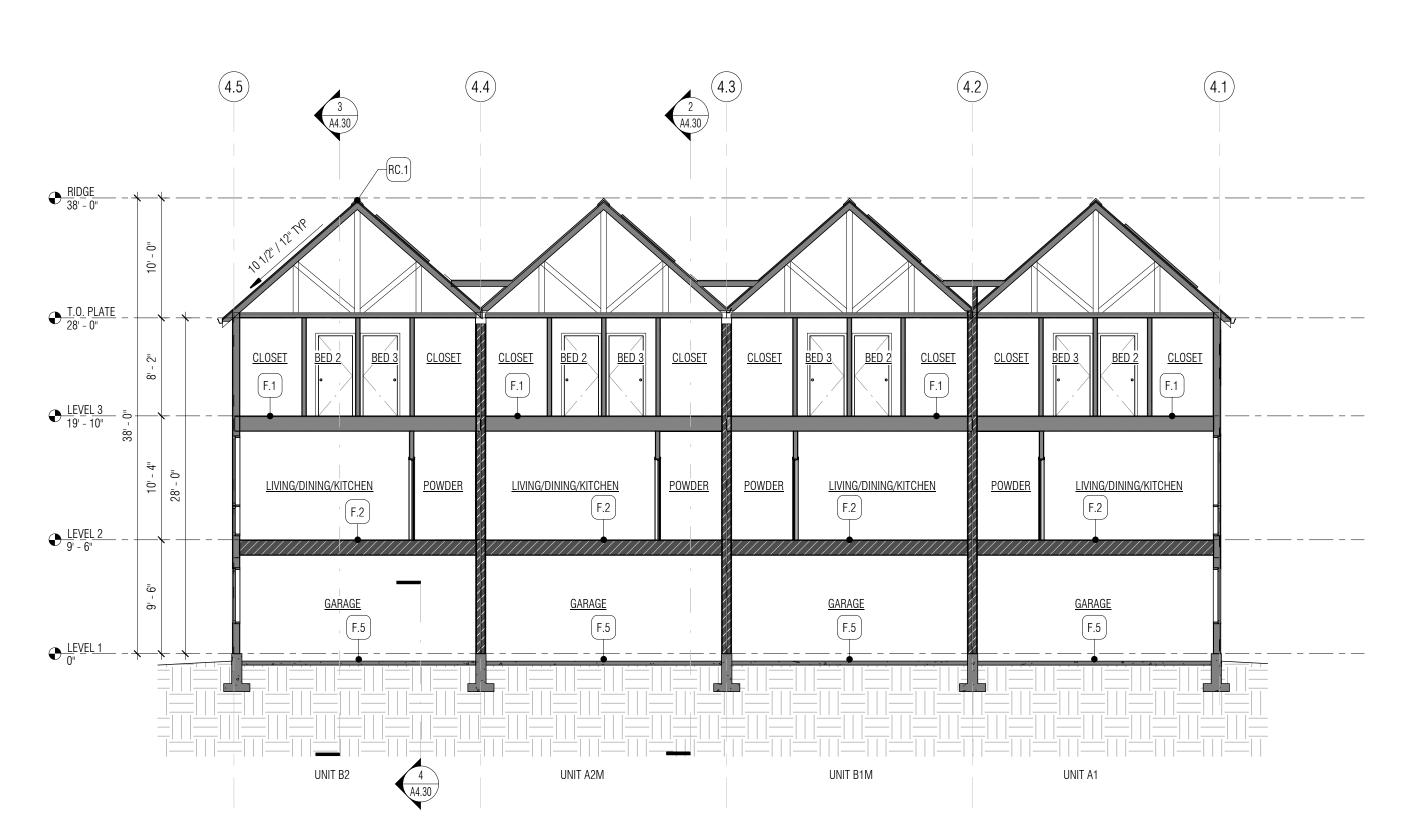
COB PROJECT #:

PLOT DATE:


BUILDING SECTIONS -2-PACK TH "A-B" UNITS

SHEET NO.:

04.12.2023




4-PACK TOWNHOUSE "A-B-A-B" - LONG SECTION

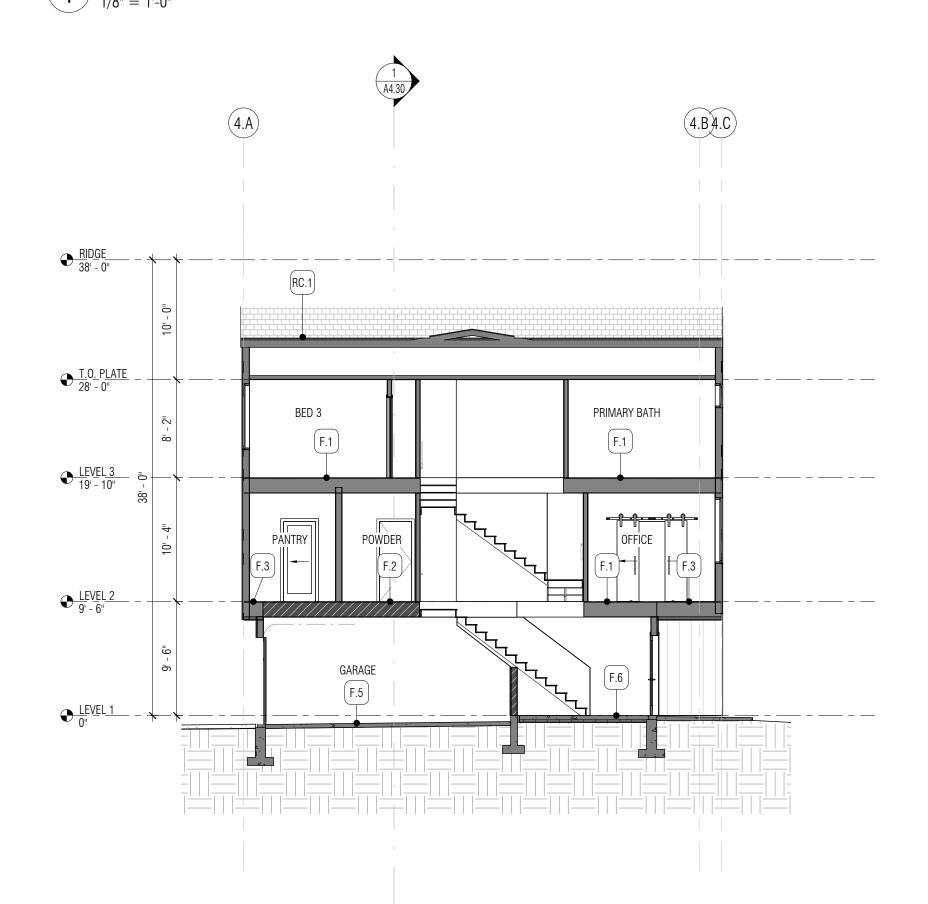

4-PACK TOWNHOUSE "A-B-A-B" - SHORT SECTION THROUGH UNIT A2.M ENTRY

1/8" = 1'-0"

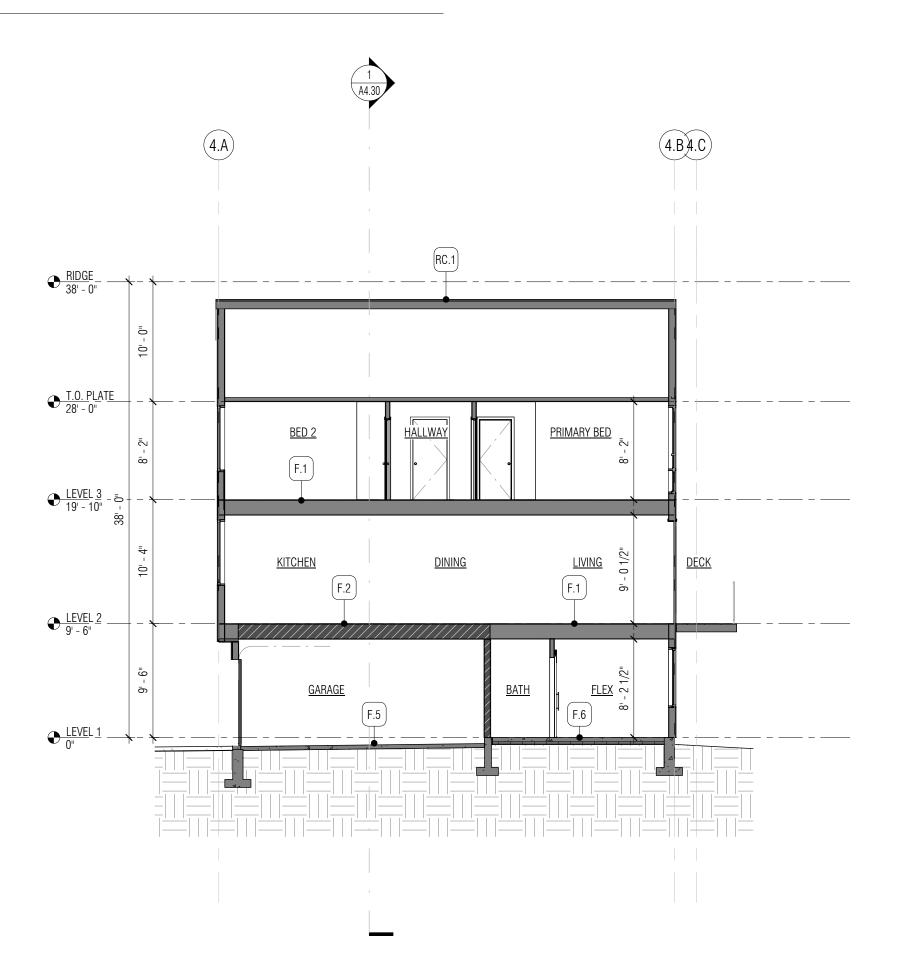

4-PACK TOWNHOUSE "A-B-A-B" - SHORT SECTION THROUGH UNIT B.2

GENERAL NOTES - BUILDING SECTIONS

SEE SHEET FOR GRADES FOR ALL BUILDINGS.
 REFER TO ENLARGED SITE PLAN A1.21 AND A1.22 FOR FINISH FLOOR ELEVATIONS.
 FOR INSULATION VALUES, REFER TO HORIZONTAL ASSEMBLIES SHEET A2.01 AND VERTICAL ASSMEBLIES SHEET A2.02.

WALL LEGEND

NEW WALL NEW CONC WALL 1-HR RATED ASSEMBLY

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CITY OF BELLINGHAM STAMP AREA

BELLINGHAM MES

DESCRIPTION

REVISION DATE

STREAM B TOWNHON

ISSUANCES DATE DESCRIPTION


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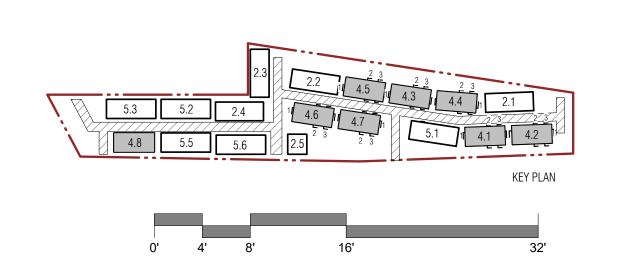
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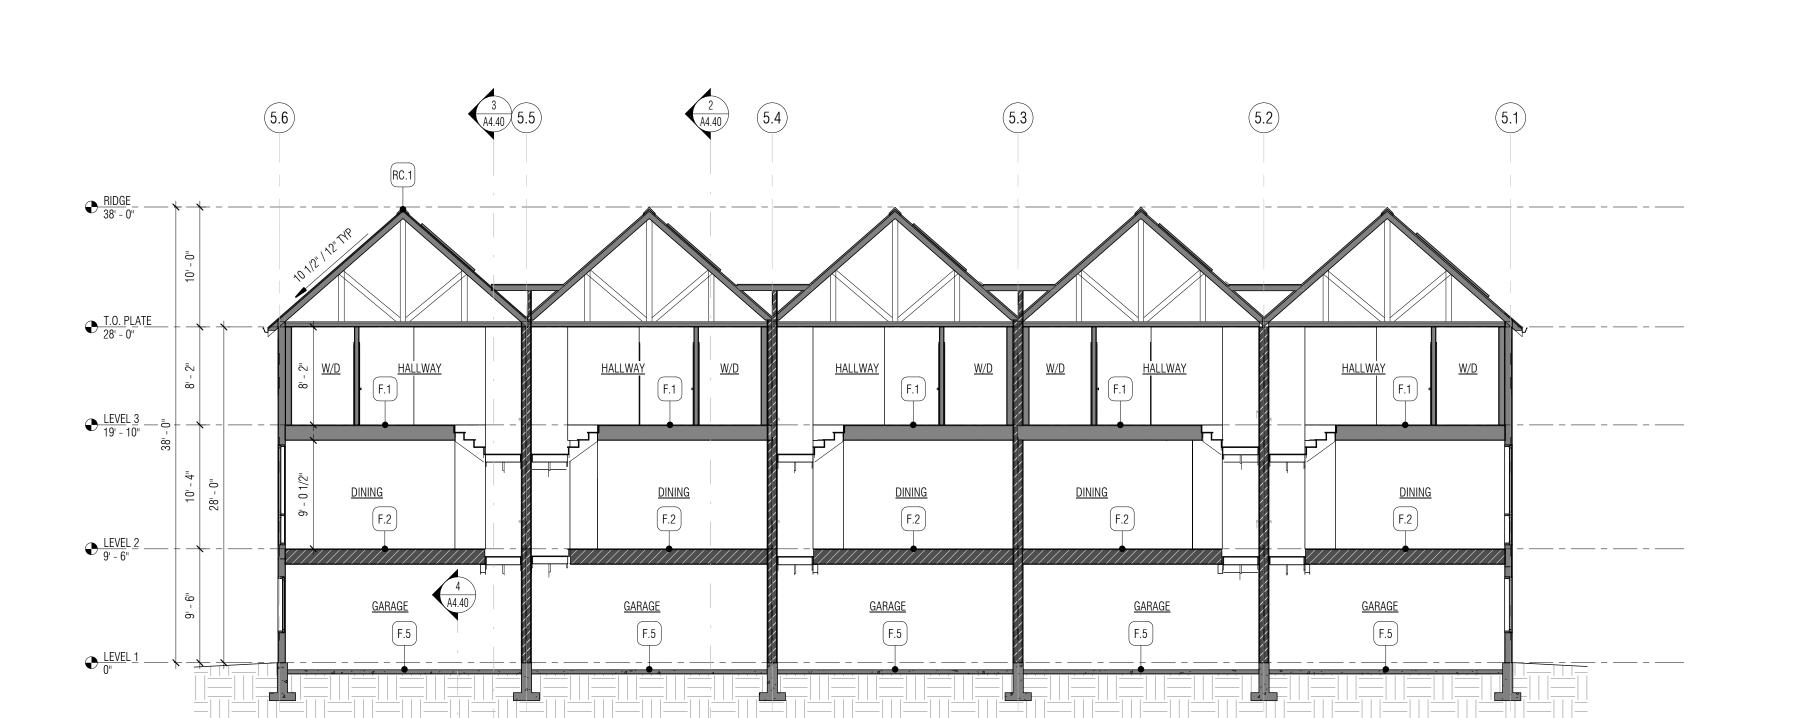
PLOT DATE: 04.12.2023

BUILDING SECTIONS -4-PACK TH "A-B-A-B" UNITS SHEET NO.:



4-PACK TOWNHOUSE "A-B-A-B" - SHORT SECTION THRU GARAGE AT INTERIOR 4 TRANSITION 1/8" = 1'-0"




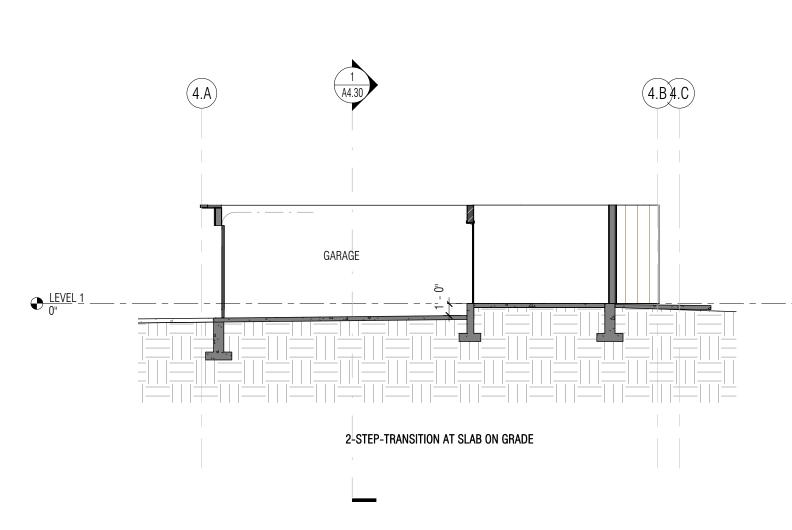


UNIT B1

5-PACK TOWNHOUSE "A-B-A-B-A" - LONG SECTION

UNIT A1M

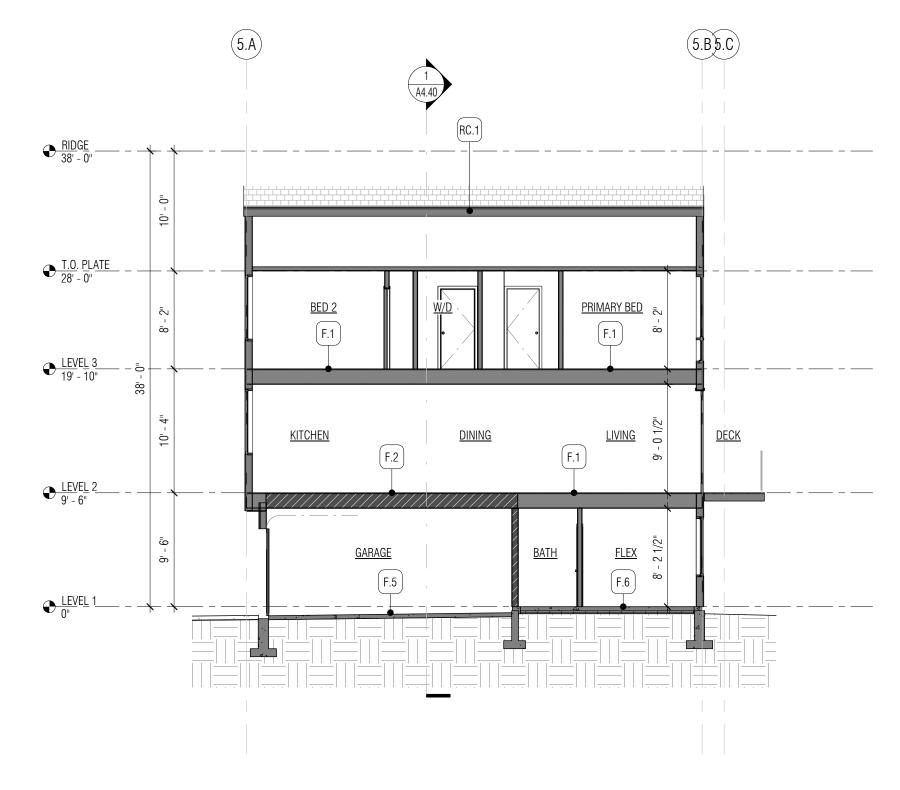



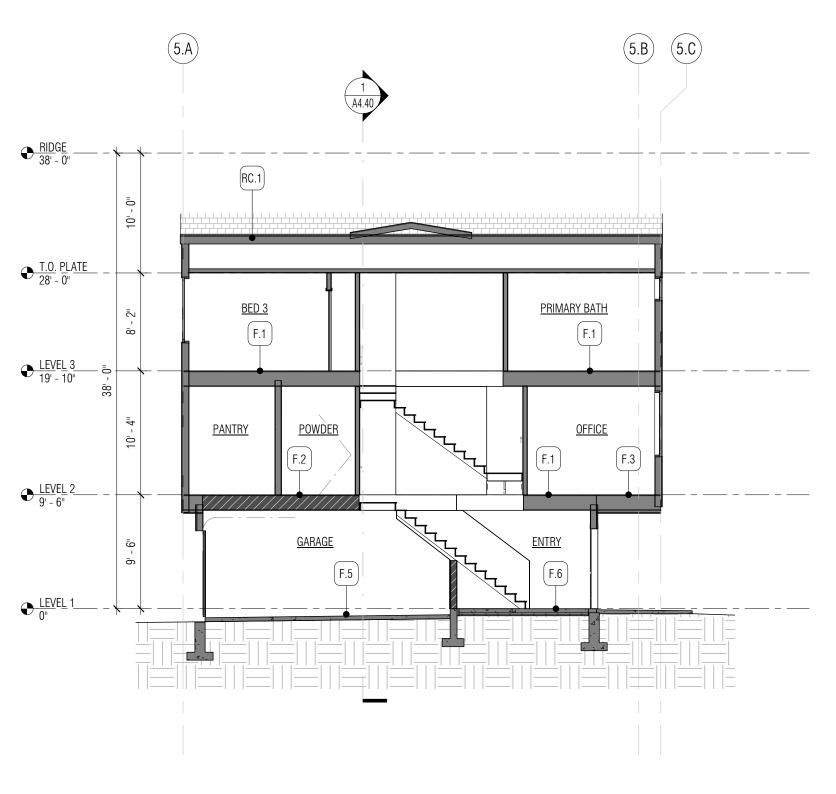

UNIT A1

5-PACK TOWNHOUSE "A-B-A-B-A" - SHORT SECTION THROUGH UNIT A1.M


1/8" = 1'-0"


GENERAL NOTES - BUILDING SECTIONS


SEE SHEET FOR GRADES FOR ALL BUILDINGS.
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WALL LEGEND






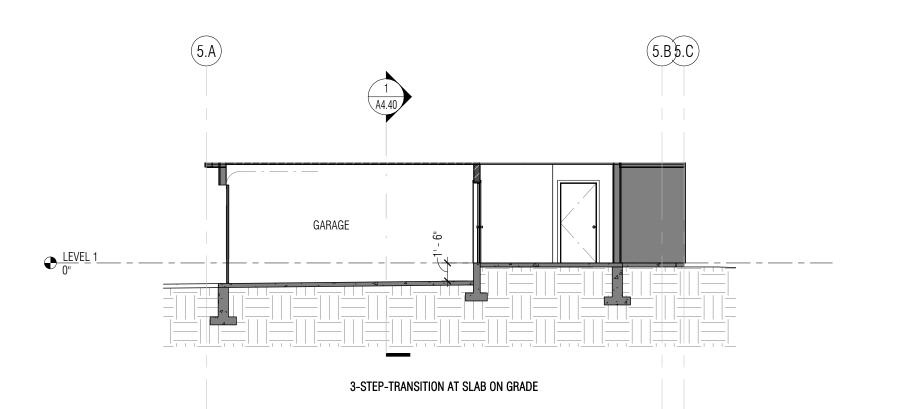

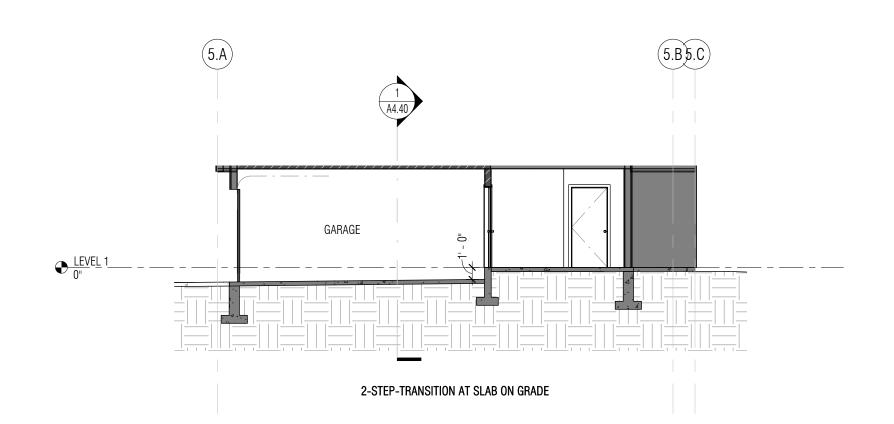


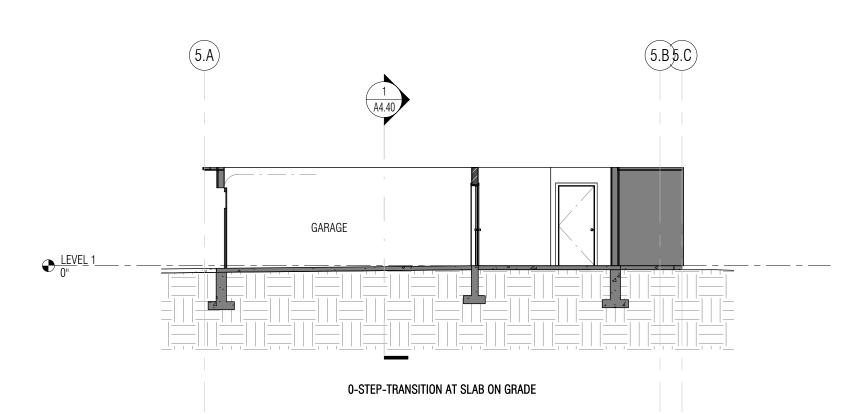5-PACK TOWNHOUSE "A-B-A-B-A" - SHORT SECTION THRU GARAGE AT INTERIOR

TRANSITION1/8" = 1'-0"

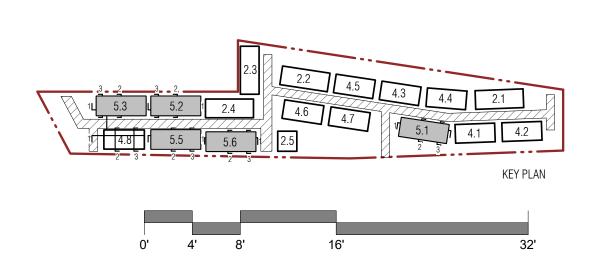



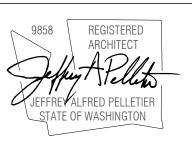

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BELLINGHAM MES

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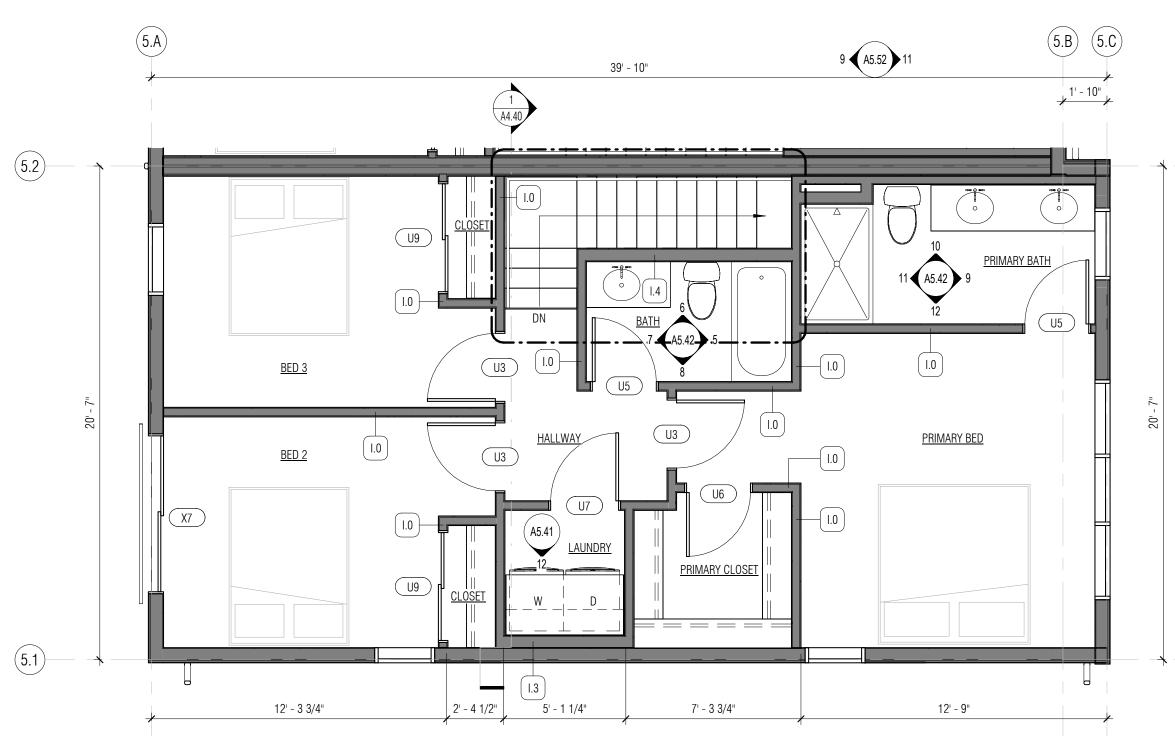
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COB PROJECT #: 2021-0105

PLOT DATE:

BUILDING SECTIONS - 5-PACK TH "A-B-A-B-A" UNITS SHEET NO.:


04.12.2023



3 FLOOR PLAN - LEVEL 3

FLOOR PLAN KEY UNIT PLAN KEY

"A-B-A-B-A" TOWNHOUSE

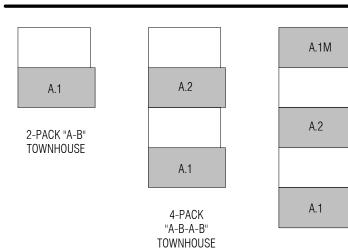


TOWEL BAR TOWEL RING ROBE HOOK TOILET PAPER HOLDER

GENERAL NOTES - UNIT PLANS

- 1. ALL INTERIOR WALLS ARE I.O UNO. PROVIDE 3-1/2" SOUND INSULATION IN COMMON PARTY WALLS.
- ALL EXTERIOR WALLS ARE E.1 UNO.
 ALL EXTERIOR DIMENSIONS ARE MEASURED FROM GRID LINE TO GRID LINE OR FACE OF FRAMING. ALL INTERIOR
- DIMENSIONS ARE FROM FACE OF STUD. 4. GRIDS ARE ALIGNED WITH THE EXTERIOR FACE OF FRAMING AT EXTERIOR WALLS AND ALIGNED WITH THE CENTER OF THE PARTY-WALLS.
 - WINDOW DIMENSIONS ARE GIVEN AS NOMINAL MEASUREMENTS.
 - DOOR ROUGH OPENINGS ARE 4" OFF STUD FACE OF PERP. WALL (TO HINGED SIDE OF THE DOOR) UNO
- ALL FINISH FLOOR MATERIALS TO ALIGN WITH ADJACENT FLOOR FINISH DIMENSIONS AT POSTS ARE TO CENTERLINES UNO - VERIFY ALL STRUCTURAL LOCATIONS WITH FRAMING PLANS
- 9. SEE EXTERIOR ELEVATION SHEETS FOR WINDOW TAGS
- 10. SEE SHEETS GENERAL SHEETS CODE, DIMENSIONING AND GENERAL NOTES 11. SEE SHEET A7.00 SERIES FOR DOOR & WINDOW SCHEDULE.


12. THE MAIN ELECTRICAL SERVICE OR FEEDER PANEL FOR EACH DWELLING UNIT SHALL HAVE A RESERVED SPACE TO

ALLOW INSTALLATION OF A DUAL POLE CIRCUIT BREAKER FOR FUTURE SOLAR ELECTRIC INSTALLATION AND SHALL BE LABELED 'FOR FUTURE SOLAR ELECTRIC. 13. A PERMANENT CERTIFICATE, INDICATING THE BOUNDARIES AND STRUCTURAL PROVISIONS OF THE SOLAR-READY ZONE, SHALL BE POSTED NEAR THE ELECTRICAL DISTRIBUTION PANEL, WATER HEATER OF OTHER CONSPICUOUS LOCATION.

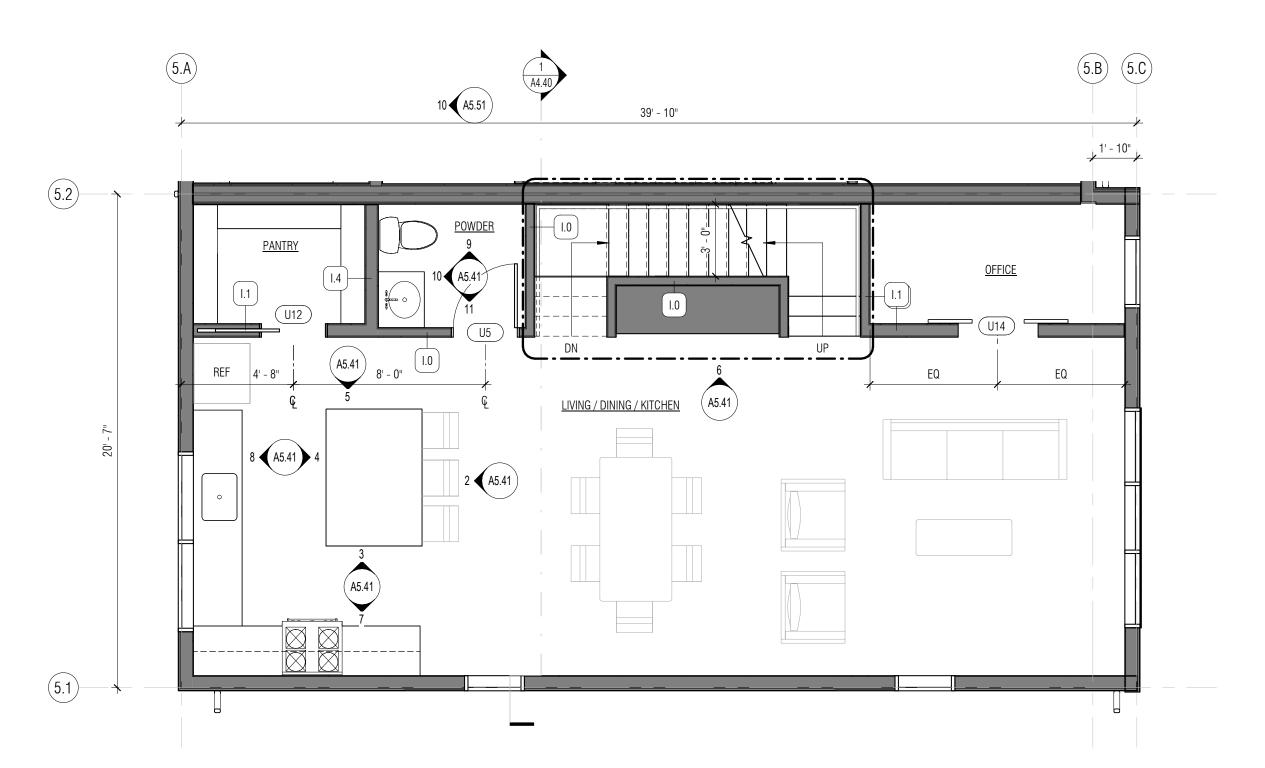


PLOOR PLAN - LEVEL 2

1/4" = 1'-0"

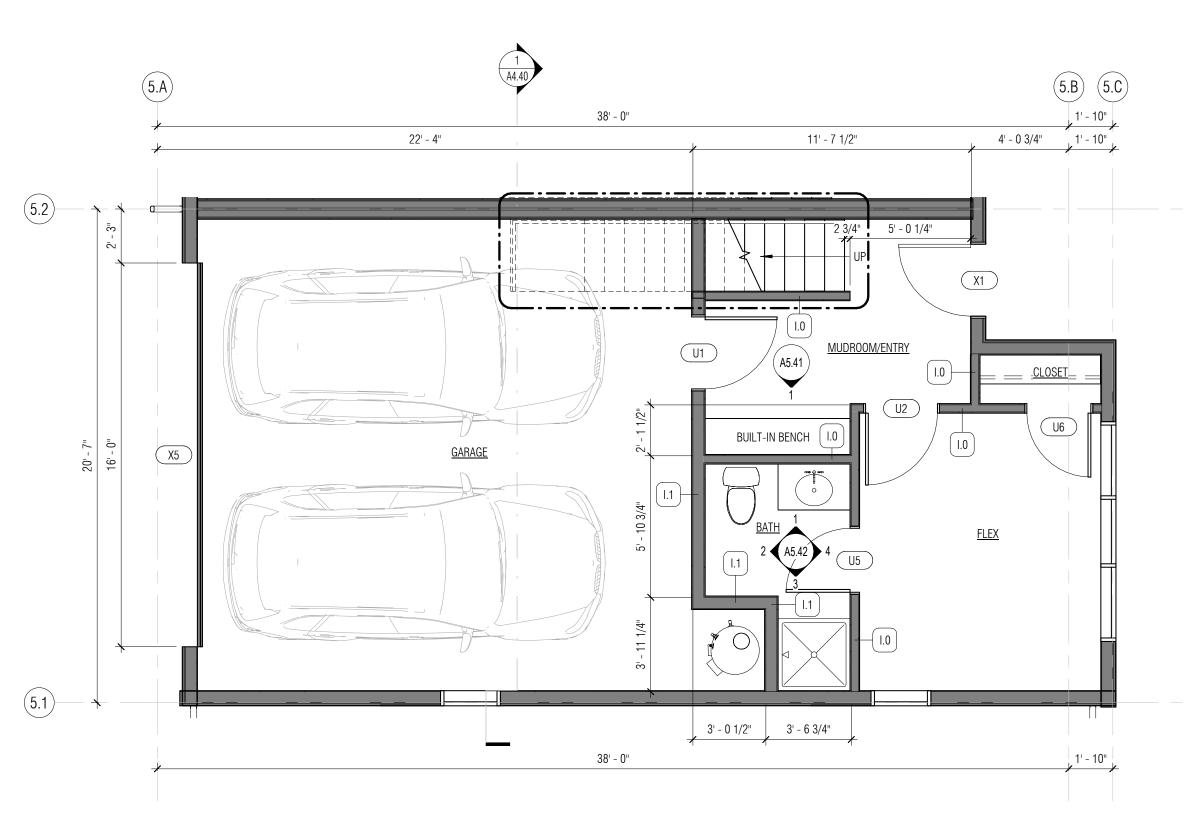

1 UNIT PLAN - LEVEL 1

1/4" = 1'-0"

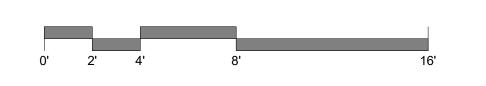



9858 | REGISTERED

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CITY OF BELLINGHAM STAMP AREA

BELLINGHAM MES

STREAM B TOWNHON

DESCRIPTION

REVISION DATE

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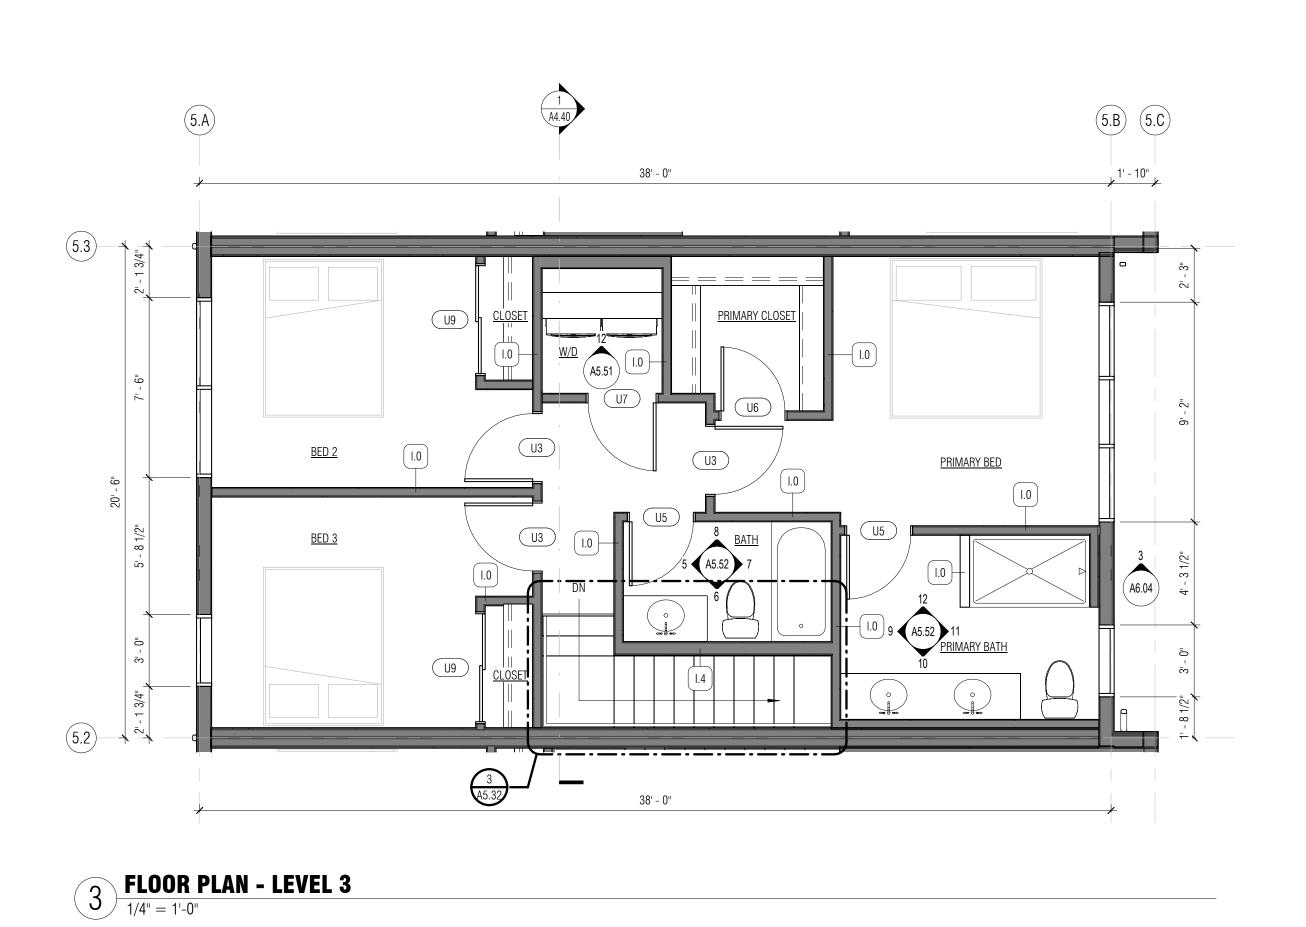
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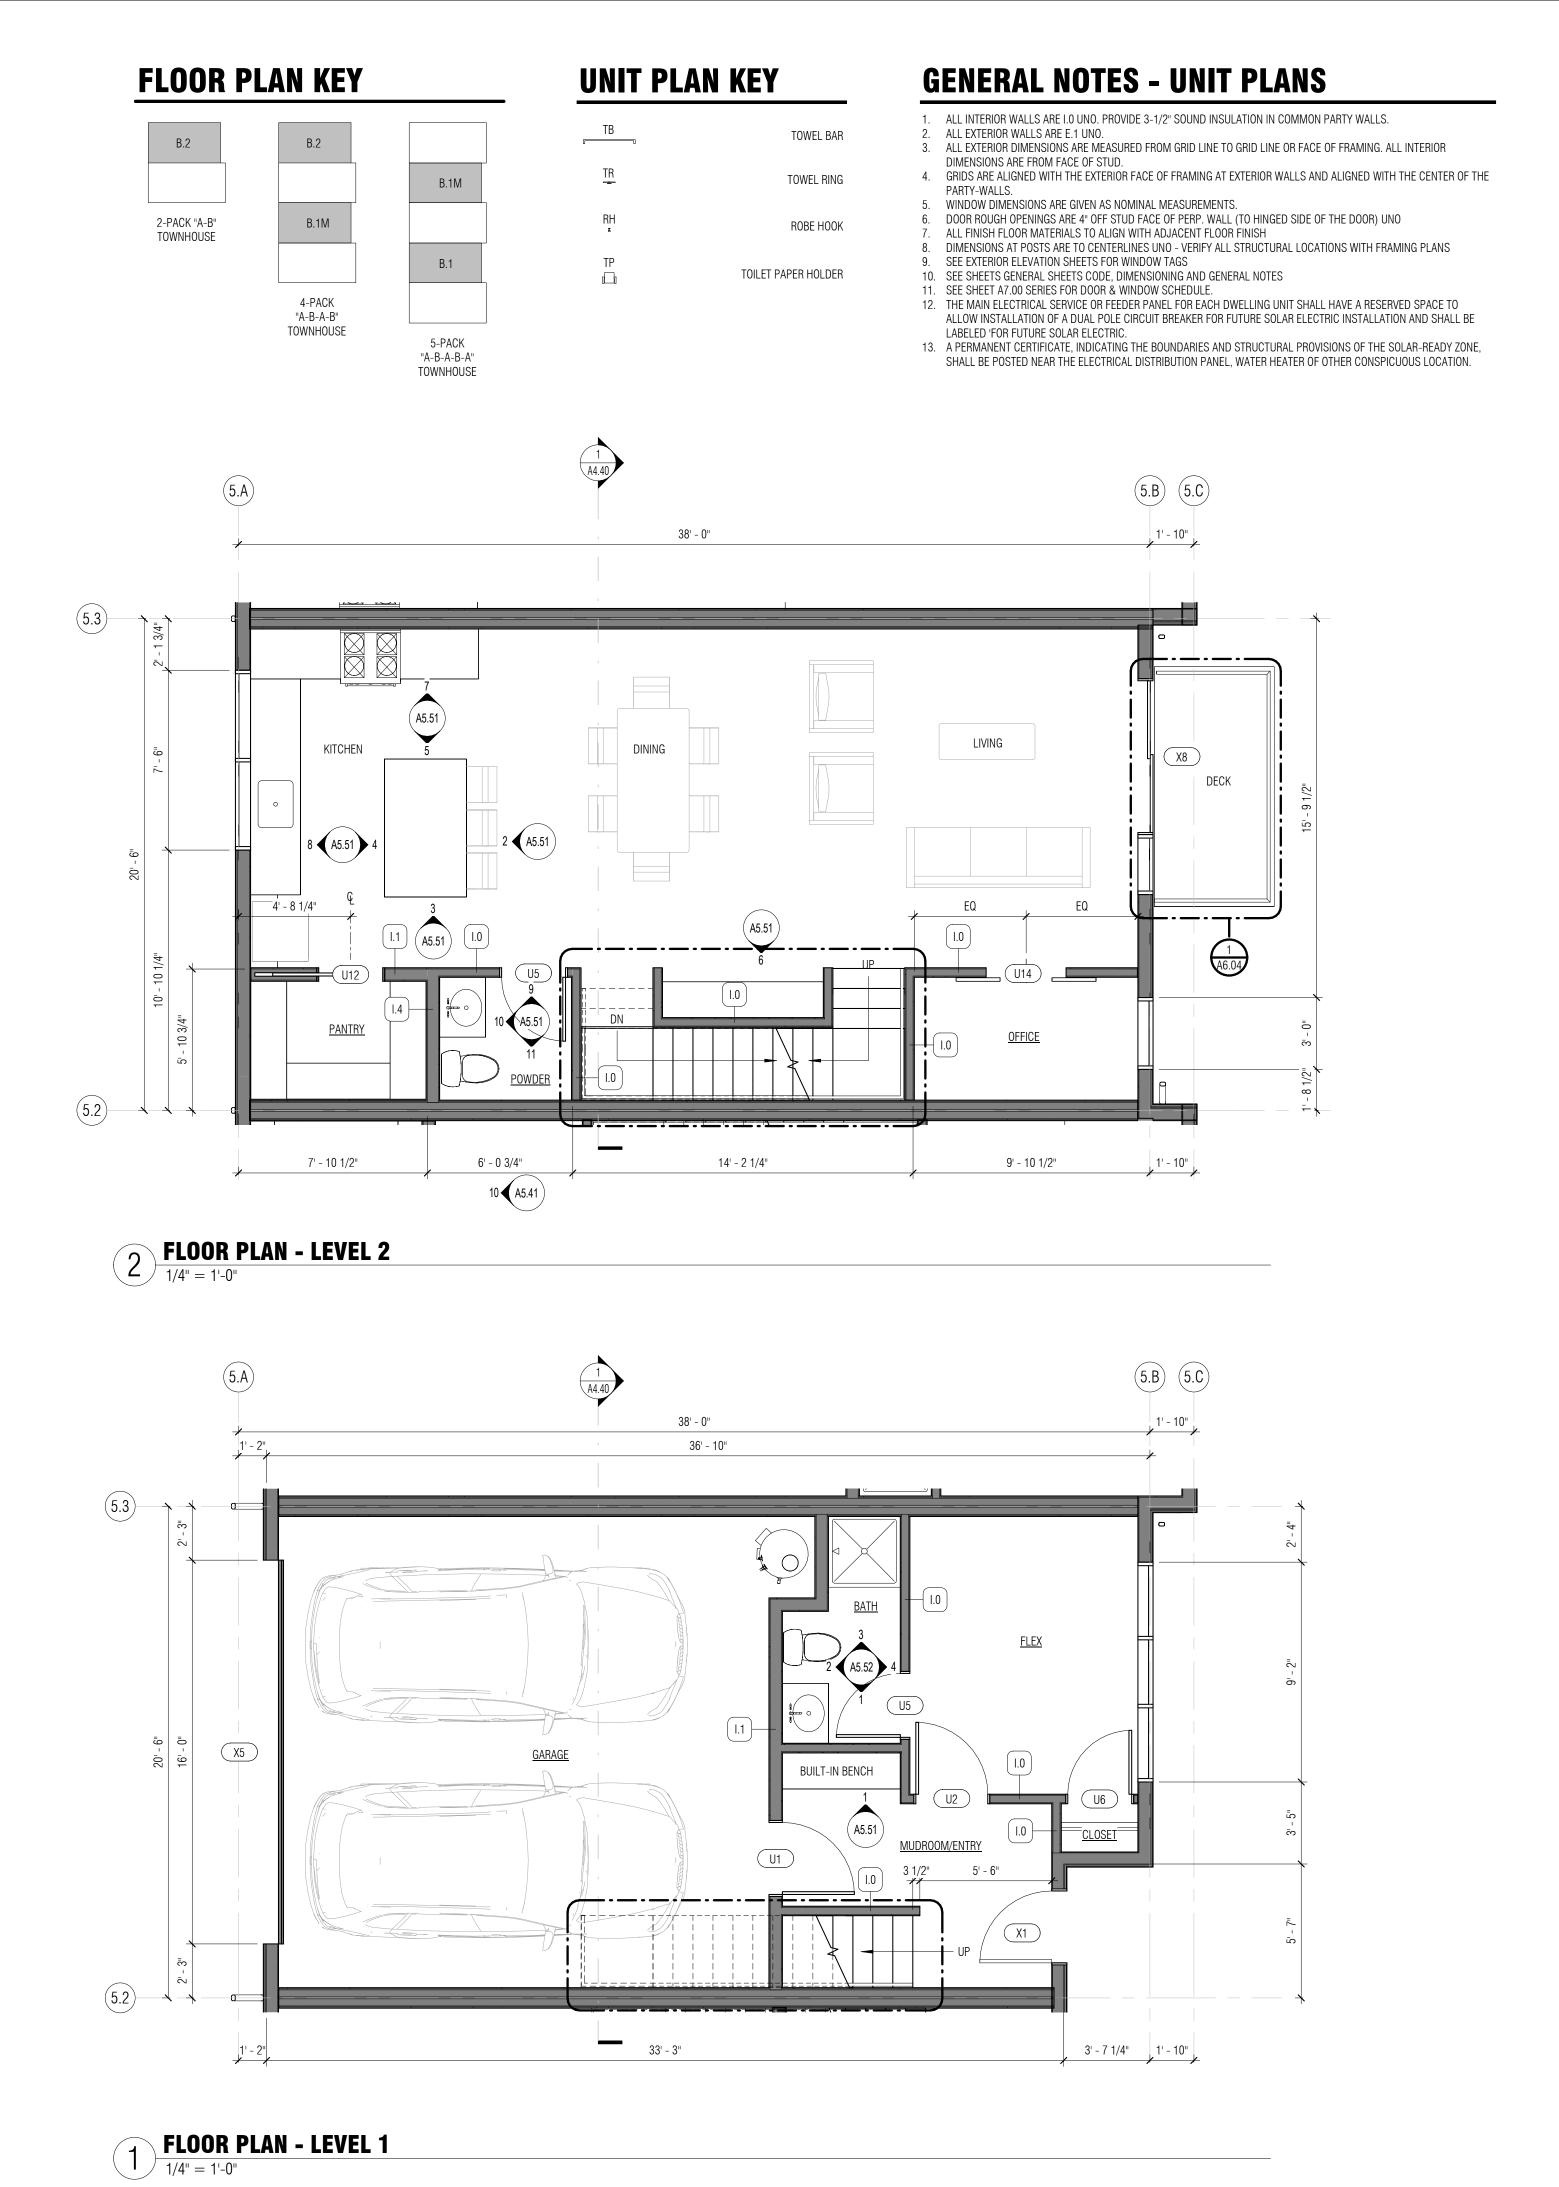
2021-0105 COB PROJECT #:

PLOT DATE: 04.12.2023

UNIT PLANS - TYPE A.1 & A.2 (A.1M OPP)

SHEET NO.:





Vellum AND DESIGN

CTURE AND DES e E. Suite 100 Seattle, WA 98112 dandvellum.com | 206.707.8895

9858 REGISTERED
ARCHITECT

JEFFREY ALFRED PELLETIER
STATE OF WASHINGTON

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CITY OF BELLINGHAM STAMP AREA

STREAM BELLINGHAM
TOWNHOMES
PROJECT ADDRESS:

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PLOT DATE: 04.12.2023

2021-0105

UNIT PLANS - TYPE B.1 & B.2 (B.1M OPP)

SHEET NO.:

COB PROJECT #:

A5.12

2-PACK "C-C" TOWNHOUSE

UNIT PLAN KEY

TOWEL BAR	ТВ
TOWEL RING	TR
ROBE HOOK	RH
TOILET PAPER HOLDER	TP

GENERAL NOTES - UNIT PLANS

- 1. ALL INTERIOR WALLS ARE I.O UNO. PROVIDE 3-1/2" SOUND INSULATION IN COMMON PARTY WALLS.
- ALL EXTERIOR WALLS ARE E.1 UNO.
 ALL EXTERIOR DIMENSIONS ARE MEASURED FROM GRID LINE TO GRID LINE OR FACE OF FRAMING. ALL INTERIOR DIMENSIONS ARE FROM FACE OF STUD.

 4. GRIDS ARE ALIGNED WITH THE EXTERIOR FACE OF FRAMING AT EXTERIOR WALLS AND ALIGNED WITH THE CENTER OF THE
- PARTY-WALLS.
- WINDOW DIMENSIONS ARE GIVEN AS NOMINAL MEASUREMENTS.
 DOOR ROUGH OPENINGS ARE 4" OFF STUD FACE OF PERP. WALL (TO HINGED SIDE OF THE DOOR) UNO
 ALL FINISH FLOOR MATERIALS TO ALIGN WITH ADJACENT FLOOR FINISH
- 8. DIMENSIONS AT POSTS ARE TO CENTERLINES UNO VERIFY ALL STRUCTURAL LOCATIONS WITH FRAMING PLANS
- 9. SEE EXTERIOR ELEVATION SHEETS FOR WINDOW TAGS 10. SEE SHEETS GENERAL SHEETS CODE, DIMENSIONING AND GENERAL NOTES
- SEE SHEET A7.00 SERIES FOR DOOR & WINDOW SCHEDULE.
 THE MAIN ELECTRICAL SERVICE OR FEEDER PANEL FOR EACH DWELLING UNIT SHALL HAVE A RESERVED SPACE TO ALLOW INSTALLATION OF A DUAL POLE CIRCUIT BREAKER FOR FUTURE SOLAR ELECTRIC INSTALLATION AND SHALL BE LABELED 'FOR FUTURE SOLAR ELECTRIC.
- 13. A PERMANENT CERTIFICATE, INDICATING THE BOUNDARIES AND STRUCTURAL PROVISIONS OF THE SOLAR-READY ZONE, SHALL BE POSTED NEAR THE ELECTRICAL DISTRIBUTION PANEL, WATER HEATER OF OTHER CONSPICUOUS LOCATION.



1 FLOOR PLAN - LEVEL 1
1/4" = 1'-0"

2 FLOOR PLAN - LEVEL 2

1/4" = 1'-0"

BELLINGHAM MES REVISION DATE ISSUANCES

മ ്

CITY OF BELLINGHAM STAMP AREA

STREAM B TOWNHON

DESCRIPTION

DATE DESCRIPTION

7/29/2022 LAND USE APPLICATION 1/13/2023 LAND USE APP RESUBMITTAL 4/14/2023 LAND USE APP RESUBMITTAL

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04.12.2023 PLOT DATE:

UNIT PLANS - TYPE C.1 (C.1M OPP)


SHEET NO.:

A5.13


STREAM BELLINGHAM TOWNHOMES

INFILL TOOLKIT LONG PLAT

SITUATED IN A PORTION OF THE SE QUARTER, SECTION 13, TOWNSHIP 38 NORTH, RANGE 2 EAST, W.M., CITY OF BELLINGHAM, WHATCOM COUNTY, WASHINGTON

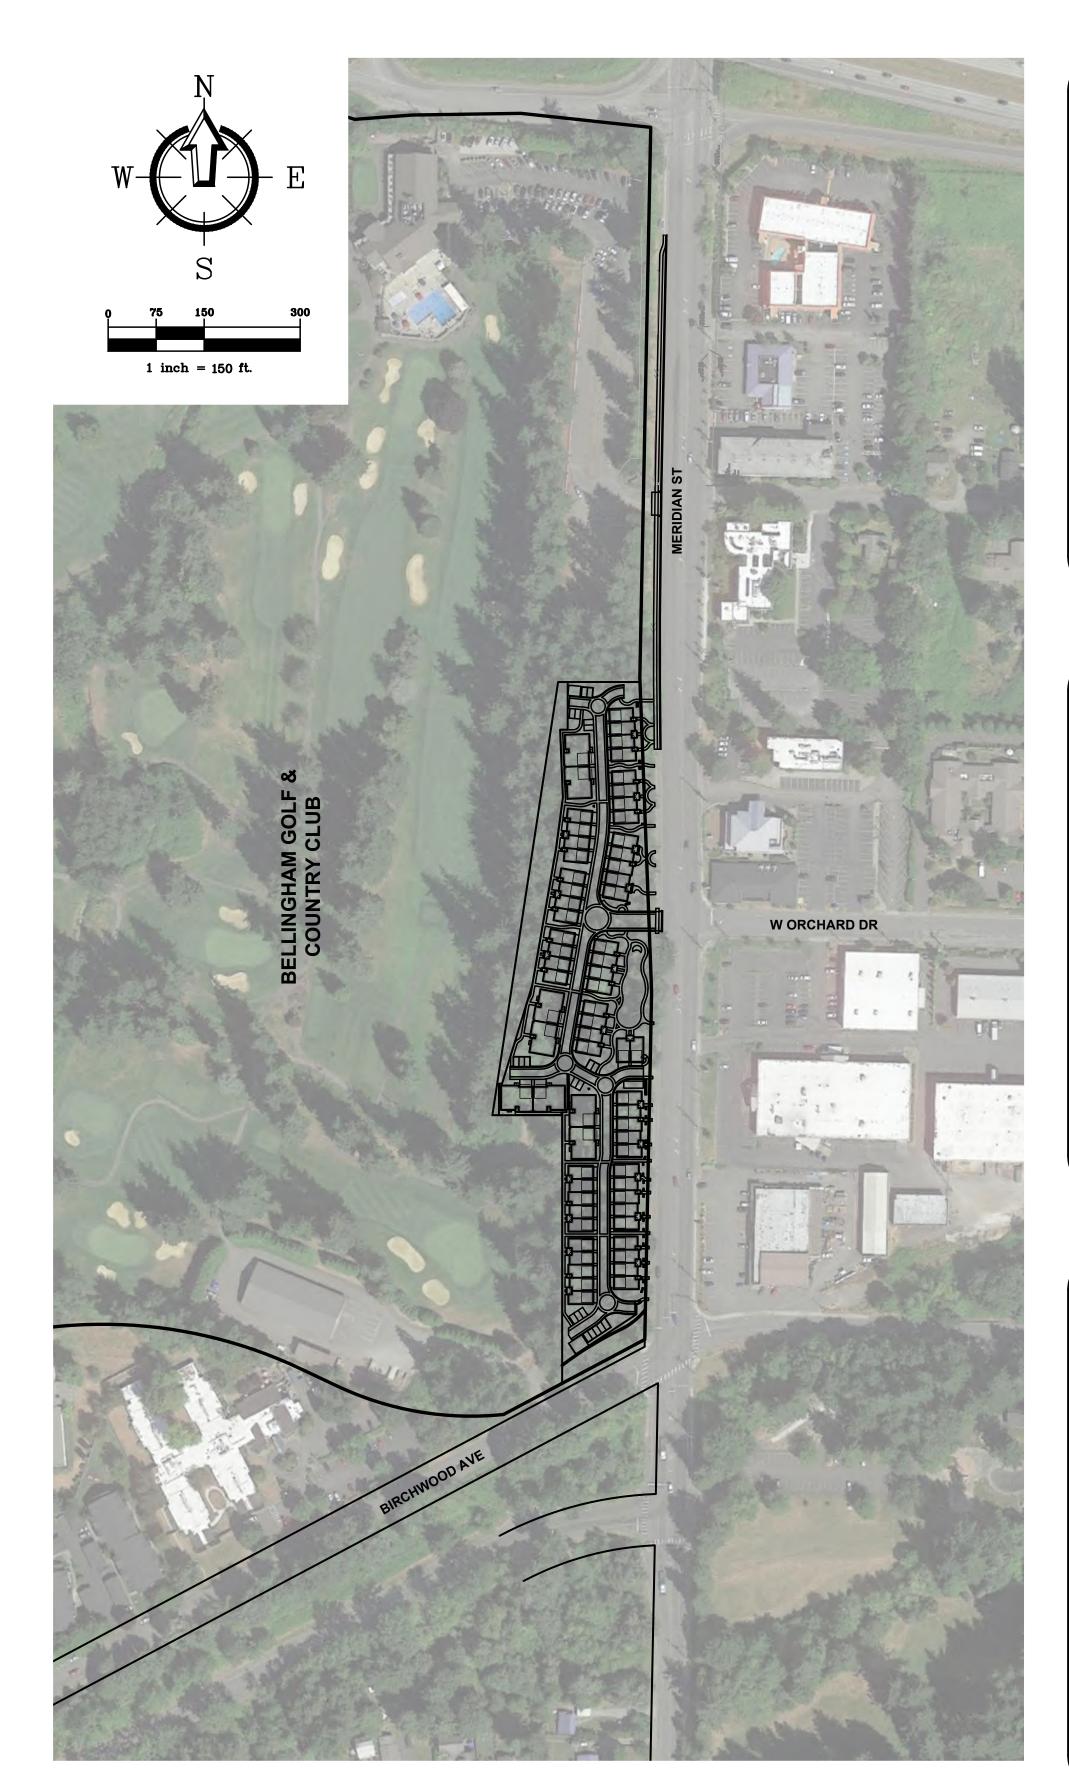

VICINITY MAP

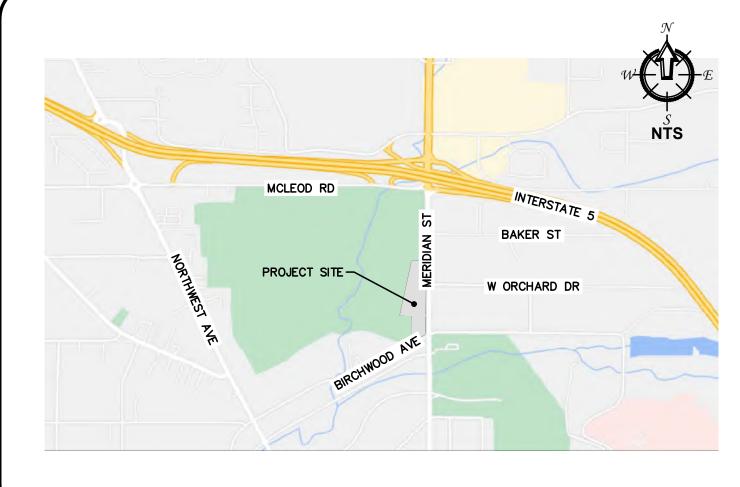

SHEET INDEX

- **COVER SHEET**
- **C1.1 EXISTING CONDITIONS SOUTH**
- **C1.2 EXISTING CONDITIONS NORTH**
- **C2.1 SITE PLAN SOUTH**
- C2.2 SITE PLAN NORTH
- **C2.3 NORTH FRONTAGE IMPROVEMENTS**
- C3.1 GRADING & DRAINAGE PLAN SOUTH
- C3.2 GRADING & DRAINAGE PLAN NORTH
- C4.1 UTILITY PLAN SOUTH
- C4.2 UTILITY PLAN NORTH
- C5.1 PLAT MAP SOUTH C5.2 PLAT MAP - NORTH
- C6.1 TREE & UTILITY PLAN SOUTH
- C6.2 TREE & UTILITY PLAN NORTH

CONTACT INFORMATION

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SURVEYOR

LAND DEVELOPMENT ENGINEERING & RAYMOND PETERSON, PLS 5160 INDUSTRIAL PLACE SUITE 108 FERNDALE, WA 98248 (360) 383-0620 ray@ldesinc.com

ARCHITECT BOARD & VELLUM MEG CUMMINS 115 15TH AVENUE EAST

SUITE 100

SEATTLE, WA 98112

(206) 384-4383


STREAM REAL ESTATE DEVELOPMENT & INVESTMENT 999 N NORTHLAKE WAY SUITE 200 SEATTLE, WA 98103 (206) 979-3597 meg@boardandvellum.com marc@streamre.com


OWNER

LANDSCAPE ARCHITECT KIM ROONEY LANDSCAPE ARCHITECTURE KIM ROONEY


2307 VIEWMONT WY W SEATTLE, WA 98199 (206) 920-1323 kim@kimrooneyinc.com


LEGEND

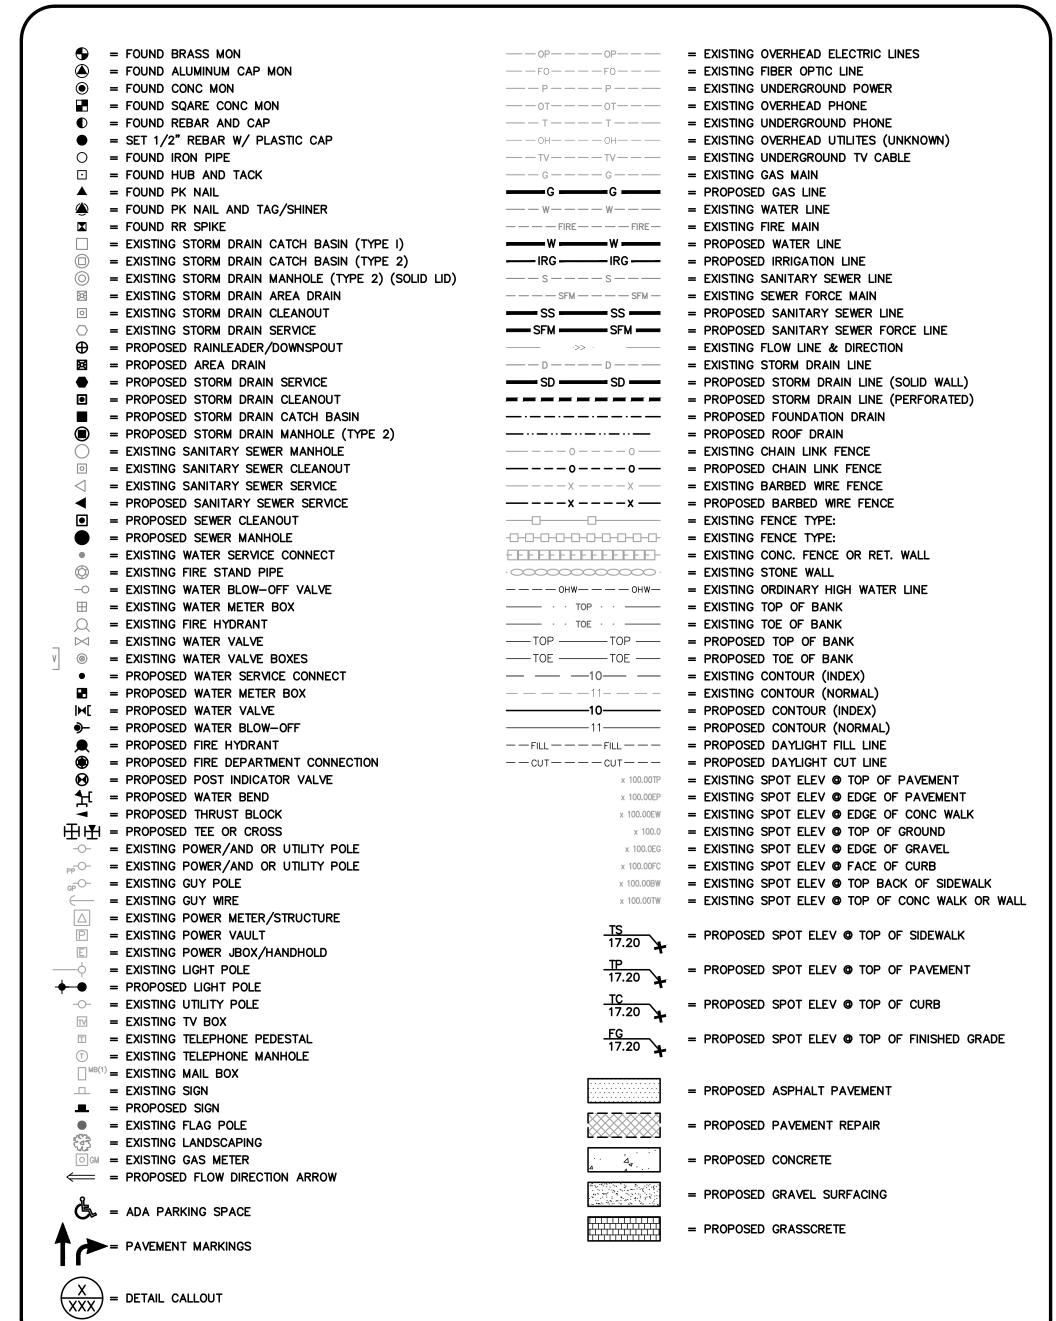


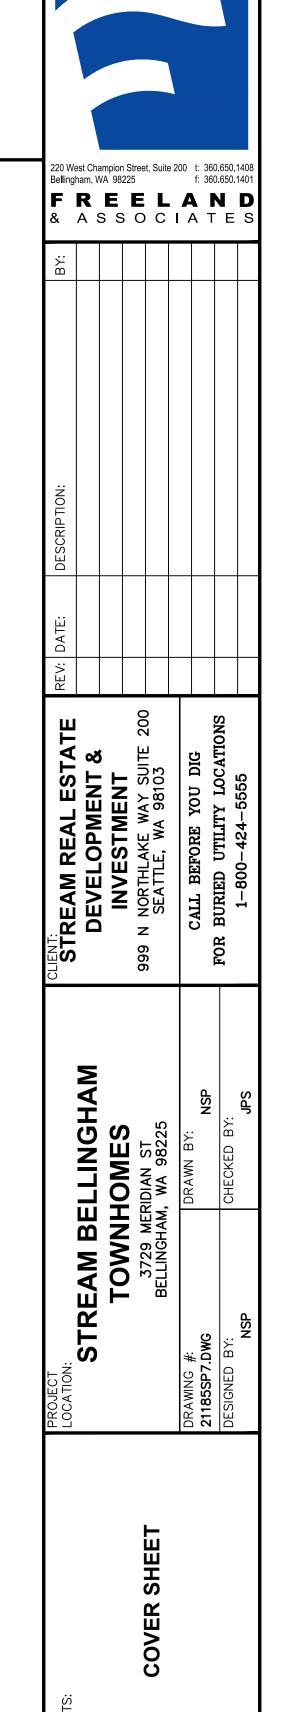

4-15-2023 21185 C1

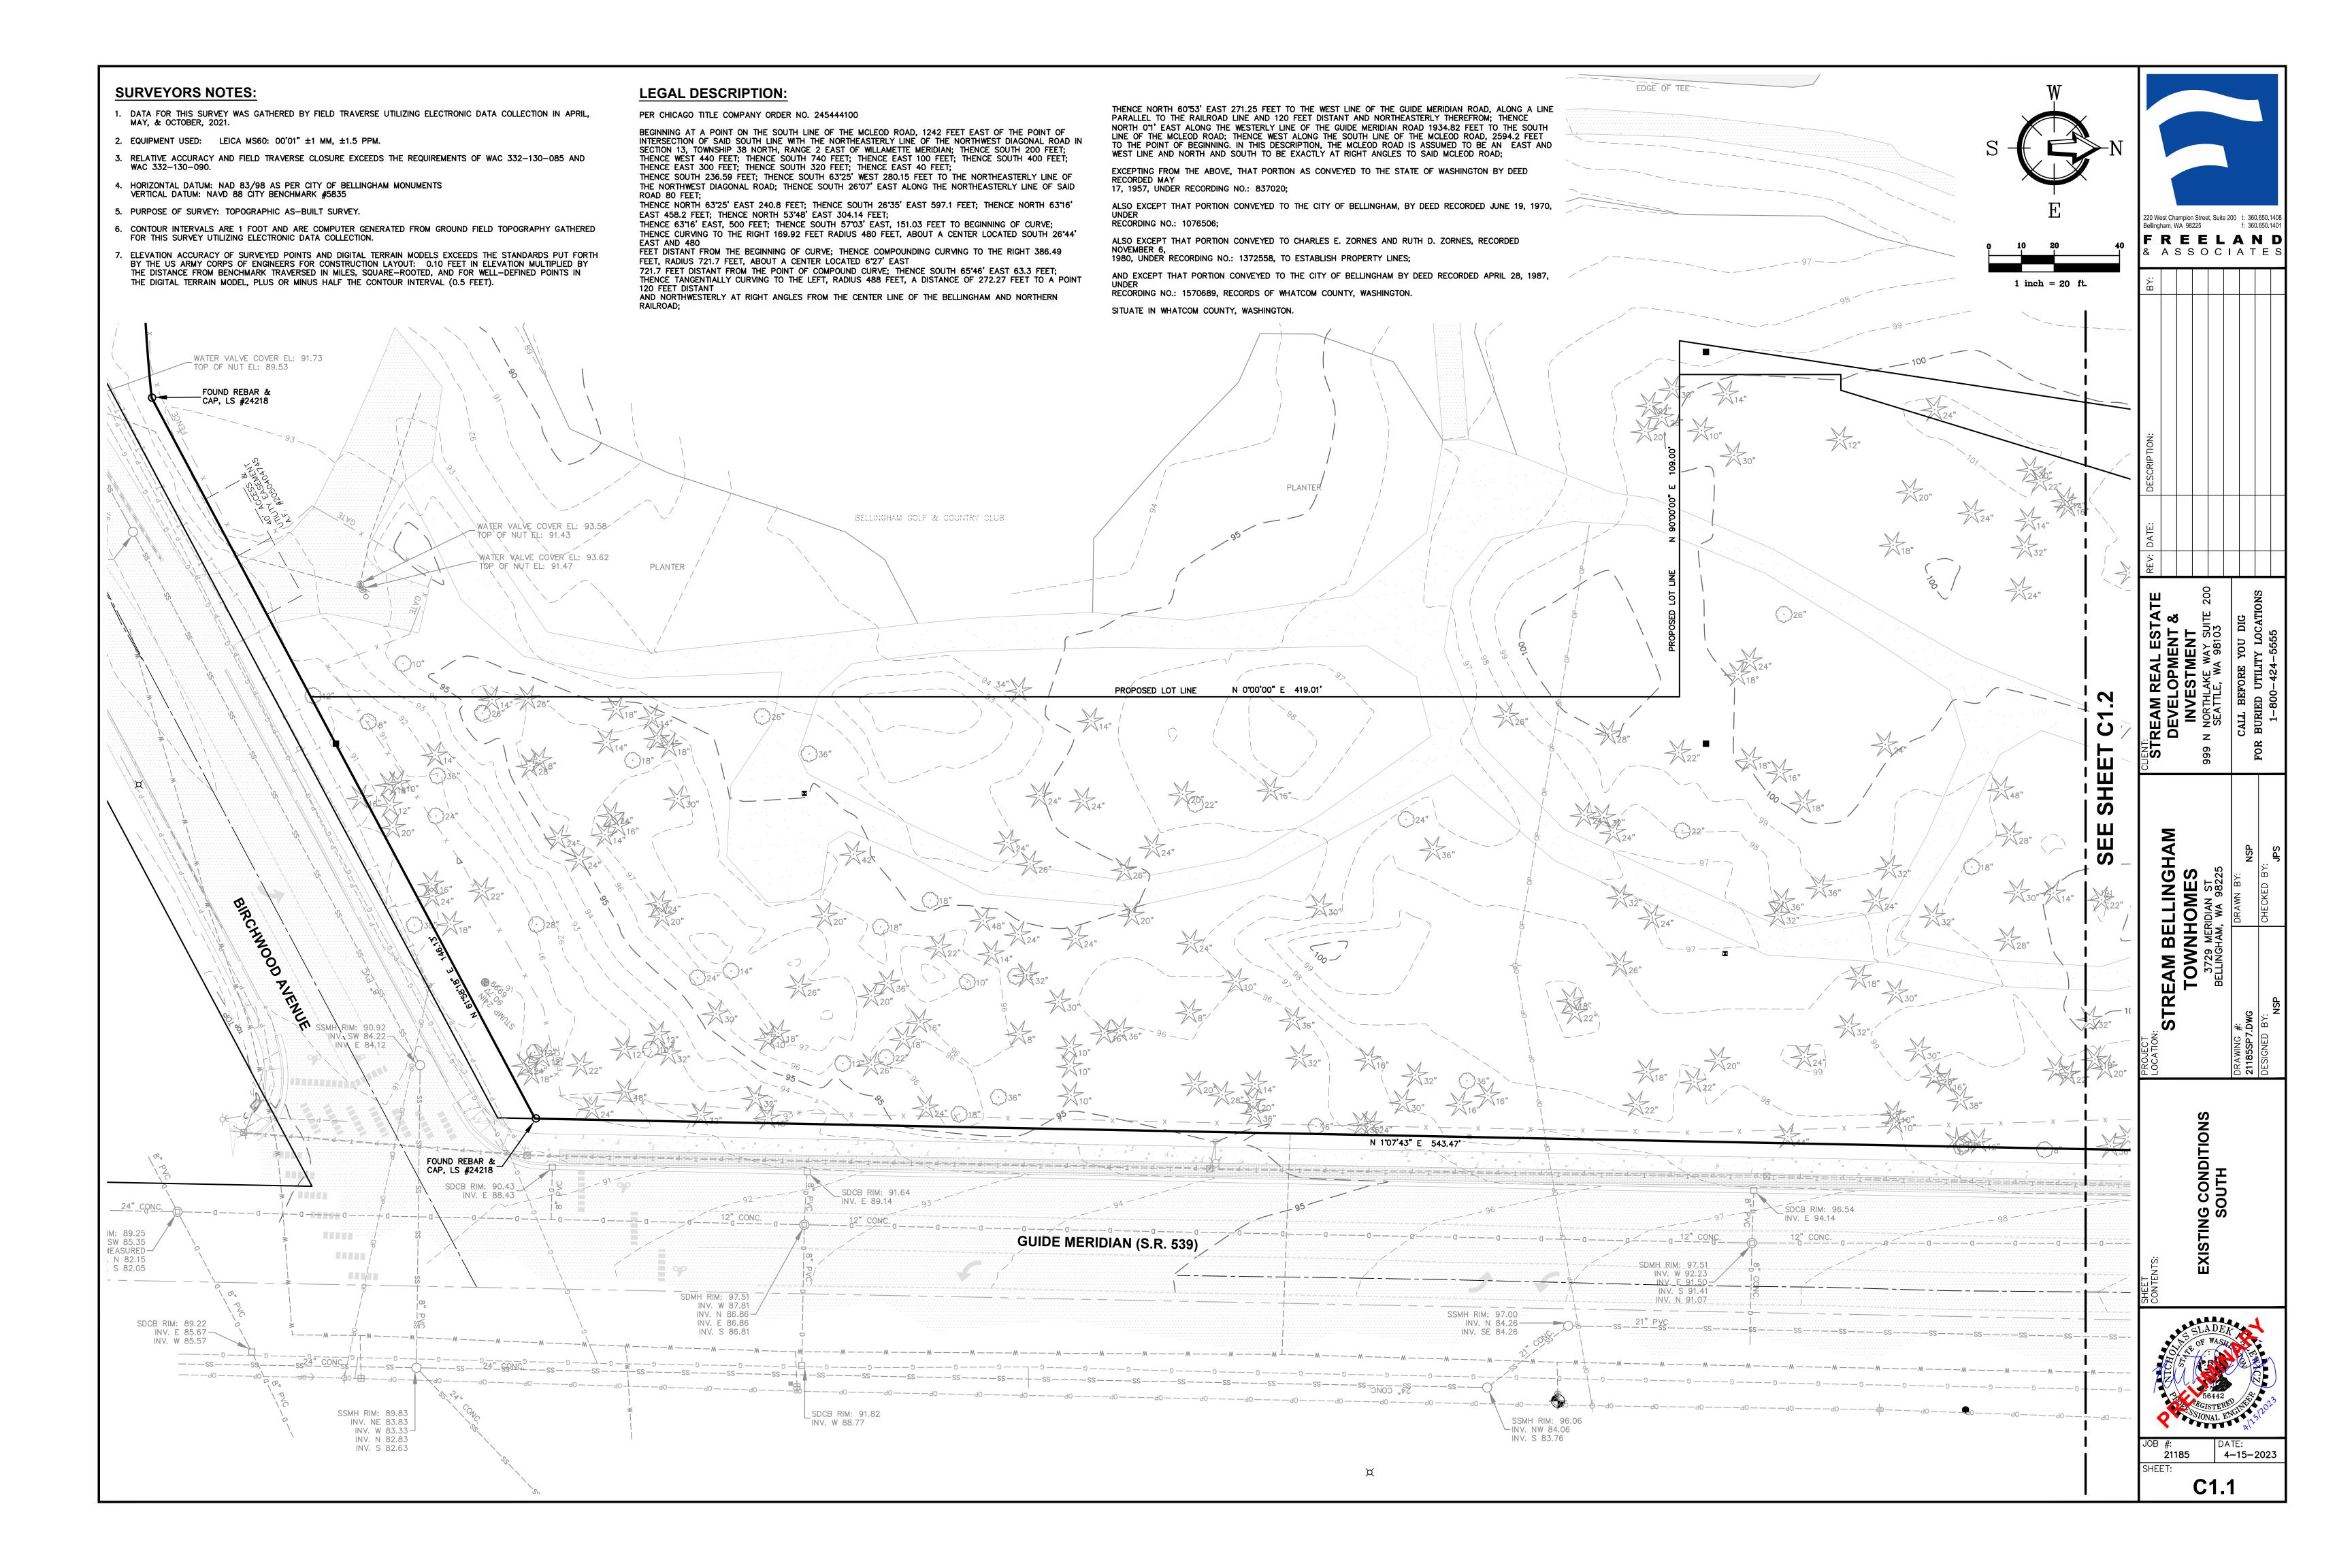


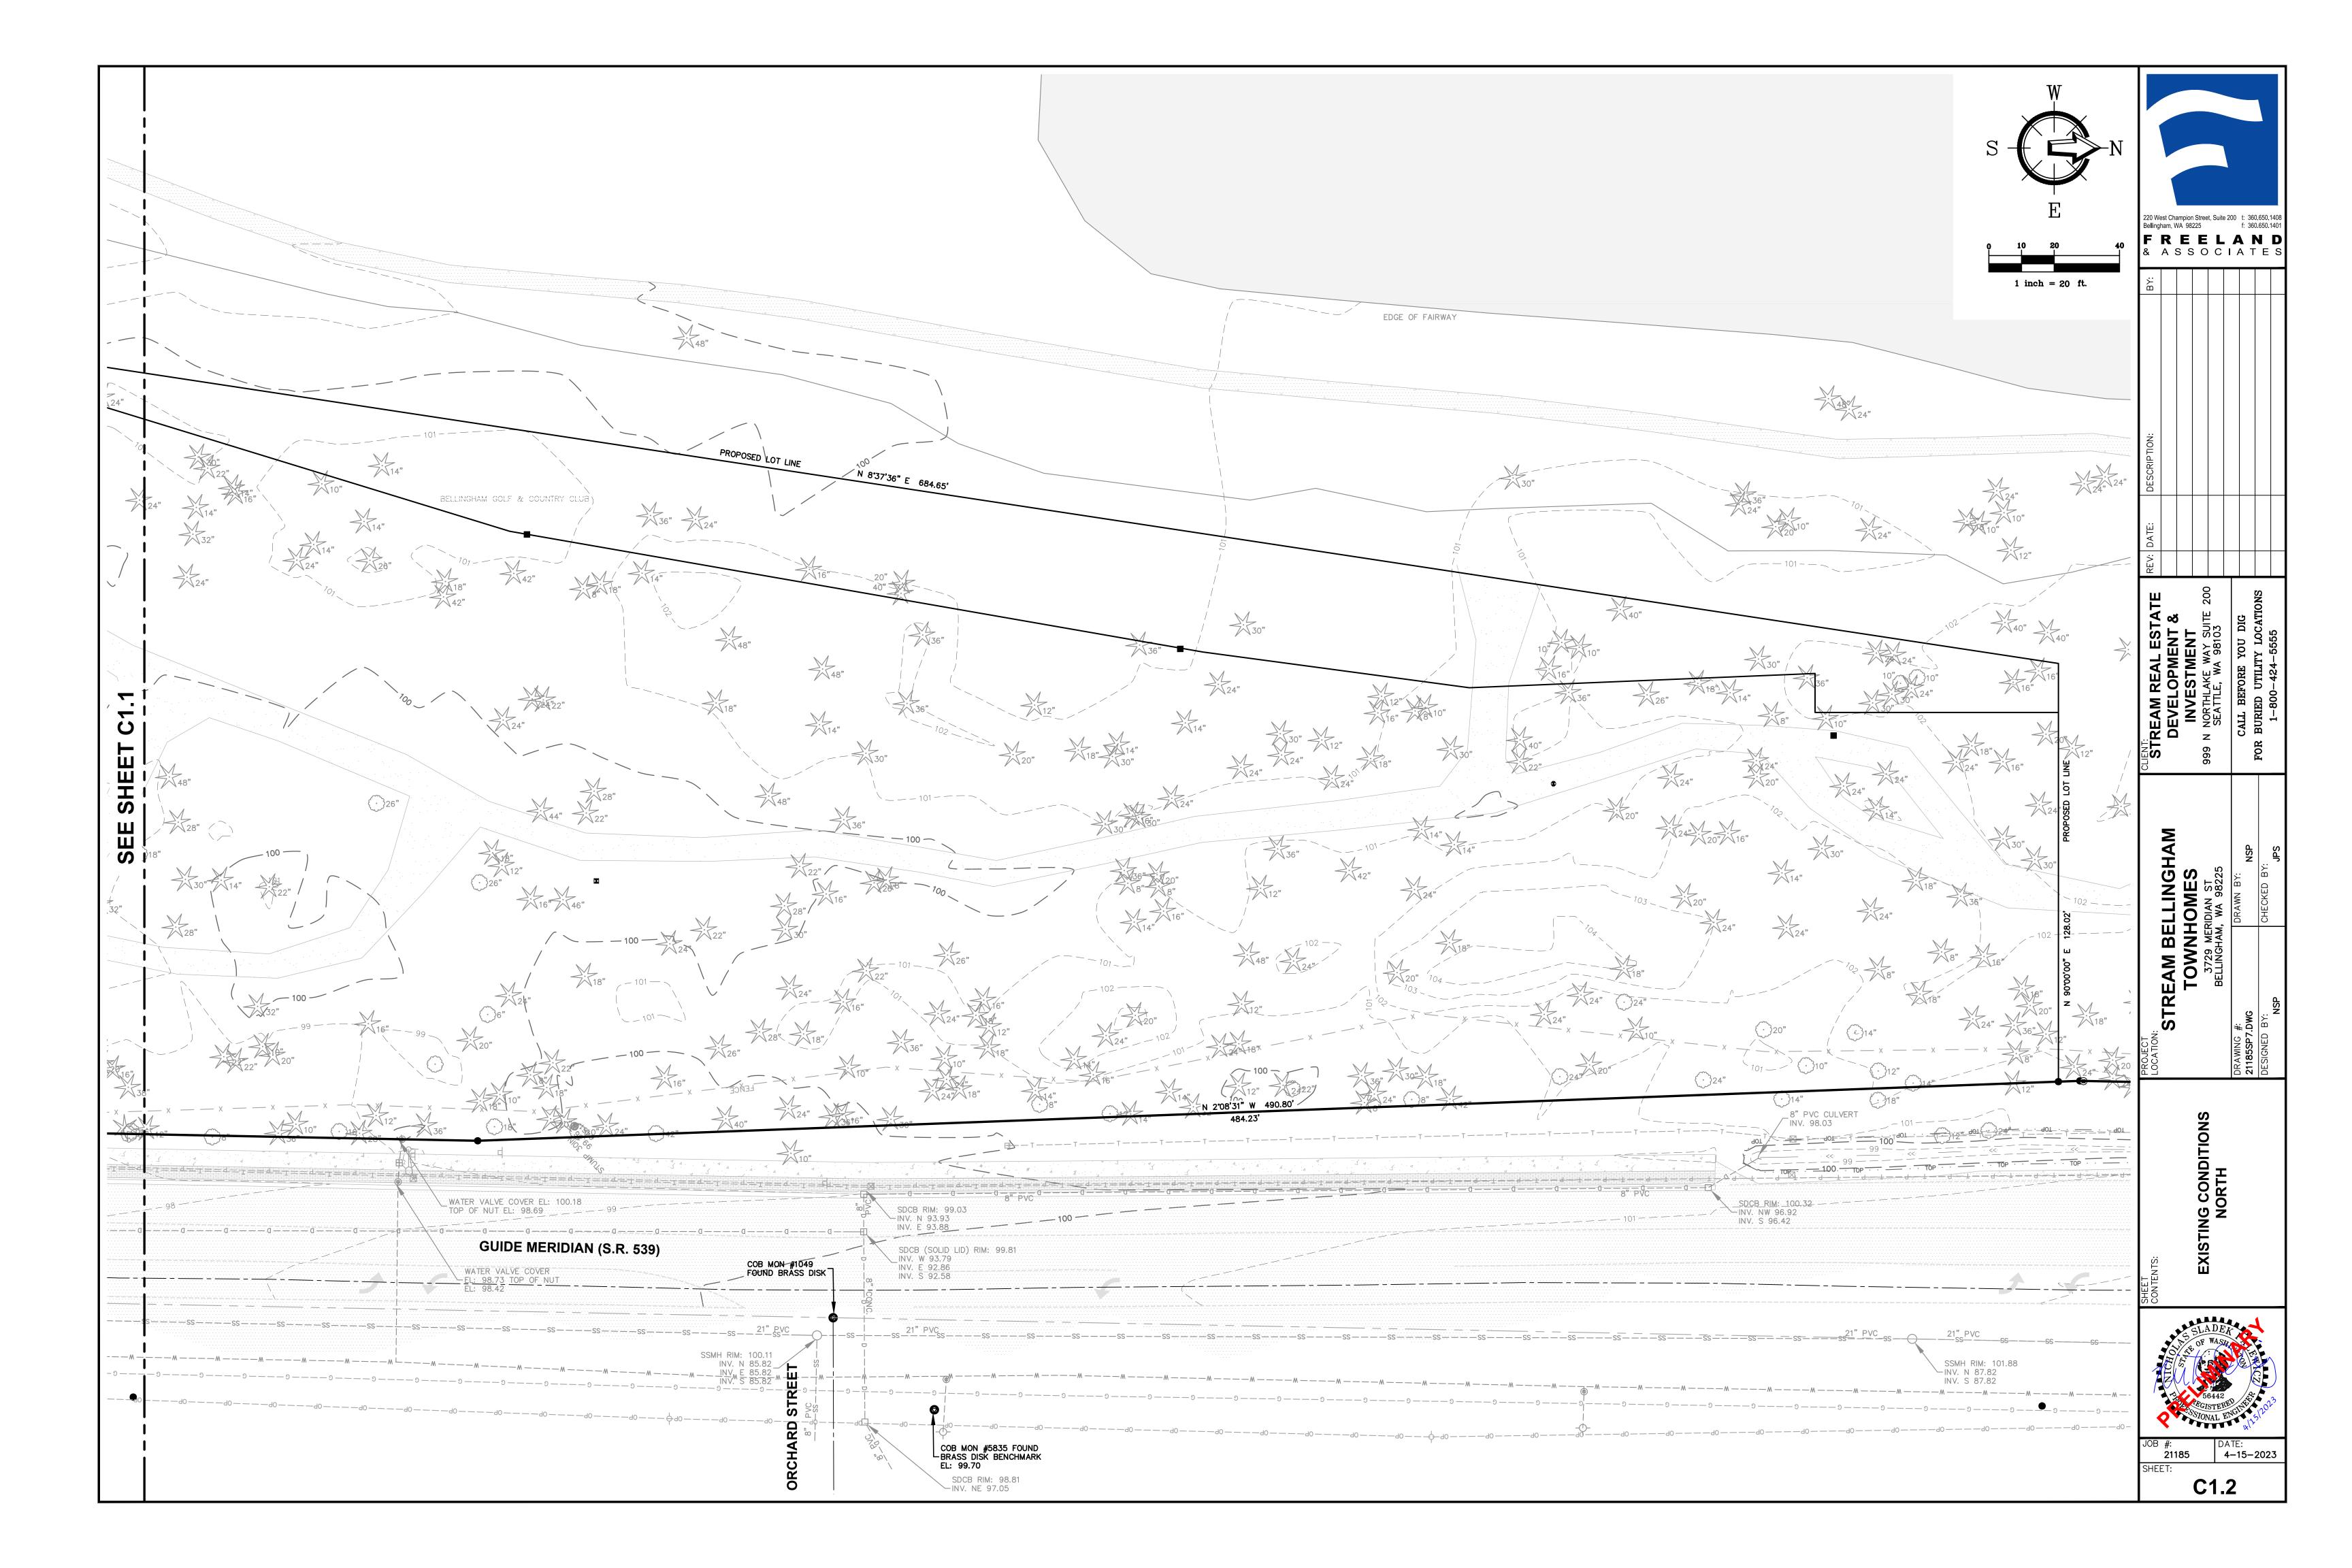


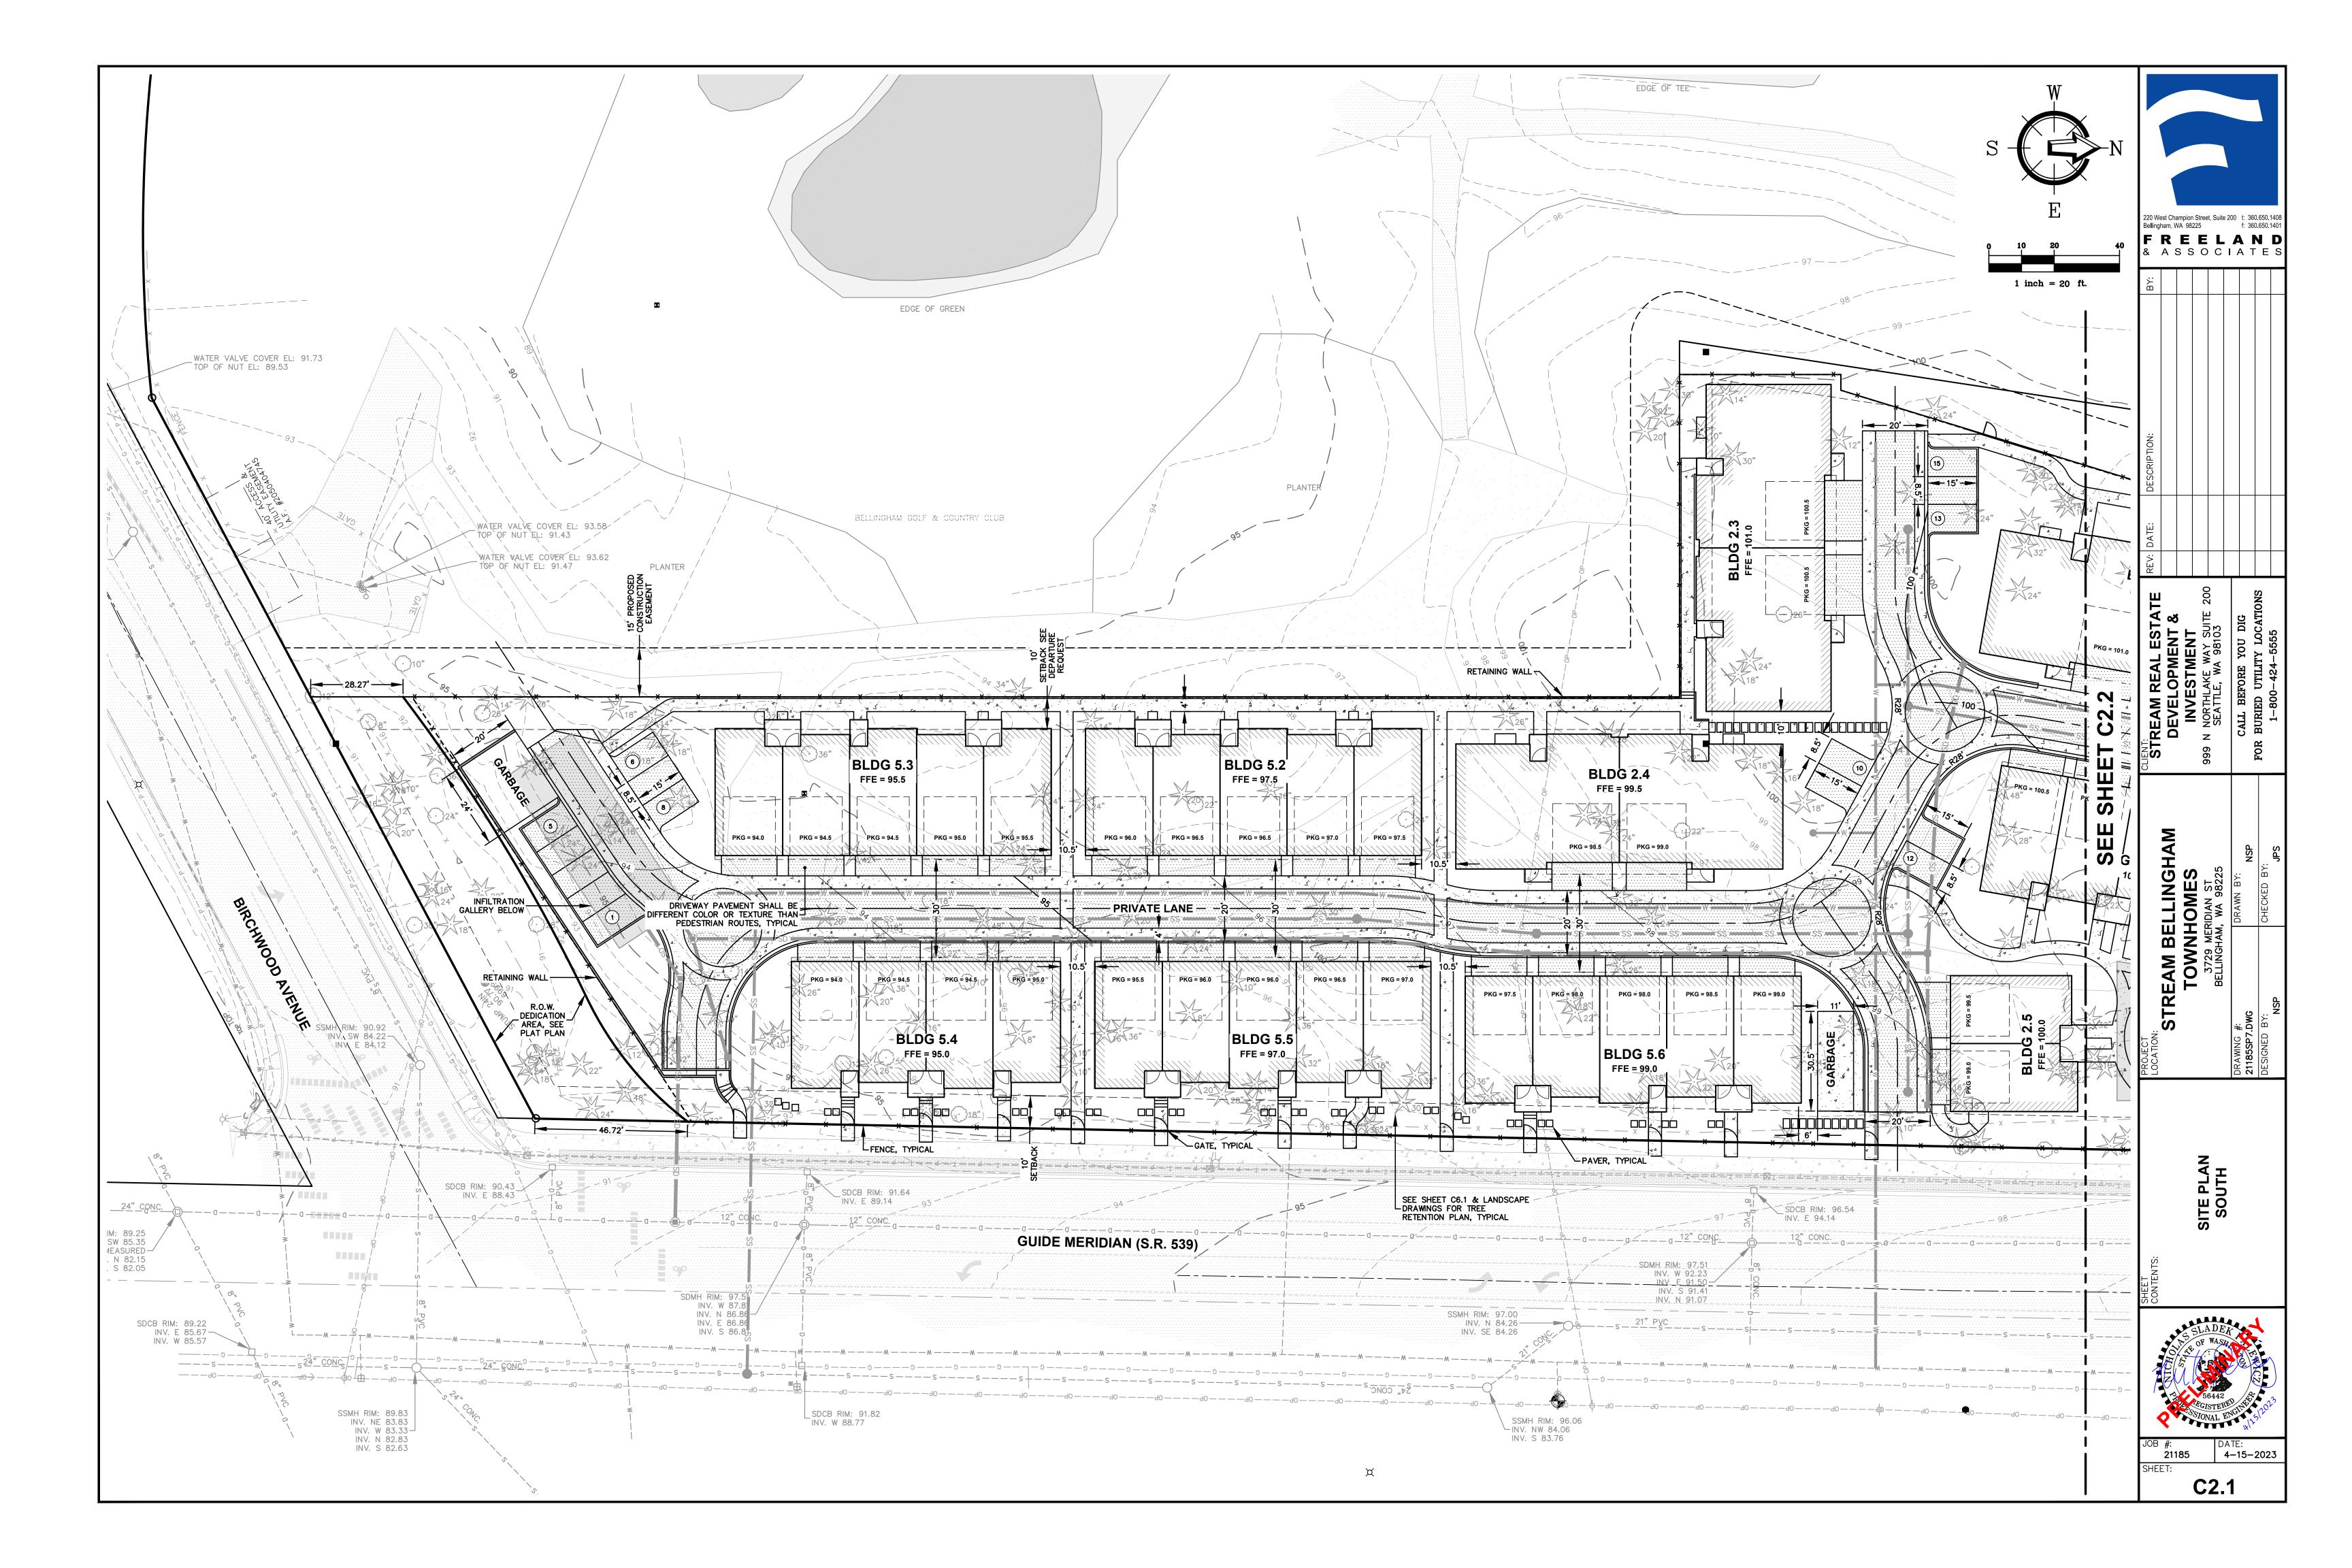








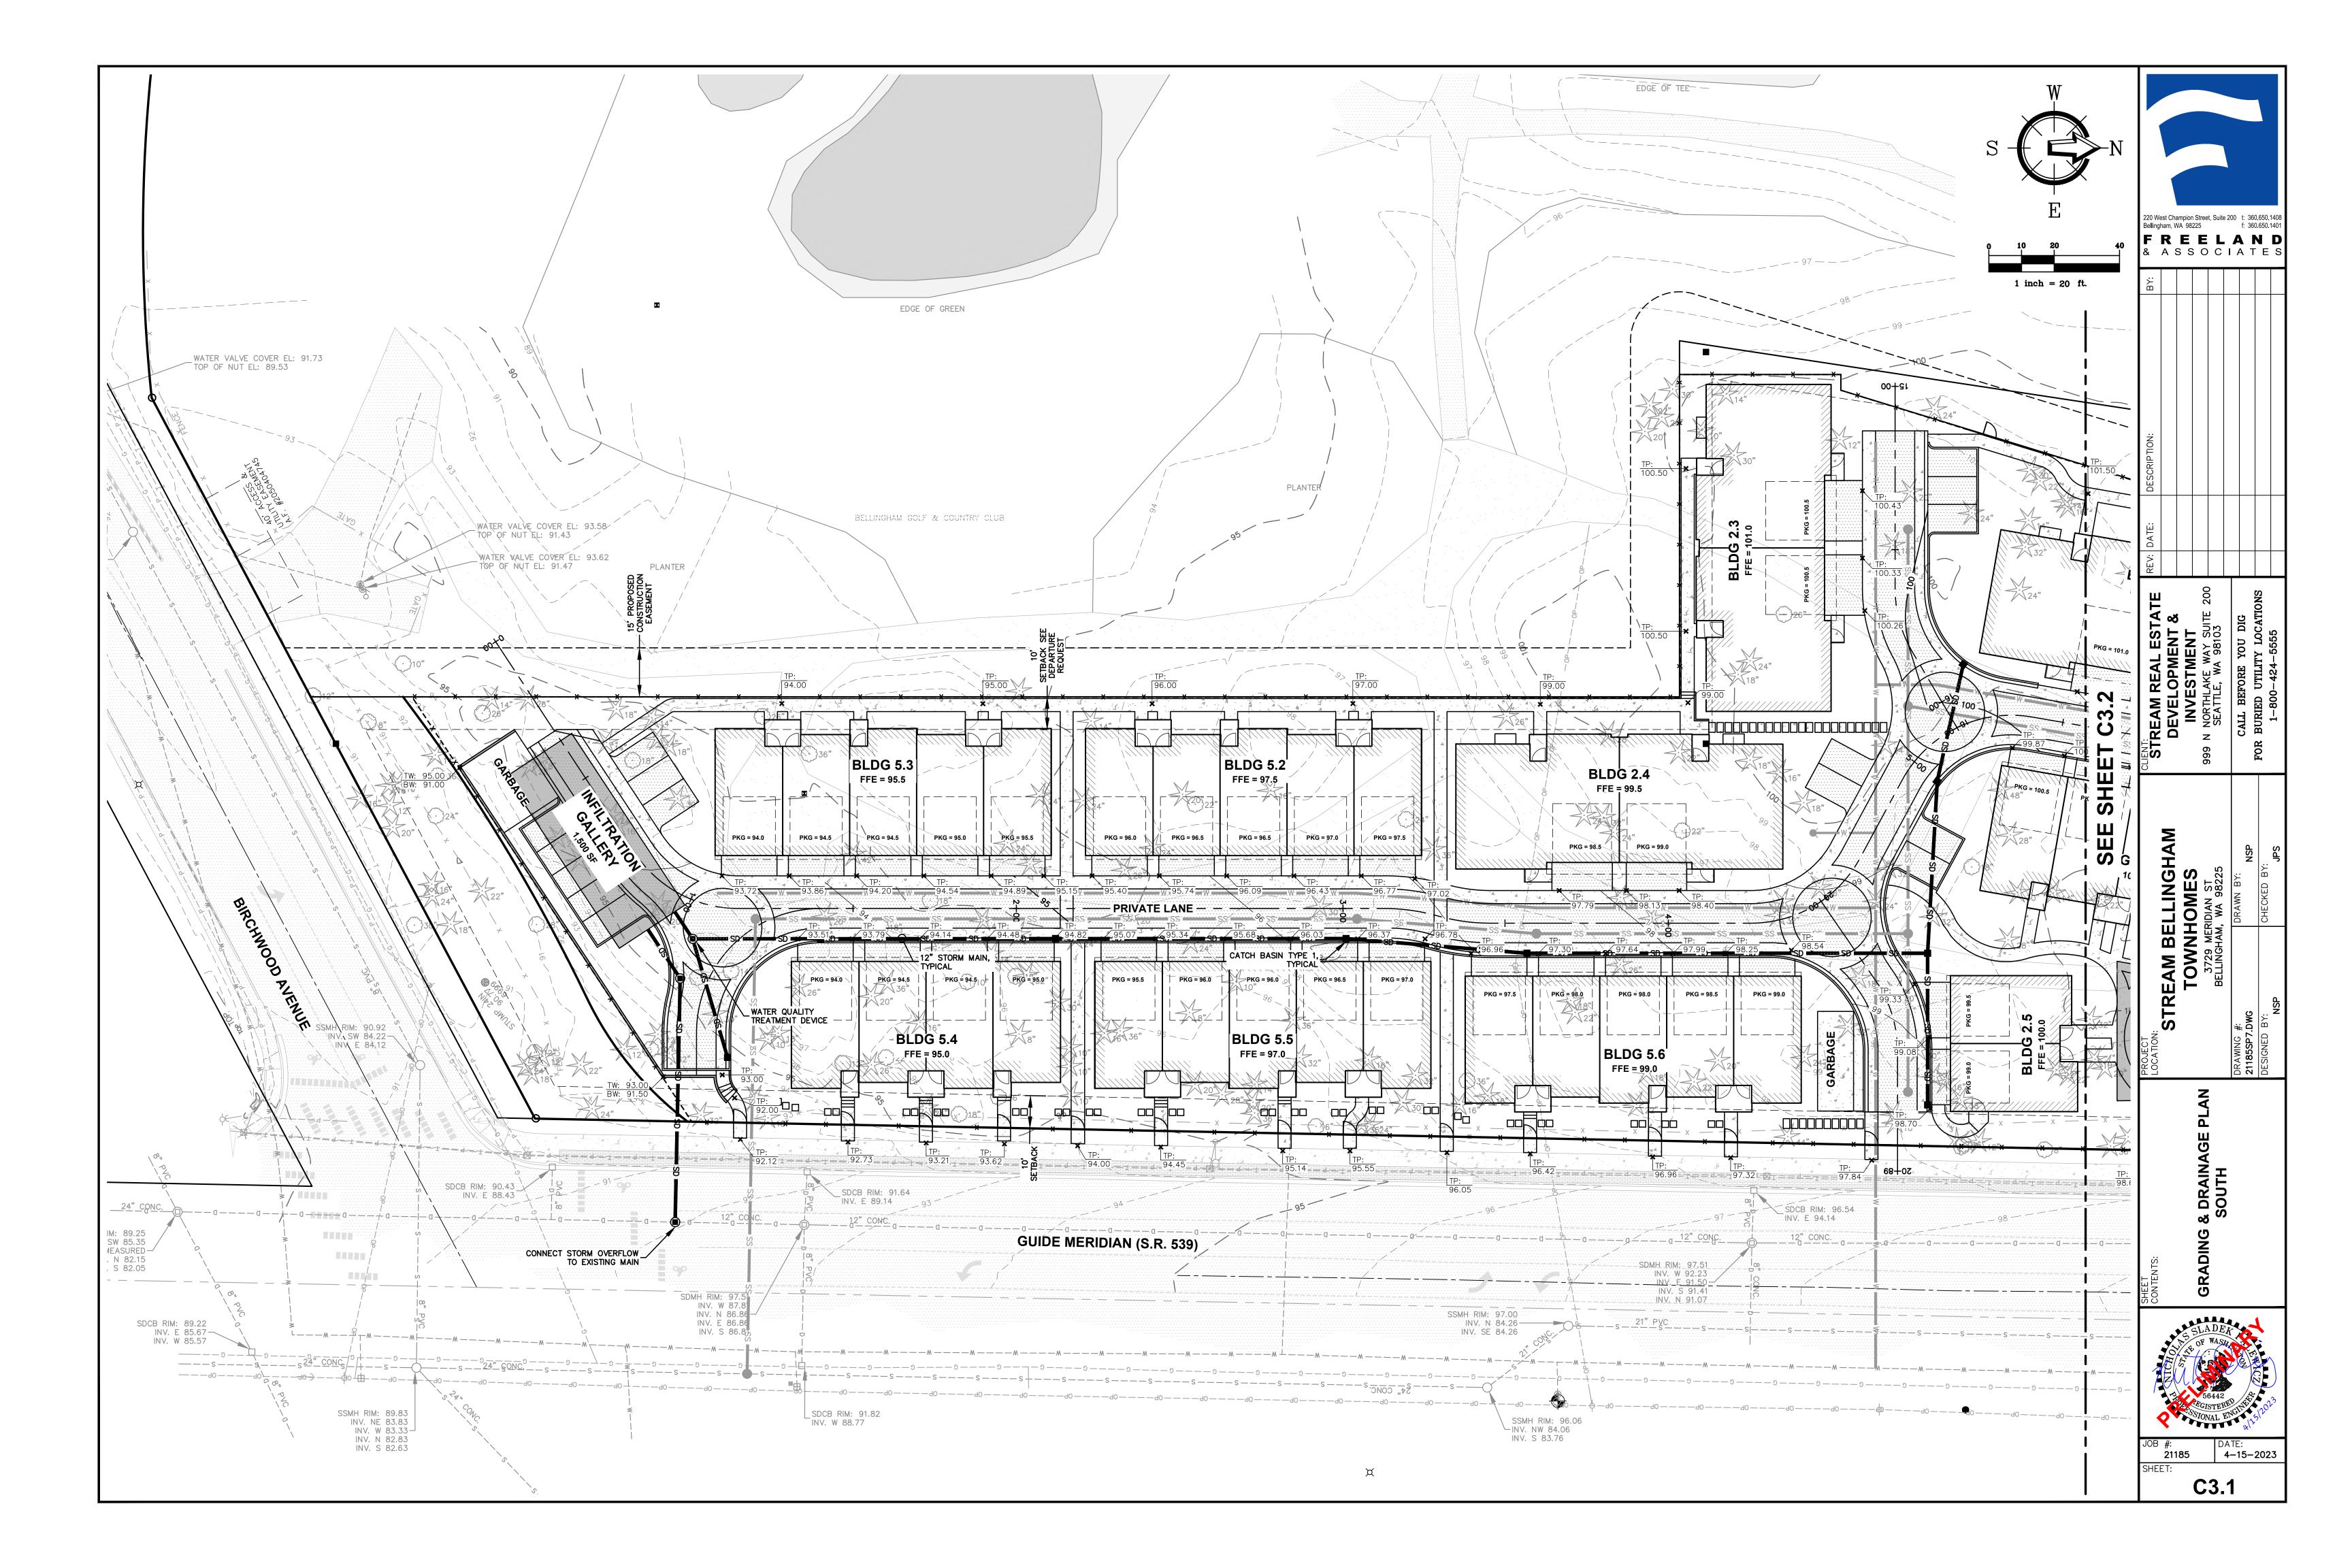


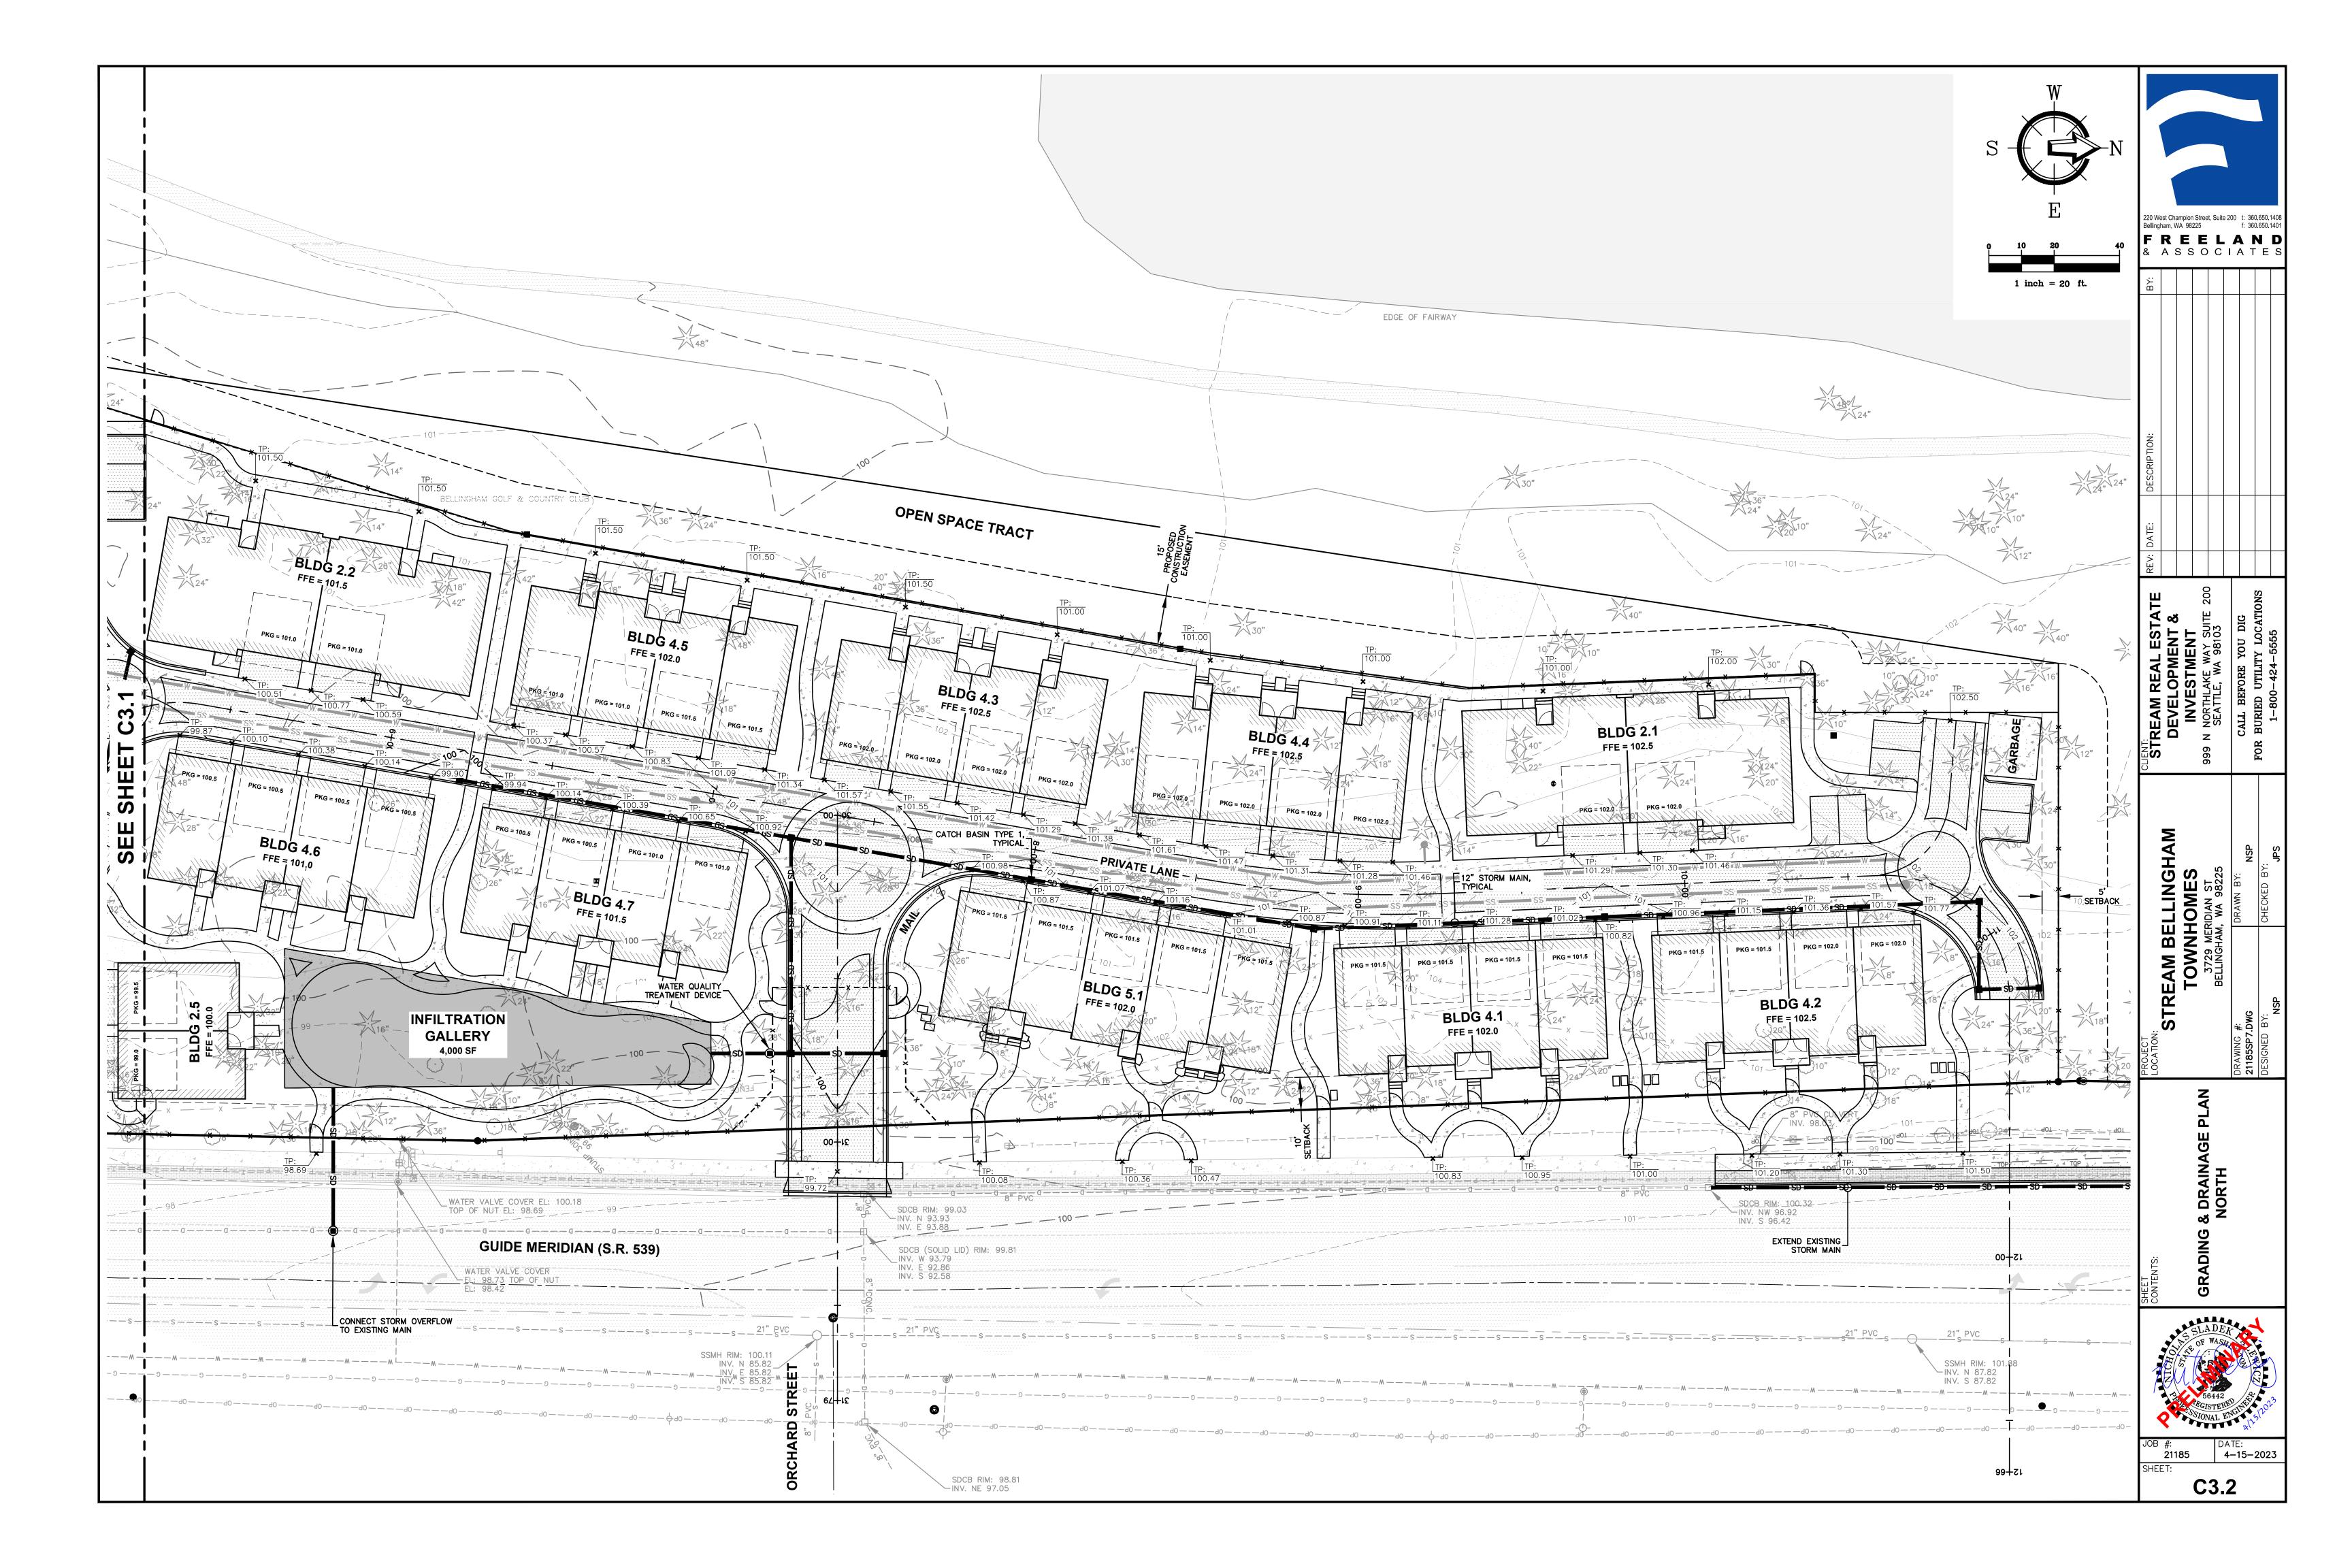


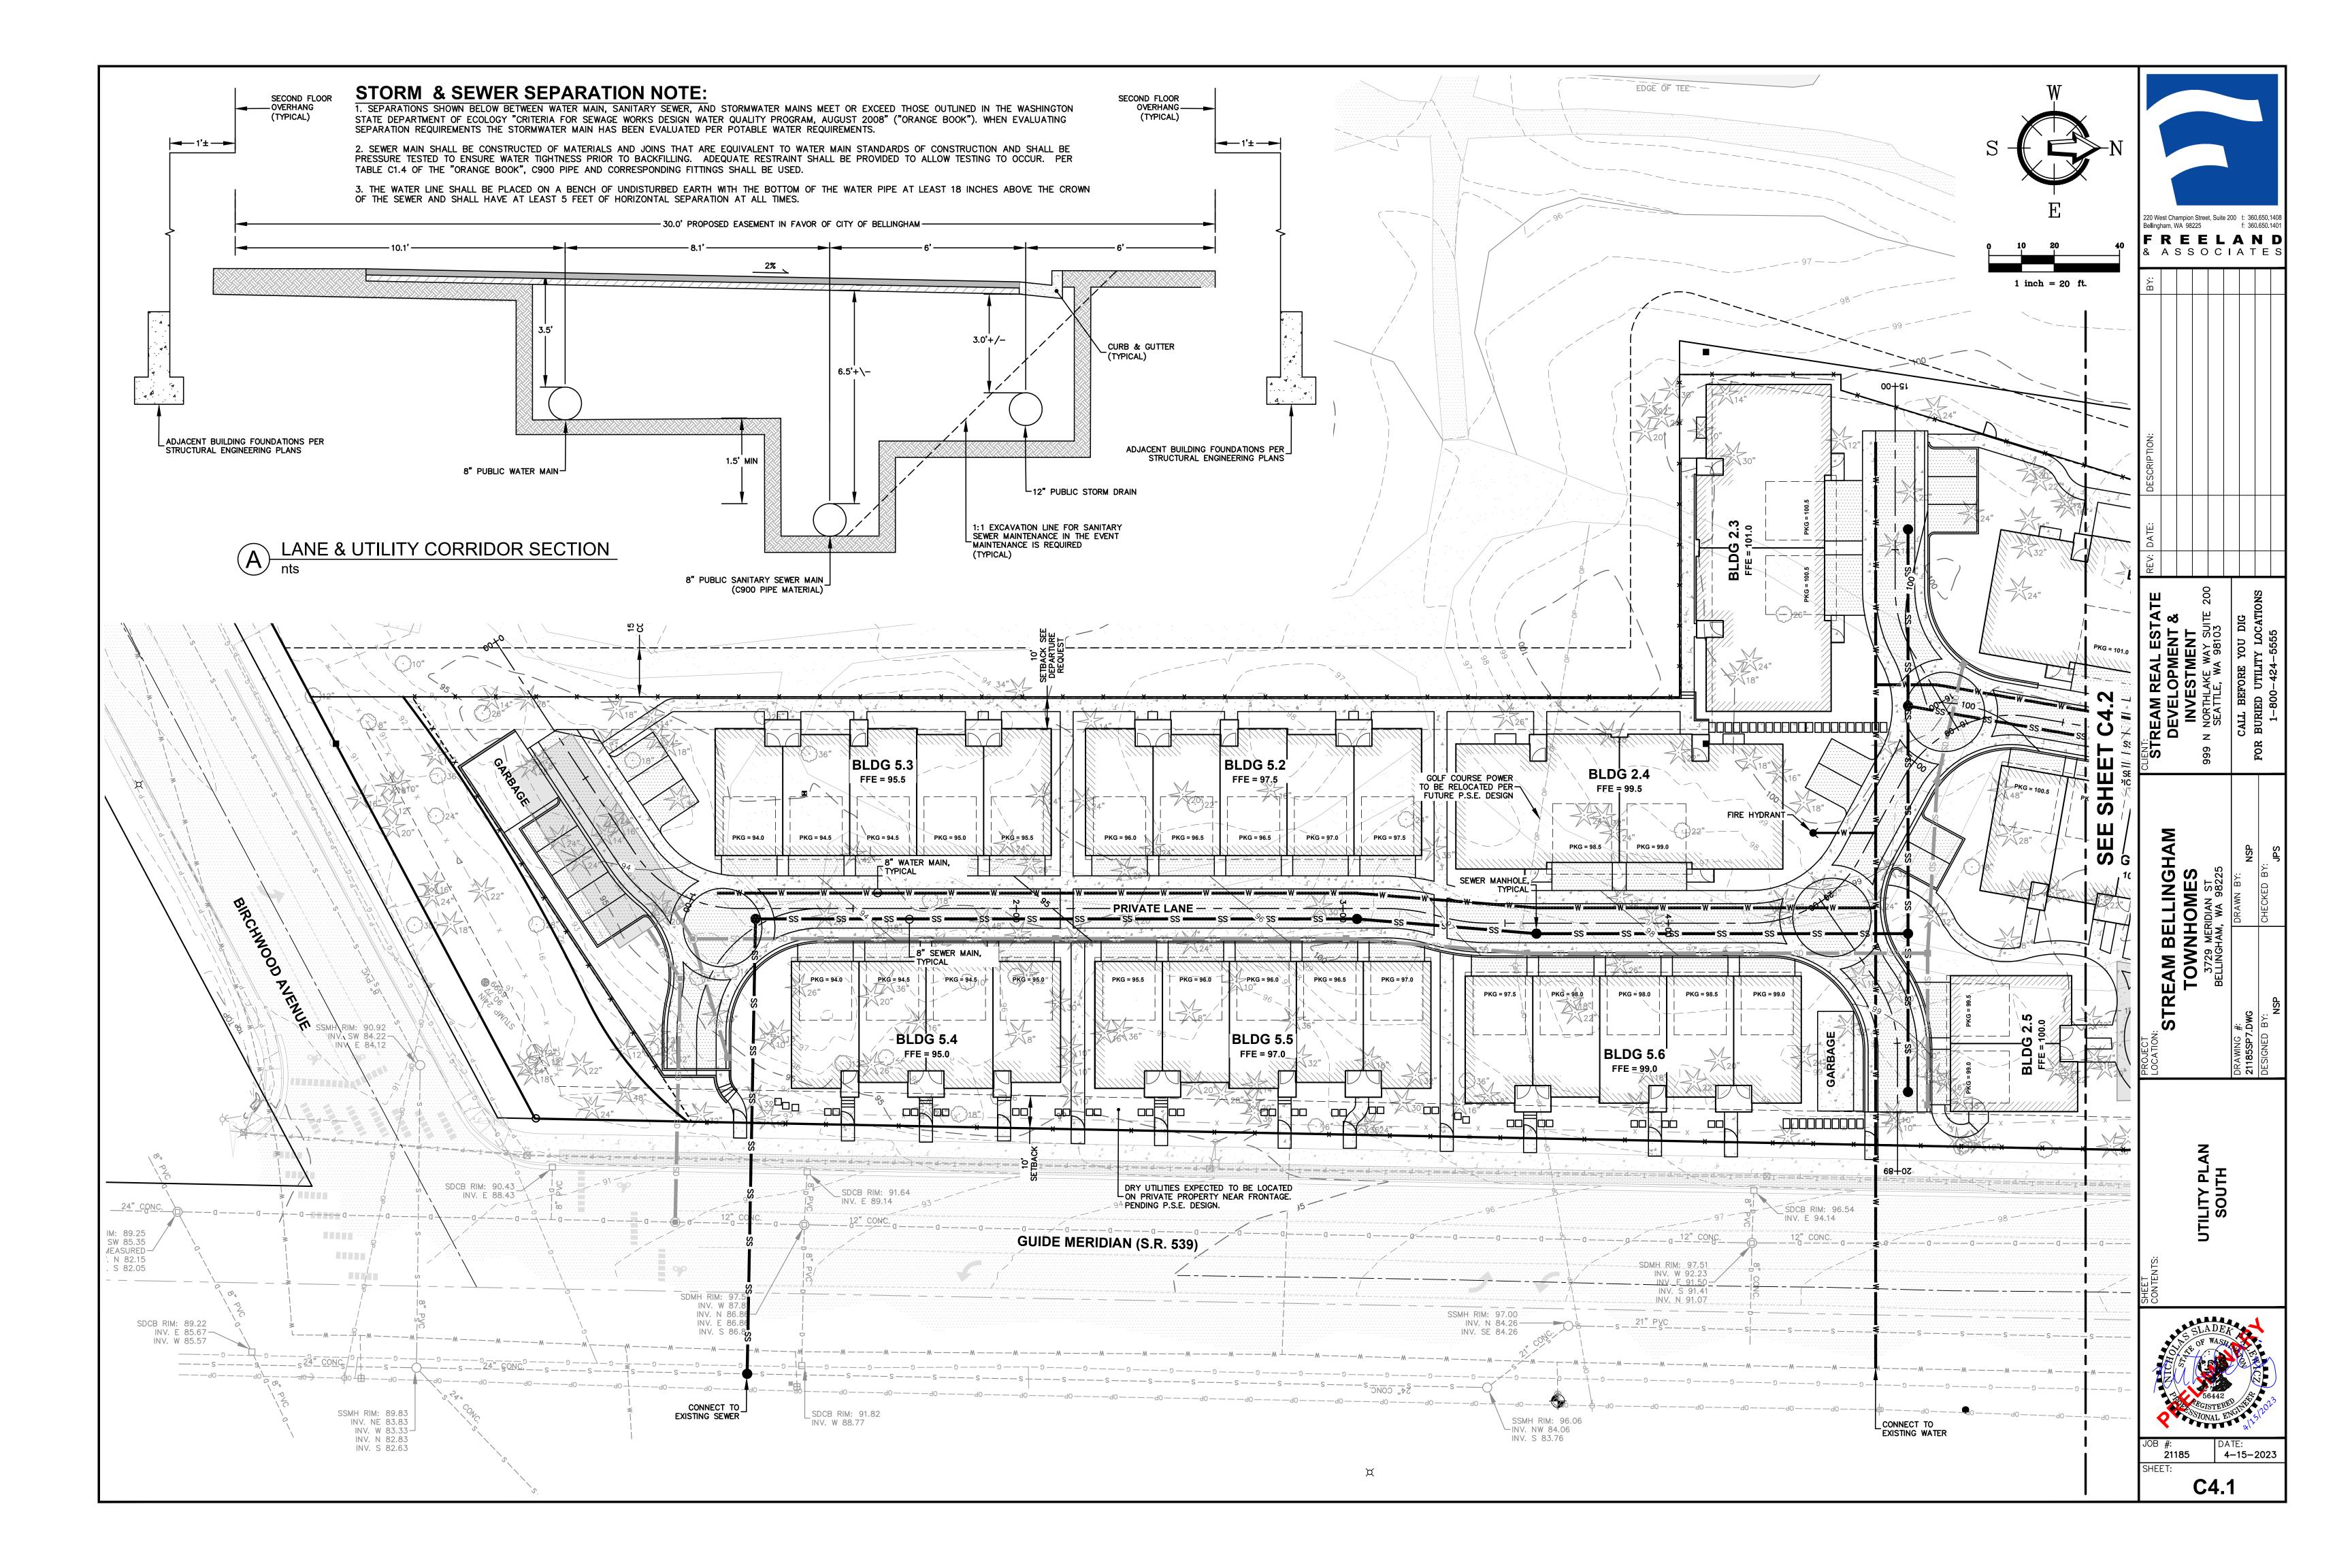


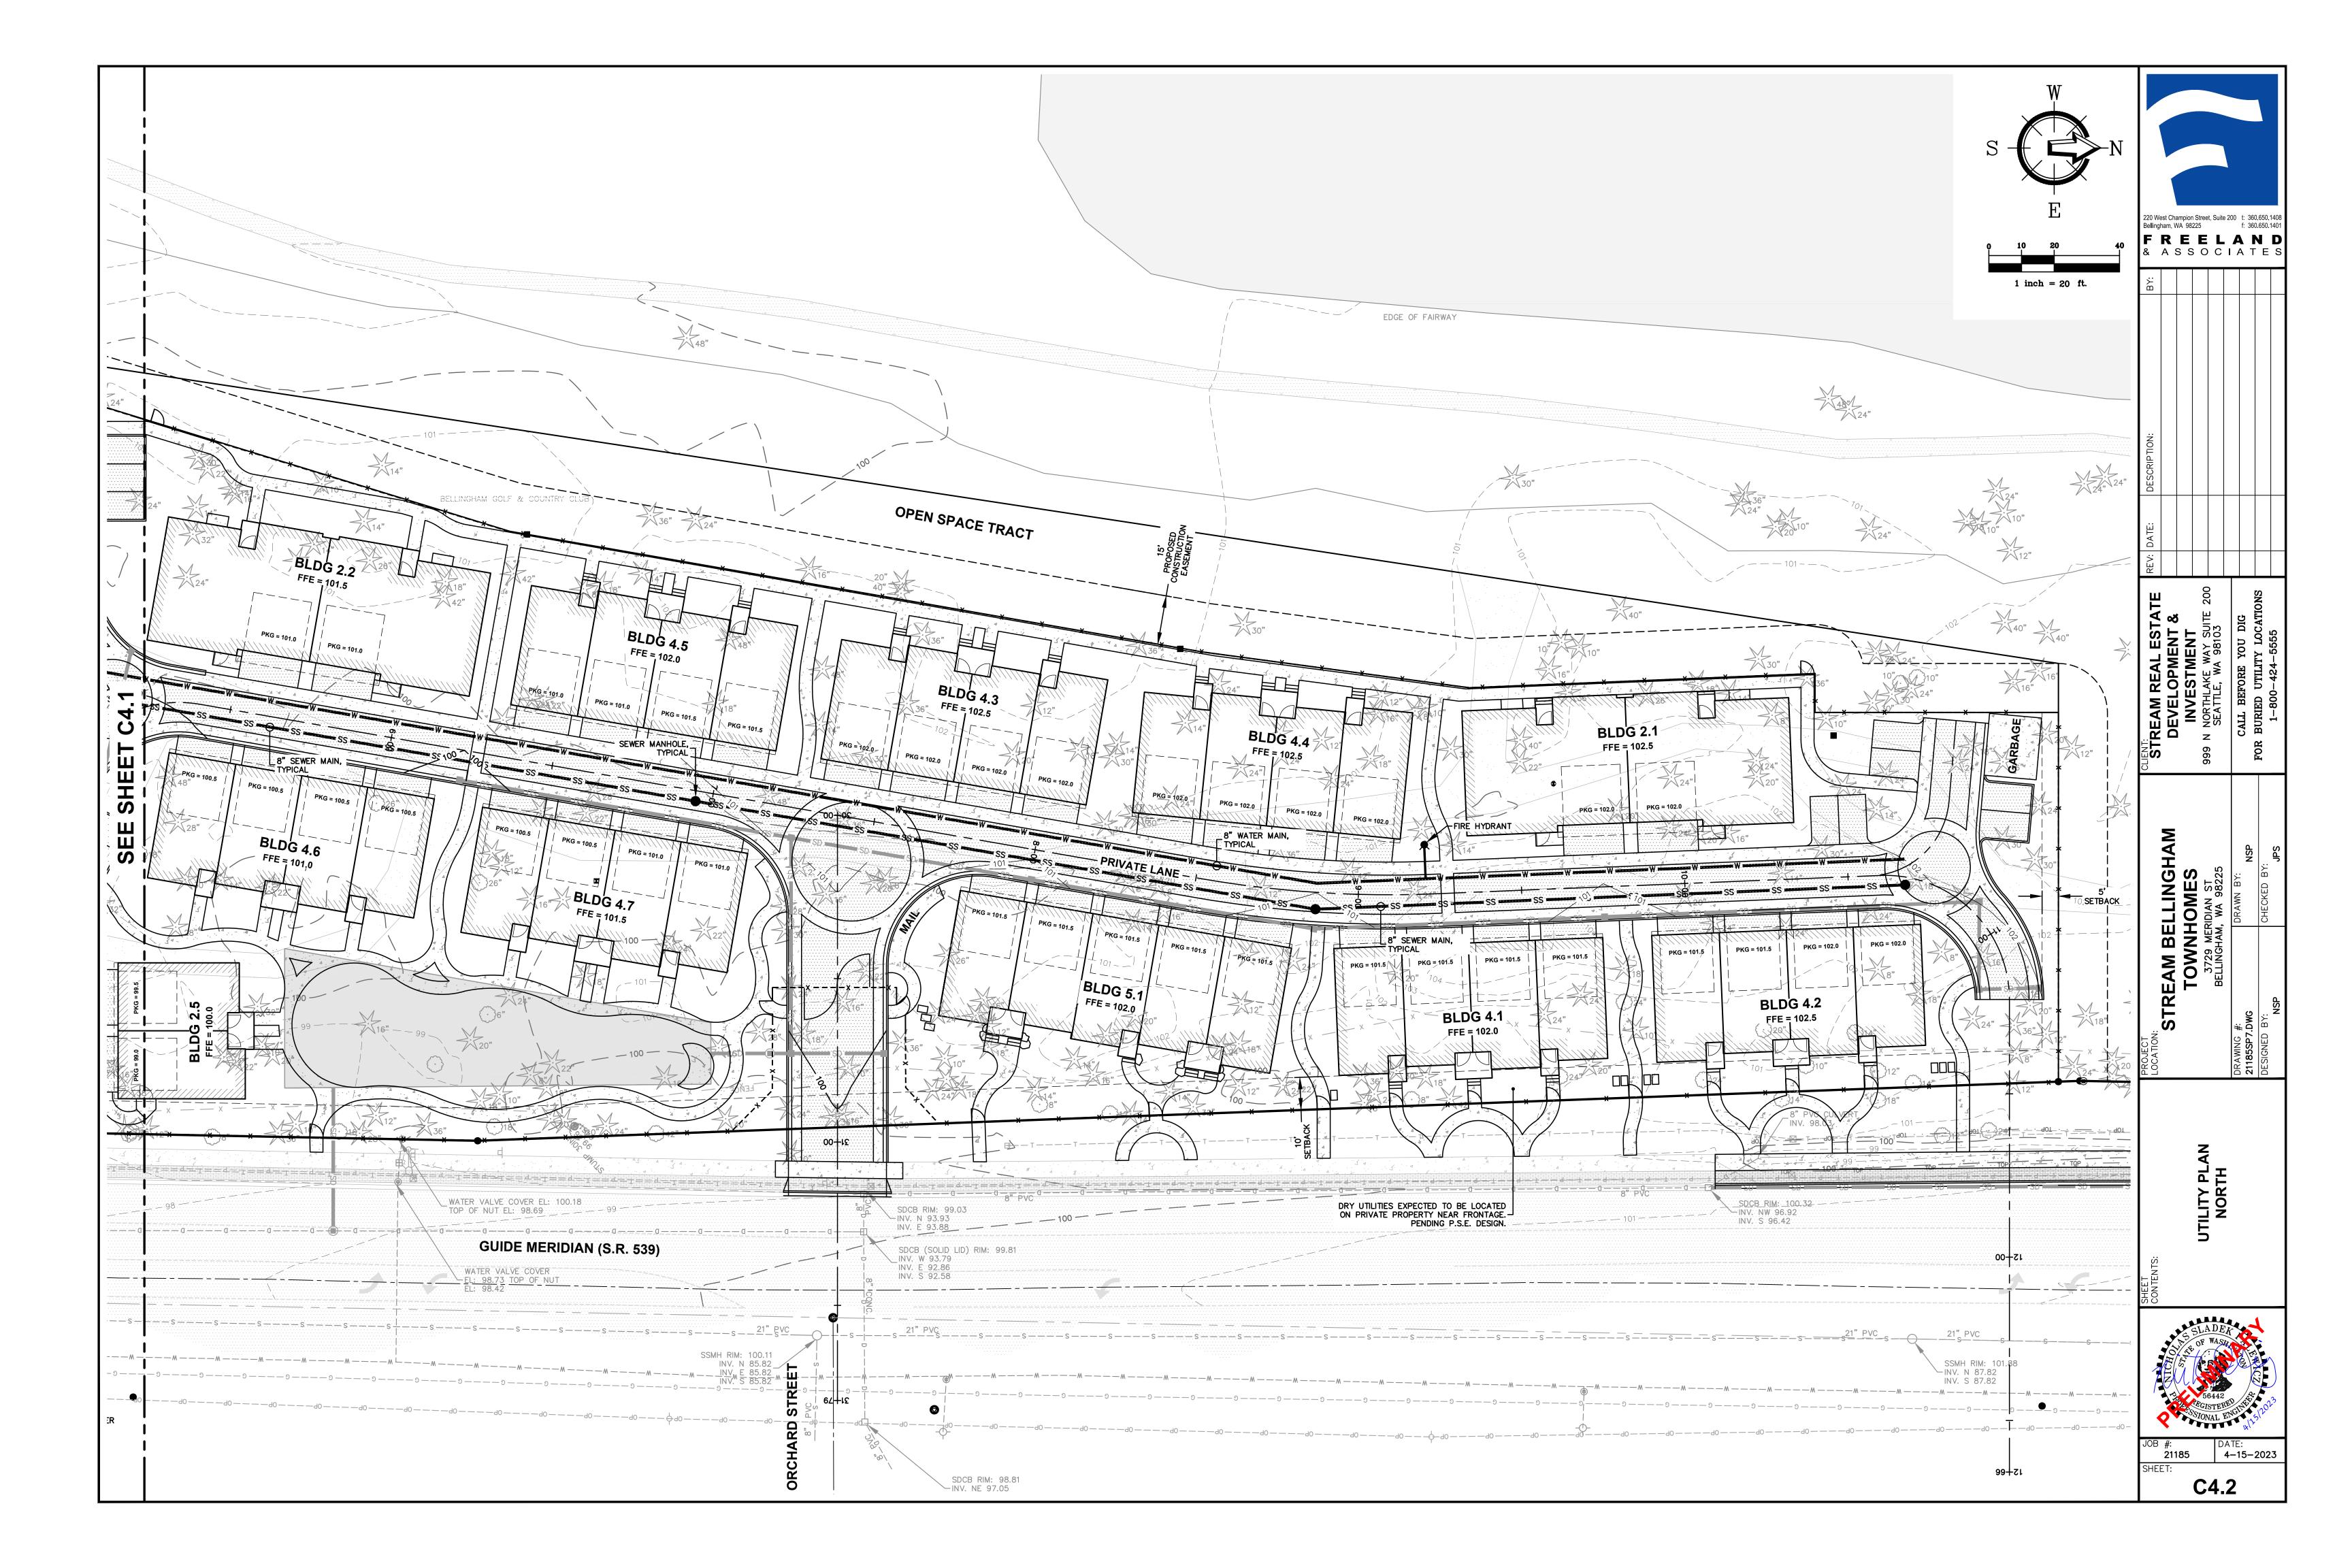

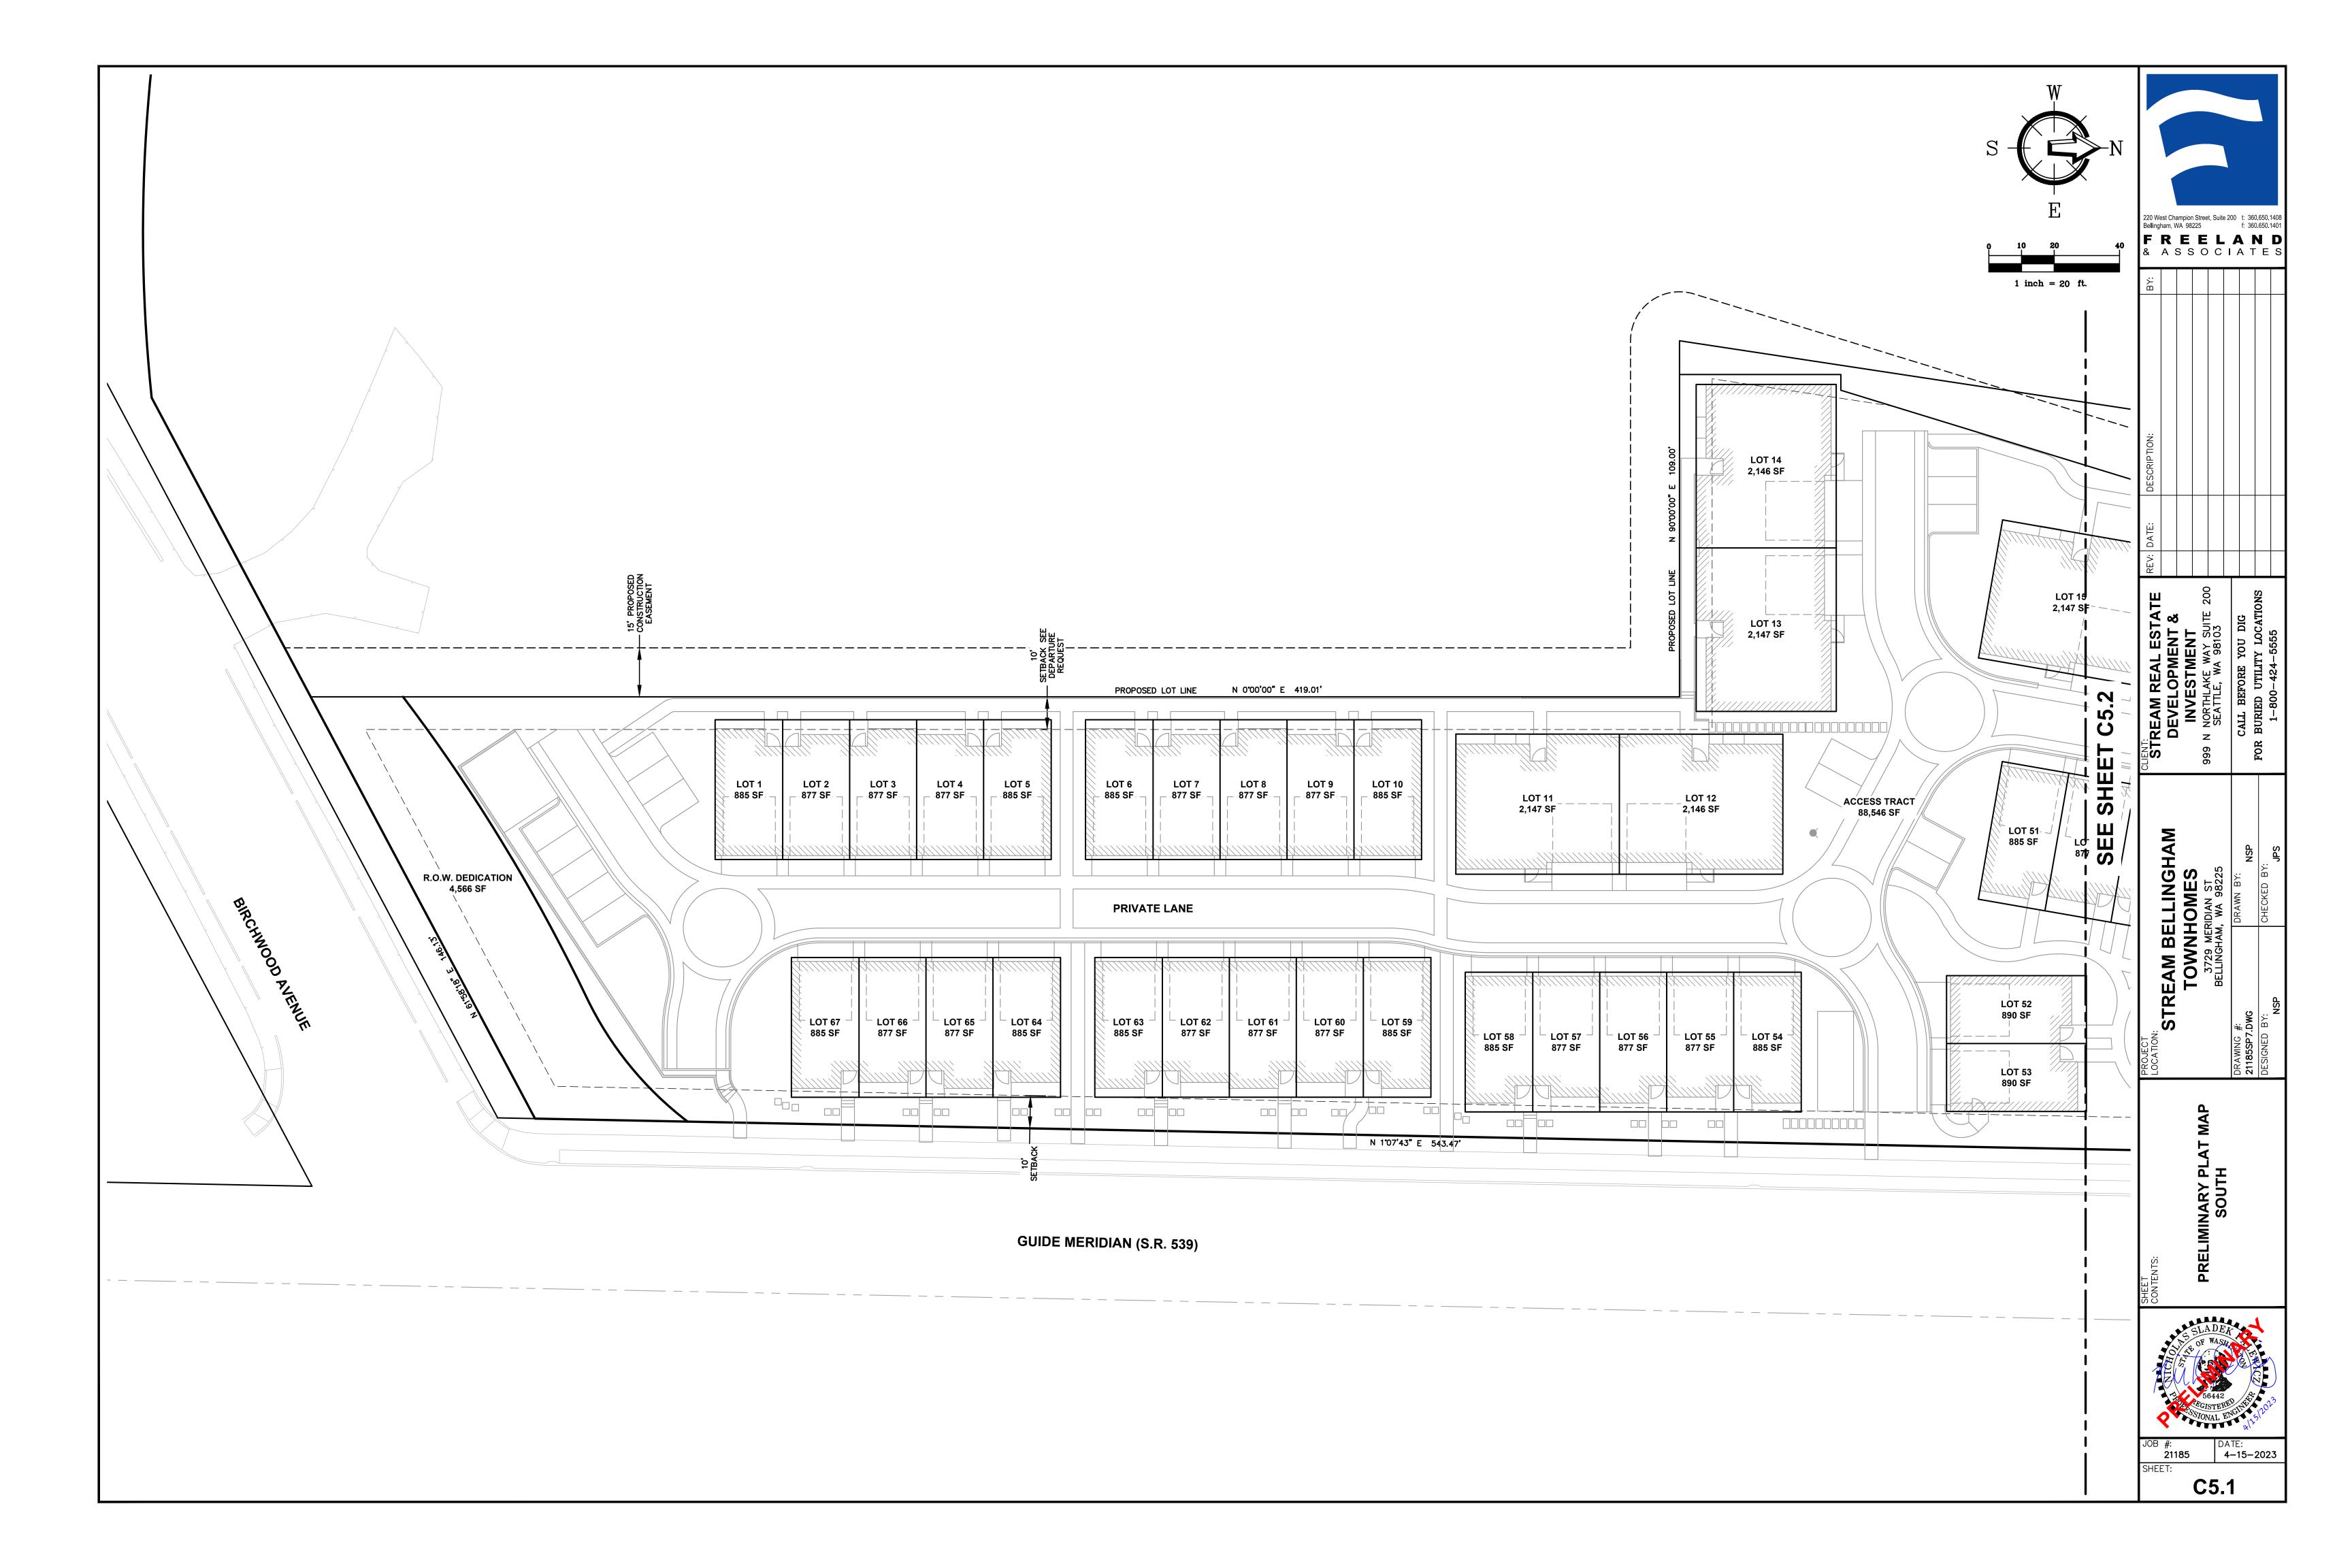

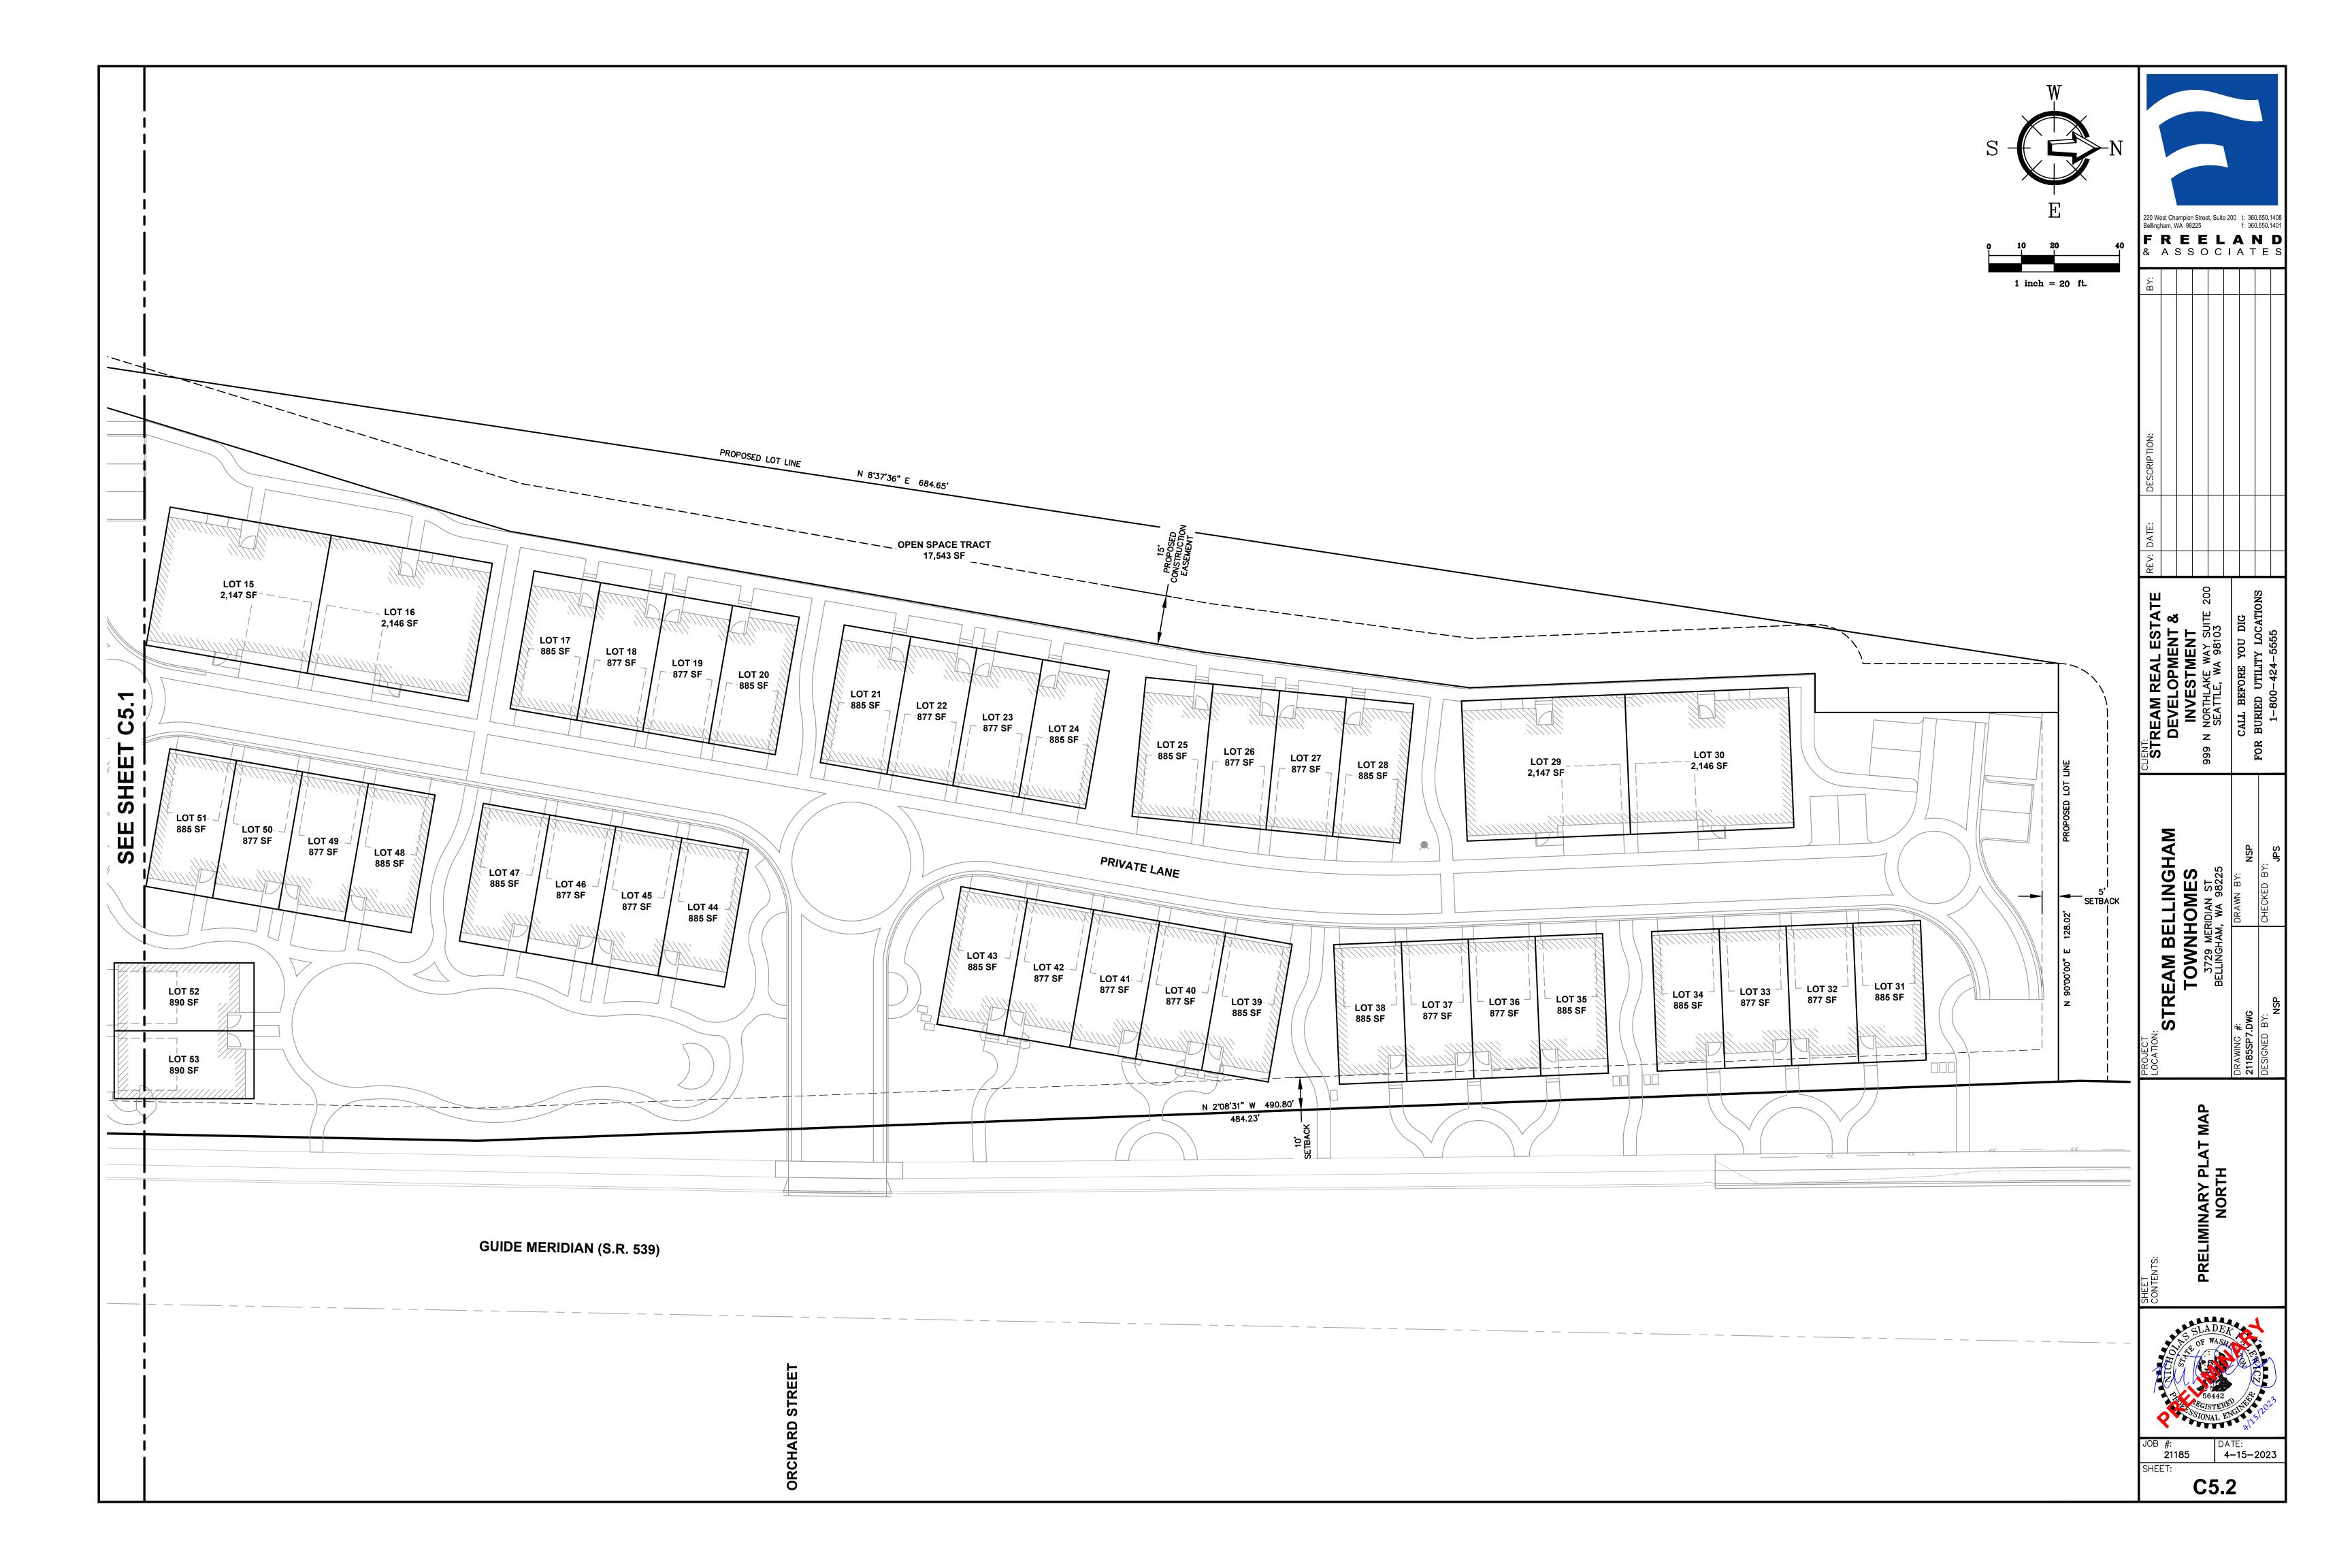

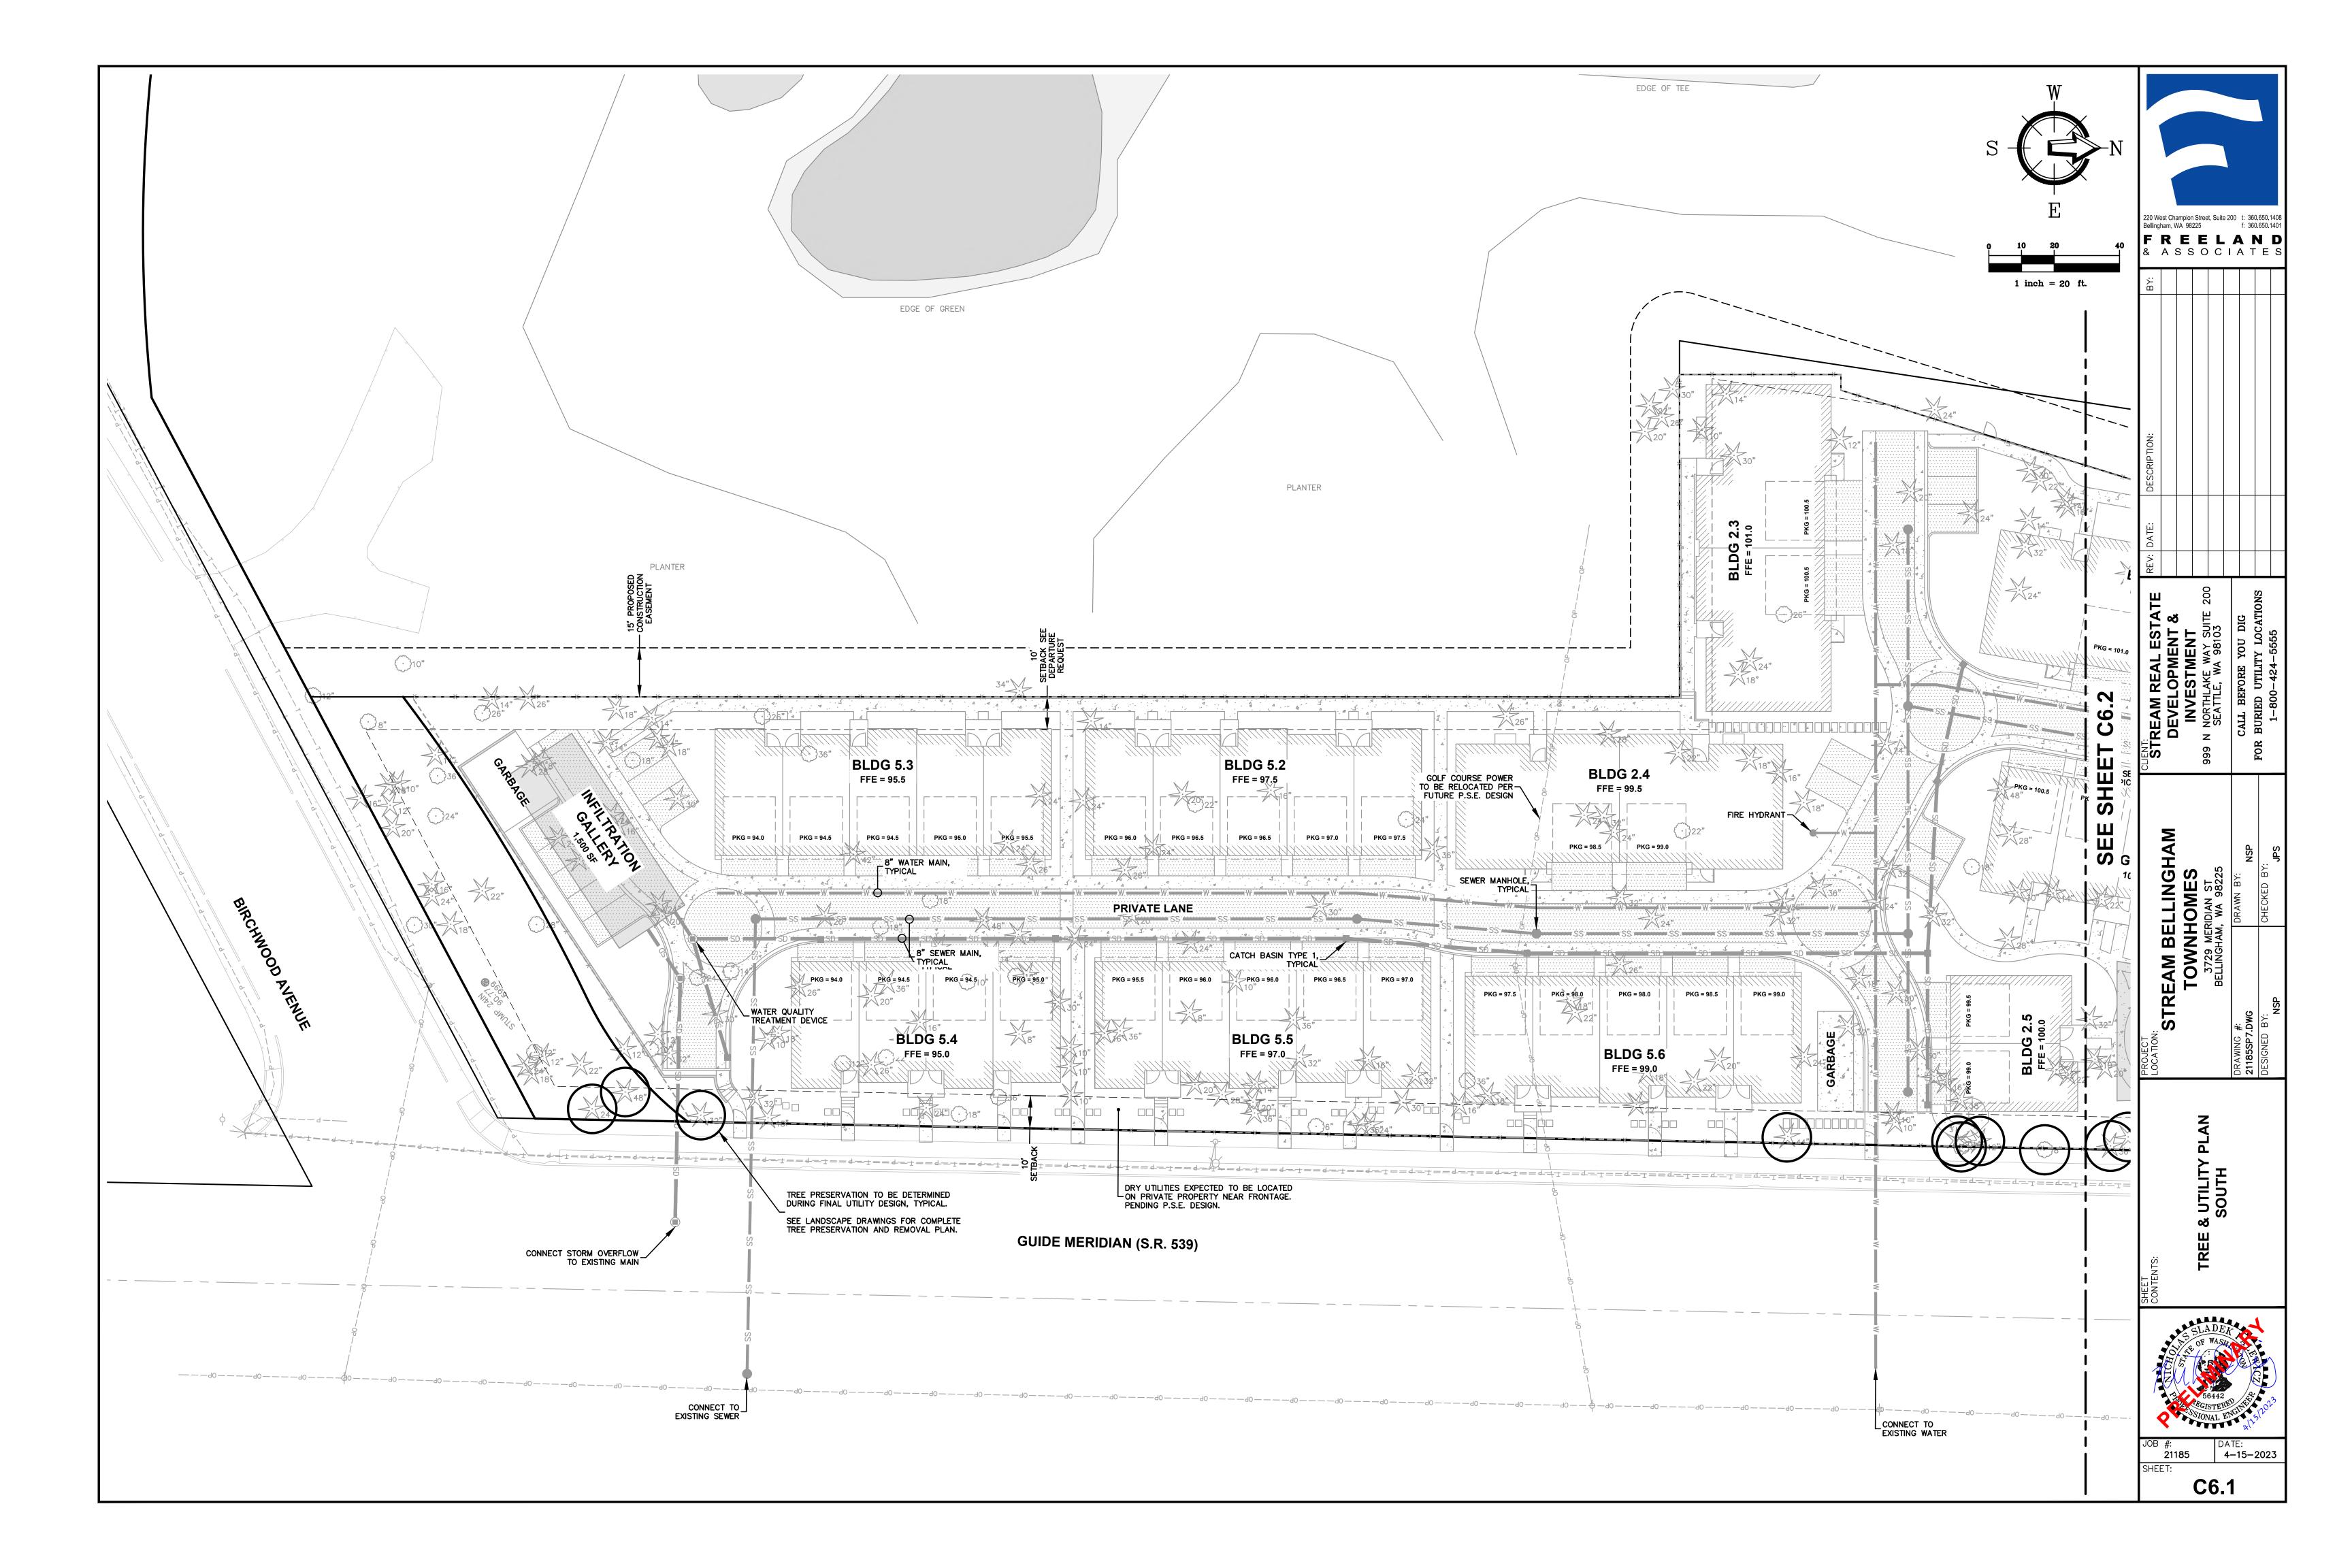

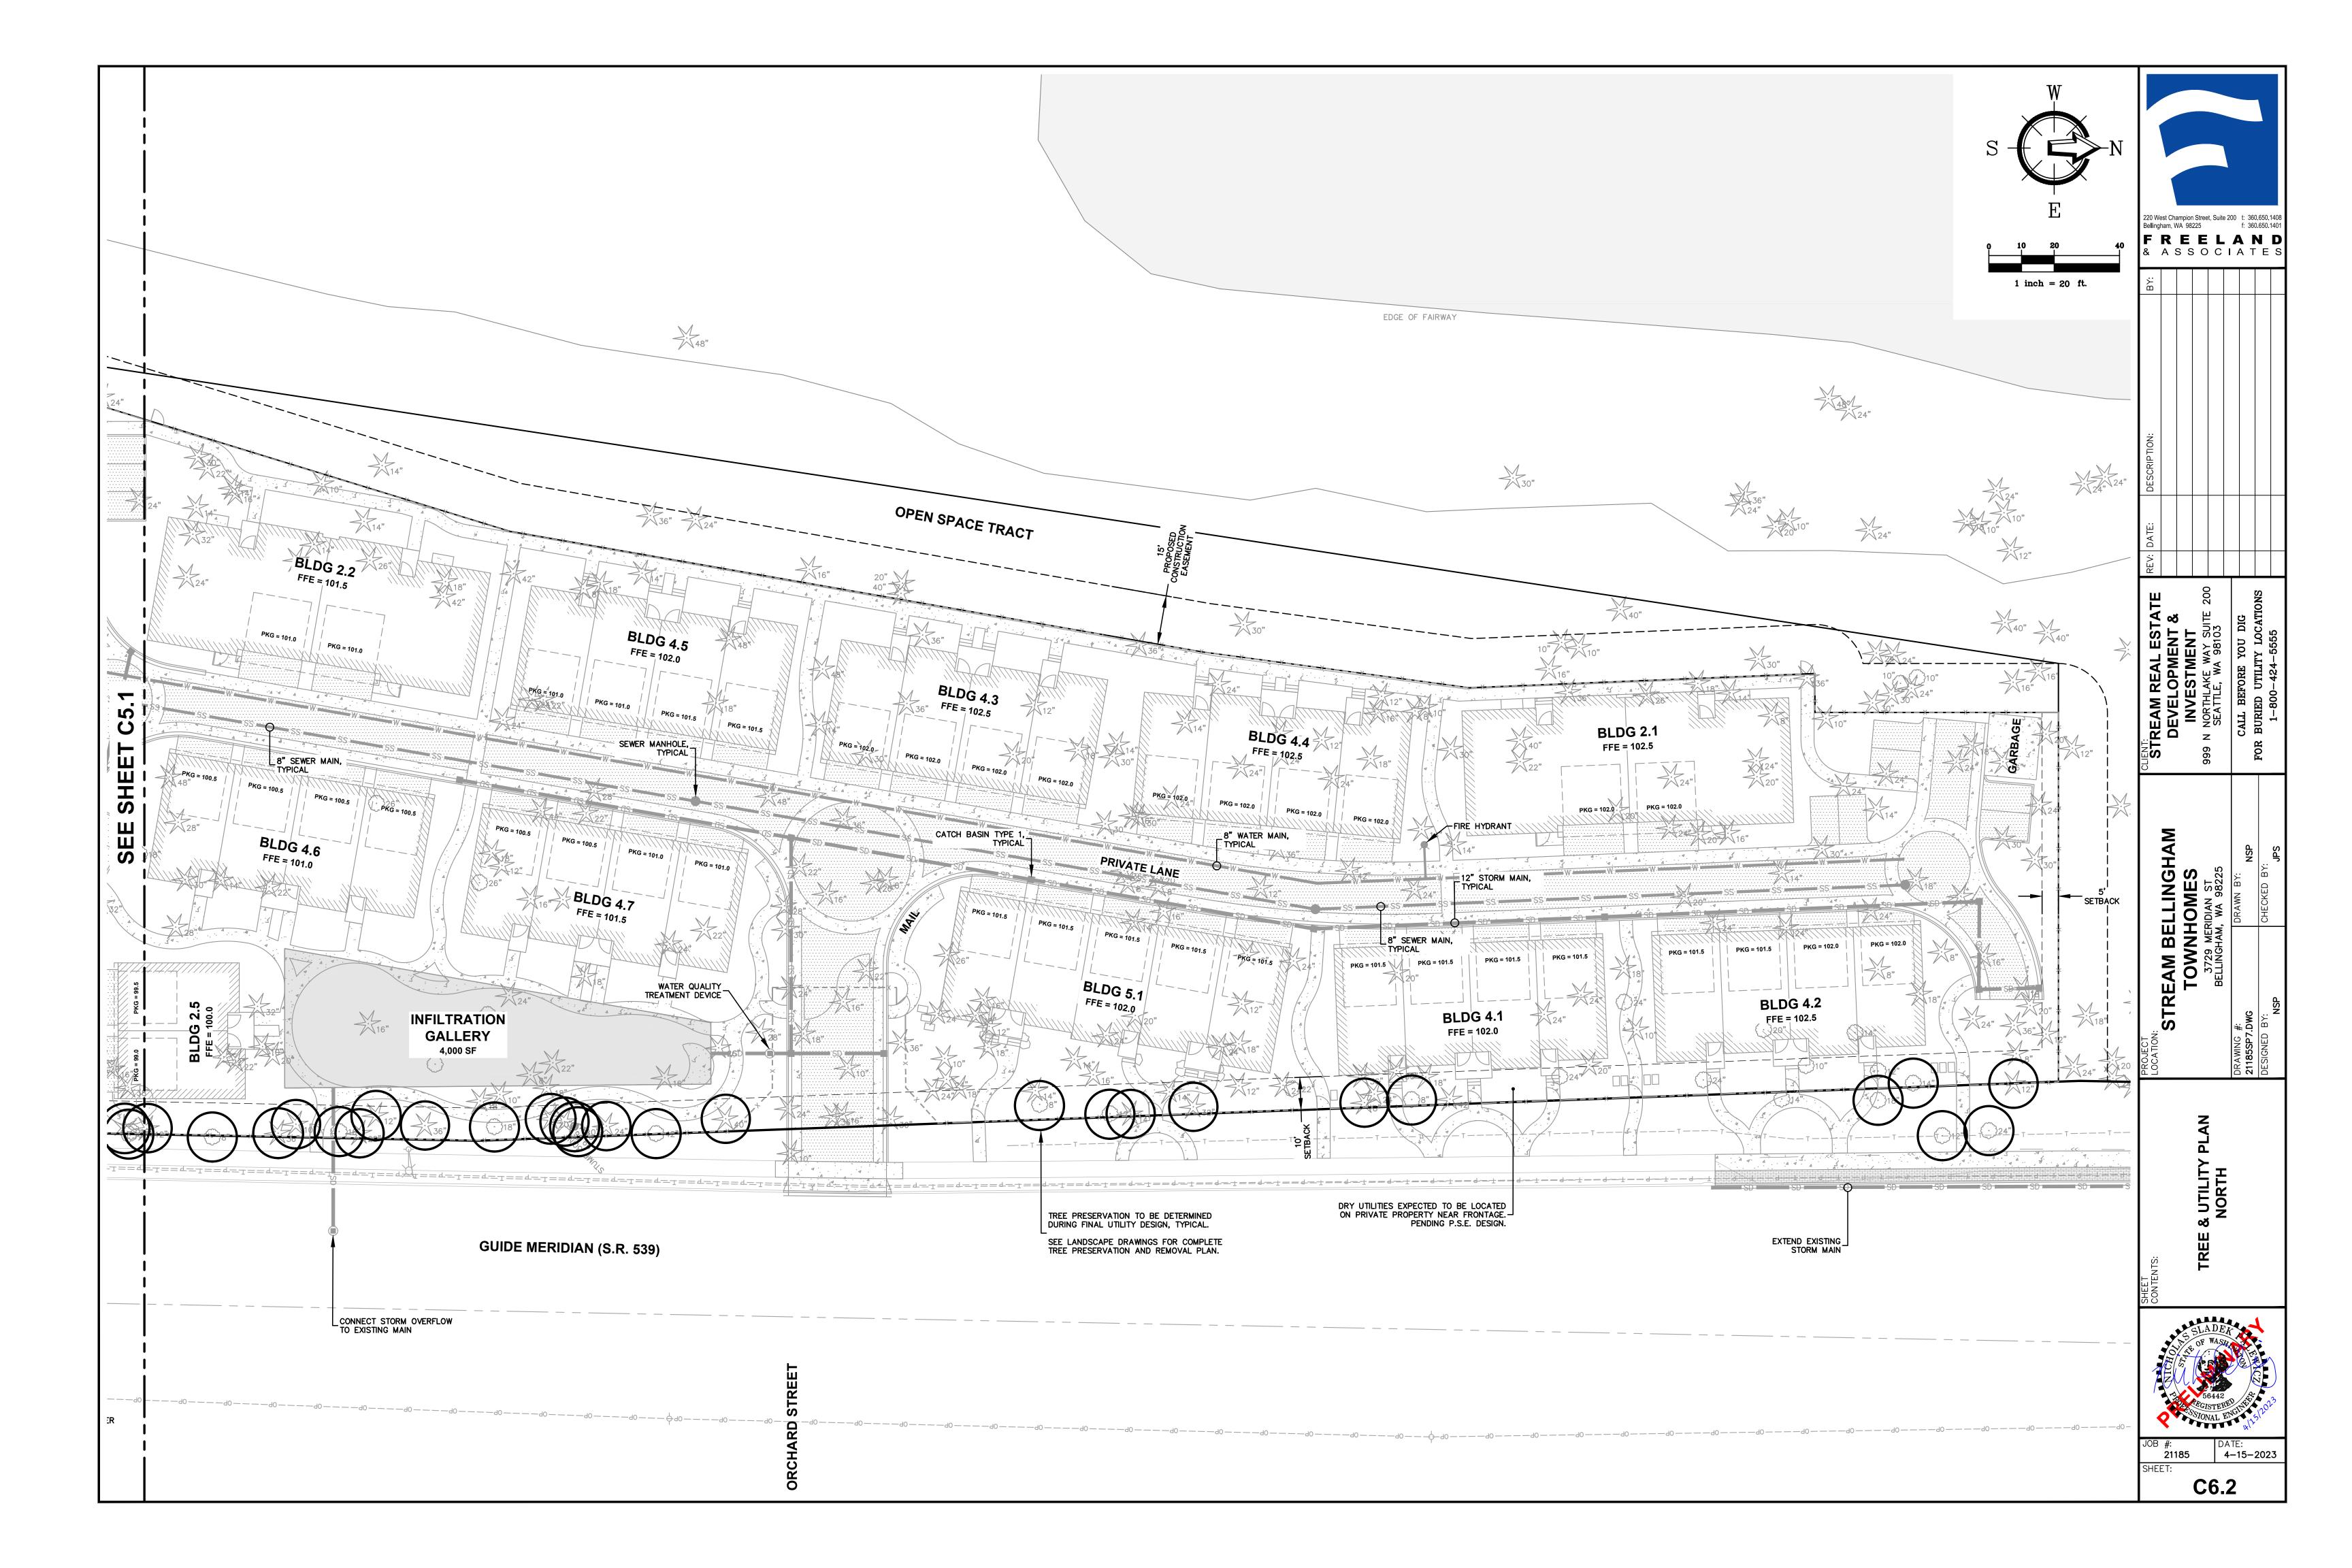







ISSUE DATE: 07/29/22
REISSUE DATE: 01/13/23
REISSUE DATE: 04/17/23
REISSUE DATE: 09/13/23

PROJECT NAME:

TREAM BELLINGHAM
TOWNHOMES
3726 Meridian Street

SHEET NAME:

TREE CALCULATIONS

REMOVED/ REMAIN/ PROPOSED

SCALE:

l"=40'-0"

SHEET NUMBER:

L-0.TC



Oregon White Oak Quercus garryana

COMMON AREA TREES - POSSIBLE TREE LIST

I LARGE TREE (Canopy Spread 30') GREEN FACTOR AREA=100 SF

Proposed at Pocket Park Entrance Botaninc Name Oregon White Oak 2.5" min/50' oc Quercus garryana 2.5" min/50'oc Zelkova serrata Japanese Zelkova



Eddie's White Wonder Dogwood

Cornus "Eddies White Wonder'

Cornus 'Eddie's White Wonder'

Botaninc Name

Styrax japonica

Amelancier canadensis



IO MEDIUM TREES (Canopy Spread 25') GREEN FACTOR AREA=300 SF

Eddie's White Wonder Dogwood

Common Name

Japanese Snowball

Apple Serivceberry

lapanese snowdrop

Styrax japonica

Proposed along Driveways and Common Areas by Parking and Garbage Enclosure



Amelanchier x grandiflora 'Autumn Brilliance'

2.5"/25'oc



Magnolia x Soulangiana

Proposed within or Near Private Yard Spaces

Botaninc Name

Acer palmutum

Malus adirondack

Magnolia x Soulangiana



Magnolia grandiflora "Little Gem"

42 SMALL TREES (Canopy Spread 15') GREEN FACTOR AREA=630 SF

Upright Japanese Maple

No less than 6' ht. at time of installation with min. I" caliper measured one foot above grade

Little Gem Magnolia Tree

Adirocdack Crabapple



Claim Jumper Kasura Tree

Cercidiphyllum japonicum 'Claim Jumper'

15'oc

12'-15'oc






Chamaecyparis obtusa Chamaecyparis nootkatensis Picea pungens 'Hoopsii'

6-NARROW EVERGREEN TREES (Plants 2' or taller) GREEN FACTOR=34 SF

Proposed between building where	space allows	
Botaninc Name	Common Name	Size/ Space
Chamaecyparis obtusa 'Gracilis'	Slender Hinoki Cypress	6'-8'/ 10' oc
Cupressus nootkatensis 'Van den A	kker' Van den Akker Weeping Alaska Cedar	6'-8' ht /15' oc
Picea pungens 'Hoopsii'	Hoopsii Blue Spruce	6'-8' ht/10'oc-20'oc
Picea abies 'Cupressina'	Columnar Norway Spruce 6'-8' ht/ 10'oc	

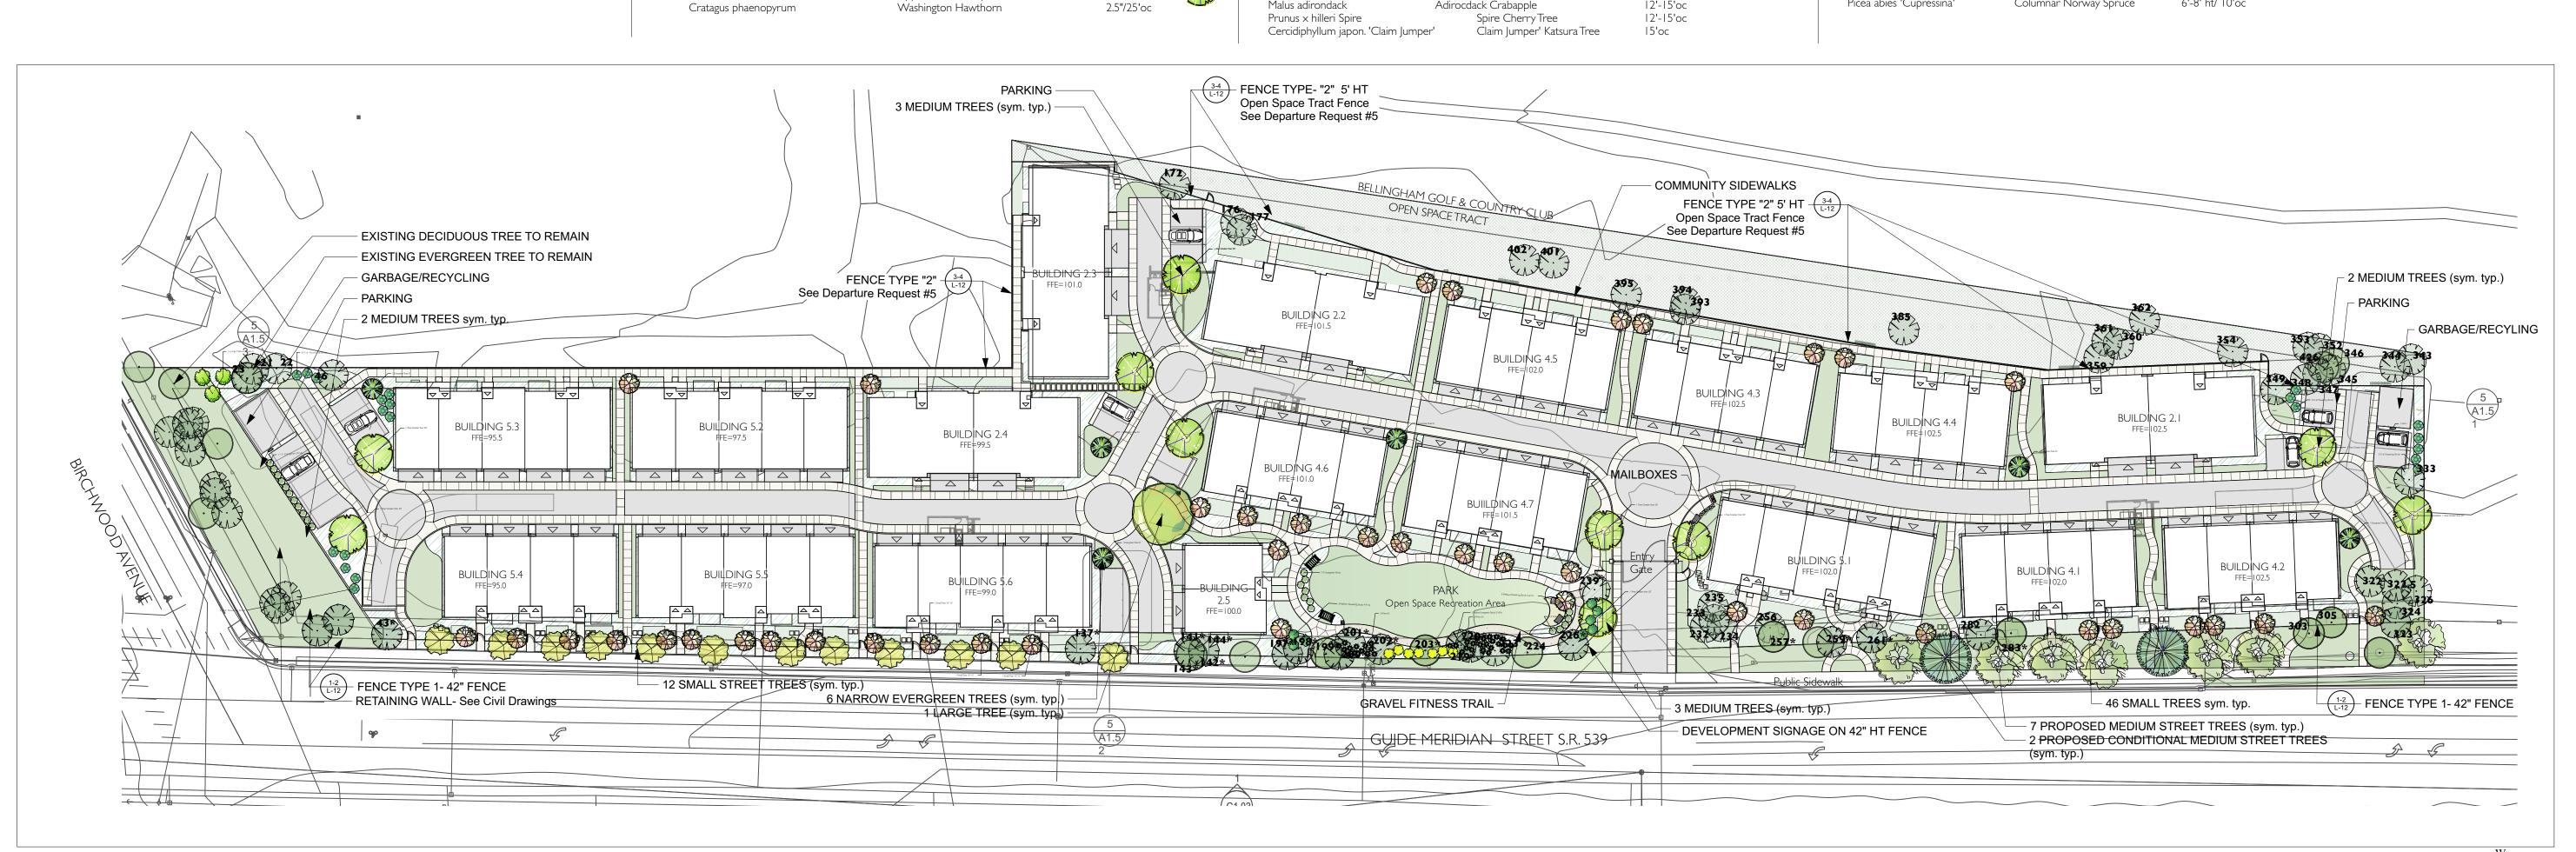



lapanese Hornbeam

Cercidiphyllum japonicum

21 RIGHT OF WAY PLANTING -POSSIBLE TREE LIST

Required: Itree per every 50 lin.ft. = 20 Required / 21 Proposed - PER CODE: STREET TREES SHALL BE NO LESS THAN 10' HT AND HAVE A MIN. CALIPER OF 2.5" MEASURED 1' ABOVE GRADE

12- SMALL STREET	T TREES 2.5" min cal. GREE	N FA	CTOR A	REA=180 SF
Possible columnar and/or narrow (City of Bellingham Approved Street trees for the	e South	end of projec	t site
Botanic Name	Common Name		Space	
Carpinus japonica	Japanese Hornbeam	20' w		~^
Gingko biloba 'Princeton Sentry'	Princeton Sentry Maiden Hair Tree	15' w		
Quercus robur 'Crimson Spire'	Crimson Spira Oak		15' \	



Gingko biloba



Quercus robur 'Crimson Spire'



Botanic Name

Thuja plicata var. Excelsa

Pseudotsuga menziesii

Proposed between building for screening of Meridian



Common Name


Excelsa Western Red Cedar

Douglas Fir



Size / Space

10' 20-25'oc

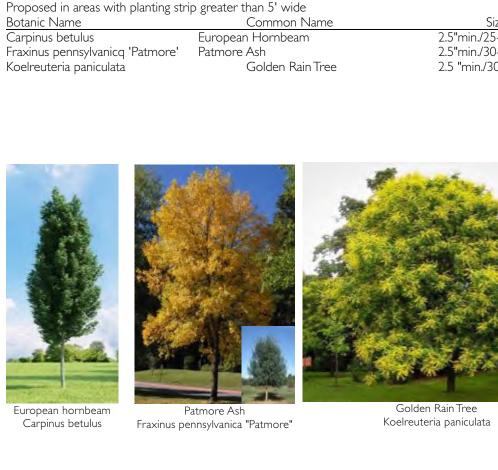

2.5"min./25-30'

2.5"min./30-35'

2.5 "min./30-35'

SEE SHEET L-II FOR GREENFACTOR TOTAL SCORE

GENERAL NOTES: I. No landscape bed shall have artificial impervious materials underneath the surface bed

2. Provisions should be taken to ensure proper drainage. 3. All trees over 8' should be staked for less than one year. 4. No fencing shall be placed between units.

LEGEND:

	•
0	Existing Deciduous Tree to Remain as possible
*	Existing Evergreen Tree to Remain as possible
	Proposed Planting Areas
	Proposed Concrete Sidewalks, Road Pavement Details, + Driveways
ч	Proposed Common Area Lawn
	Proposed Private Lawn
	Proposed Open Space Easement
	Asphalt- Road- Drive lane, Parking, Garbage Areas.
	Proposed Fence / Gate





ISSUE DATE: 7/29/22 REISSUE DATE: 01/13/23 REISSUE DATE: 04/17/23 REISSUE DATE: 09/13/23

PROJECT NAME:

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SHEET NAME:


CONCEPTUAL **LANDSCAPE PLAN**


PROPOSED TREES


SCALE: 1"=40'-0"

SHEET NUMBER:



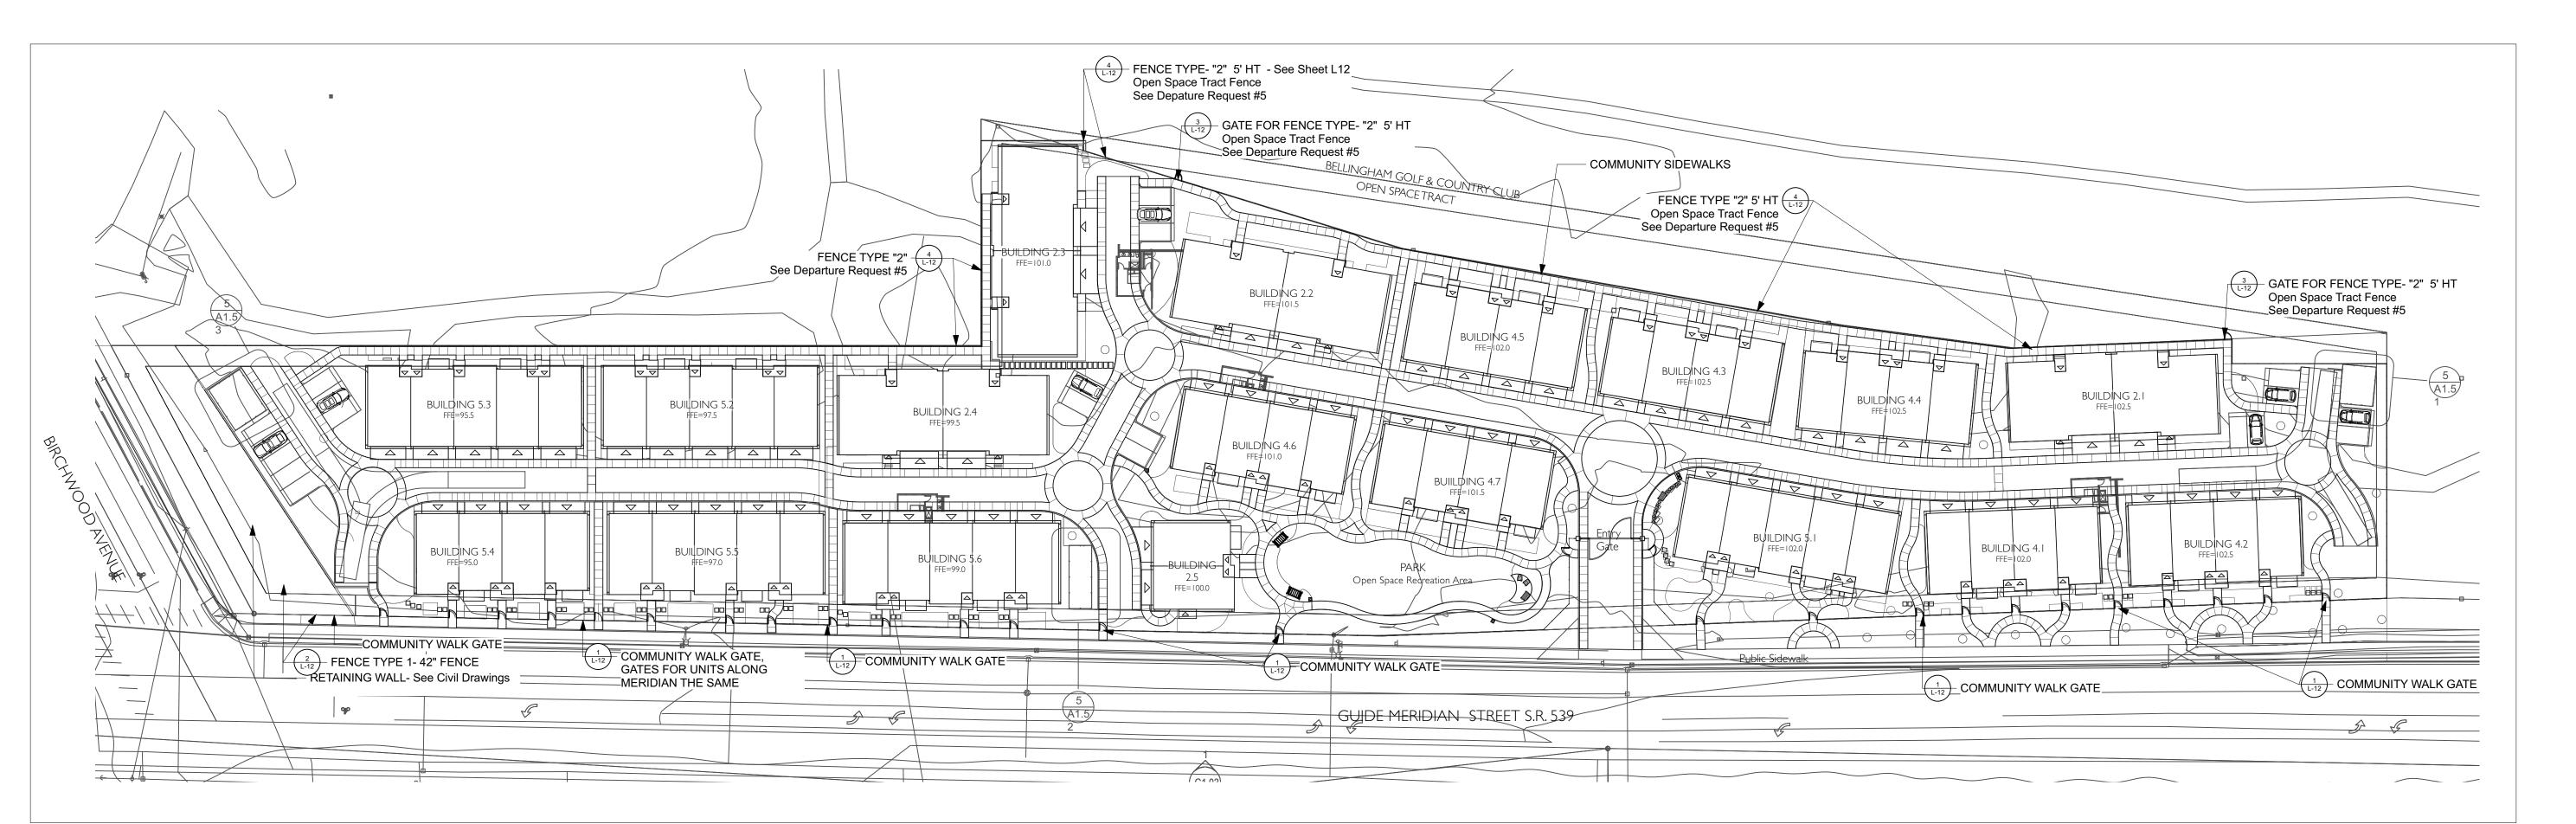

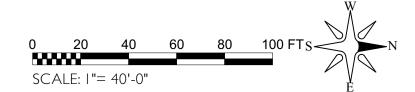

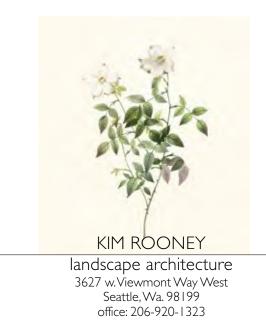



ISSUE DATE: 7/29/22
REISSUE DATE: 01/13/23
REISSUE DATE: 04/17/23
REISSUE DATE: 09/13/23

PROJECT NAME:

TREAM BELLINGHAM
TOWNHOMES
3726 Meridian Street
Bellingham, Washington 98225

SHEET NAME:


CONCEPTUAL LANDSCAPE PLAN


PROPOSED TREES

SCALE: 1"=40'-0"

SHEET NUMBER:

L-I.B

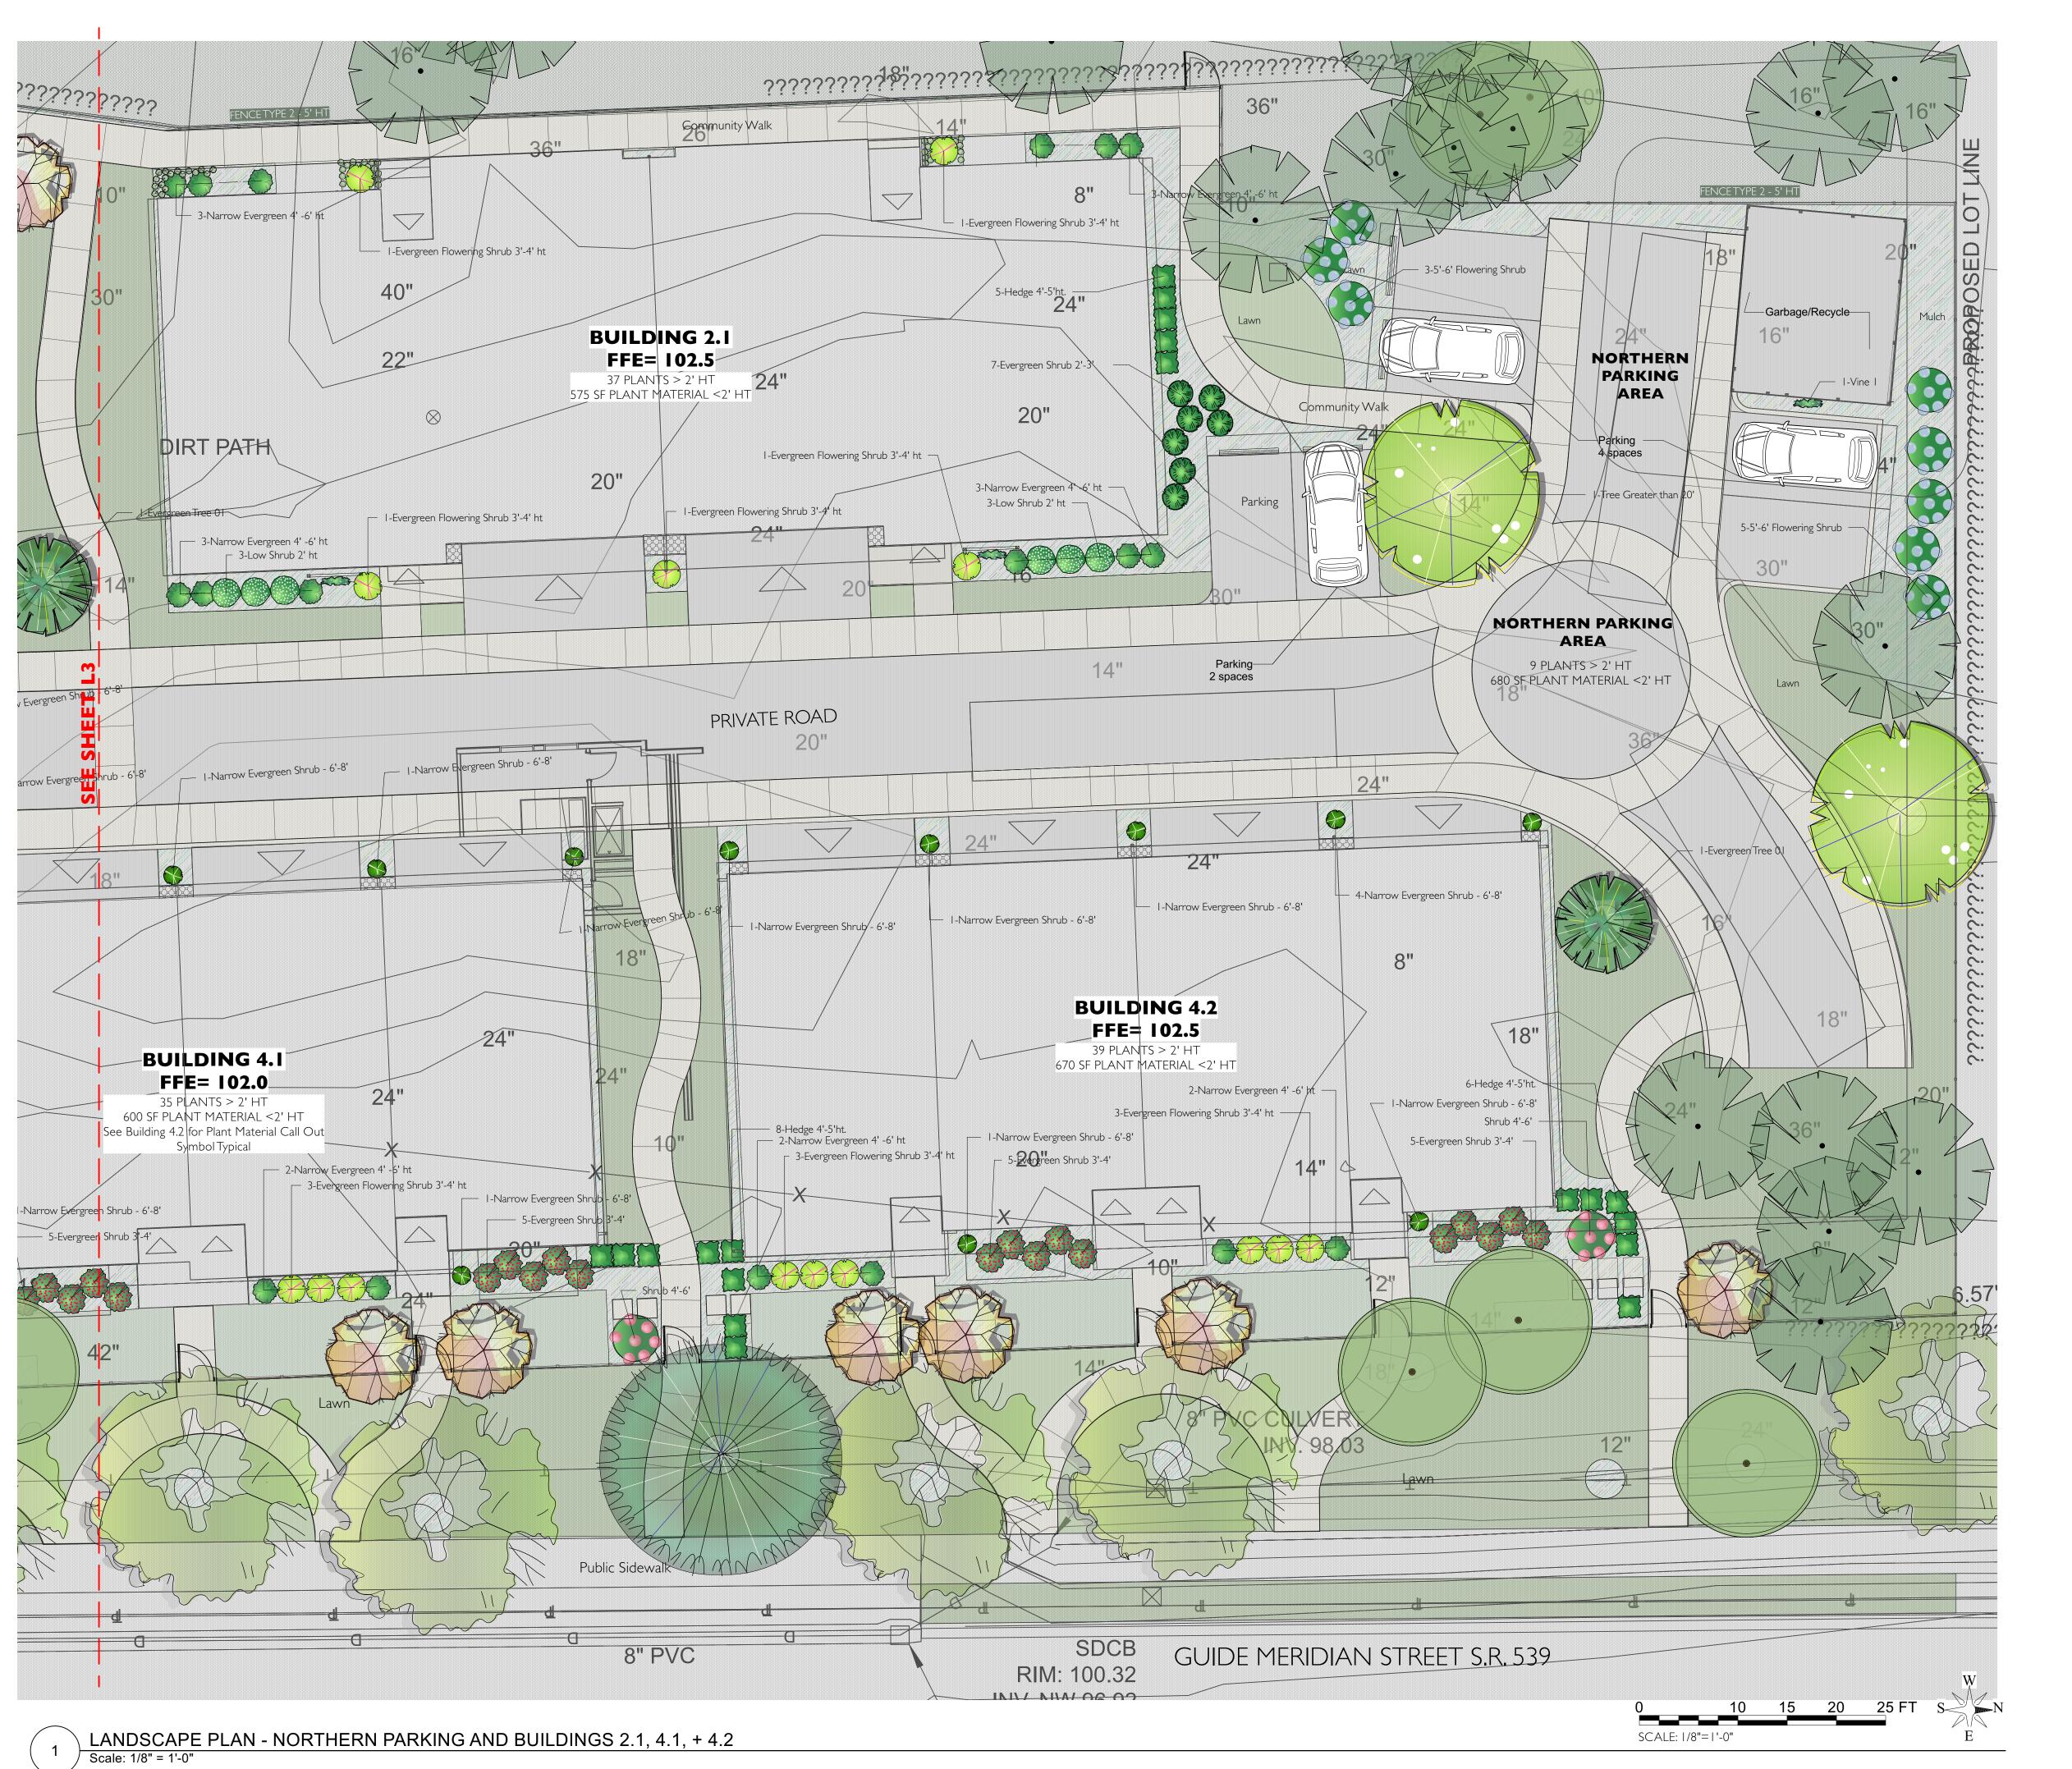

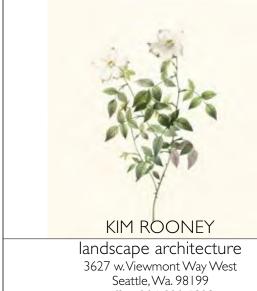



office: 206-920-1323

ISSUE DATE: 7/29/22
REISSUE DATE: 01/13/23
REISSUE DATE: 04/17/23
REISSUE DATE: 09/13/23

PROJECT NAME:

EAM BELLINGHAM TOWNHOMES 3726 Meridian Street lingham, Washington 98225

SHEET NAME:

S

CONCEPTUAL LANDSCAPE PLAN

Northern Parking Area + Buildins 2.1, 4.1, 4.2

SCALE: 1/8" = 1'-0"

SHEET NUMBER:







office: 206-920-1323

ISSUE DATE: 7/29/22 REISSUE DATE: 01/13/23 REISSUE DATE: 04/17/23 REISSUE DATE: 09/13/23

PROJECT NAME:

BELLING

SHEET NAME:


CONCEPTUAL **LANDSCAPE PLAN**

BUILDINGS 4.3, 4.4, + 5.1

SCALE: 1/8" = 1'-0"

SHEET NUMBER:



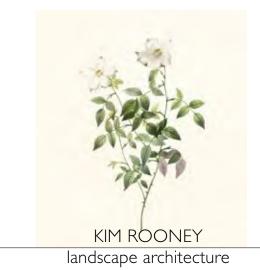

3627 w.Viewmont Way West Seattle, Wa. 98199 office: 206-920-1323



ISSUE DATE: 7/29/22
REISSUE DATE: 01/13/23
REISSUE DATE: 04/17/23
REISSUE DATE: 09/13/23

PROJECT NAME:

STREAM BELLINGHAM
TOWNHOMES
3726 Meridian Street

SHEET NAME:

CONCEPTUAL LANDSCAPE PLAN

BUILDINGS 2.2, 4.5, 4.6 + 4.7

SCALE: 1/8" = 1'-0"

SHEET NUMBER:







ISSUE DATE: 7/29/22 REISSUE DATE: 01/13/23 REISSUE DATE: 04/17/23 REISSUE DATE: 09/13/23

PROJECT NAME:

BELLIN

SHEET NAME:

CONCEPTUAL LANDSCAPE PLAN CENTRAL PARKING

+ 2.3 + 2.4

SCALE: 1/8" = 1'-0"

SHEET NUMBER:

LANDSCAPE PLAN - BUILDINGS 5.6 + 2.5

Scale: 1/8" = 1'-0"

KIM ROONEY

landscape architecture
3627 w.Viewmont Way West
Seattle, Wa. 98199
office: 206-920-1323



ISSUE DATE: 7/29/22
REISSUE DATE: 01/13/23
REISSUE DATE: 04/17/23
REISSUE DATE: 09/13/23

PROJECT NAME:

EAM BELLINGHAM
TOWNHOMES
3726 Meridian Street

SHEET NAME:


CONCEPTUAL LANDSCAPE PLAN


BUILDING 2.5+ 5.6

SCALE: 1/8" = 1'-0"

SHEET NUMBER:

SCALE: 1/8"=1'-0"

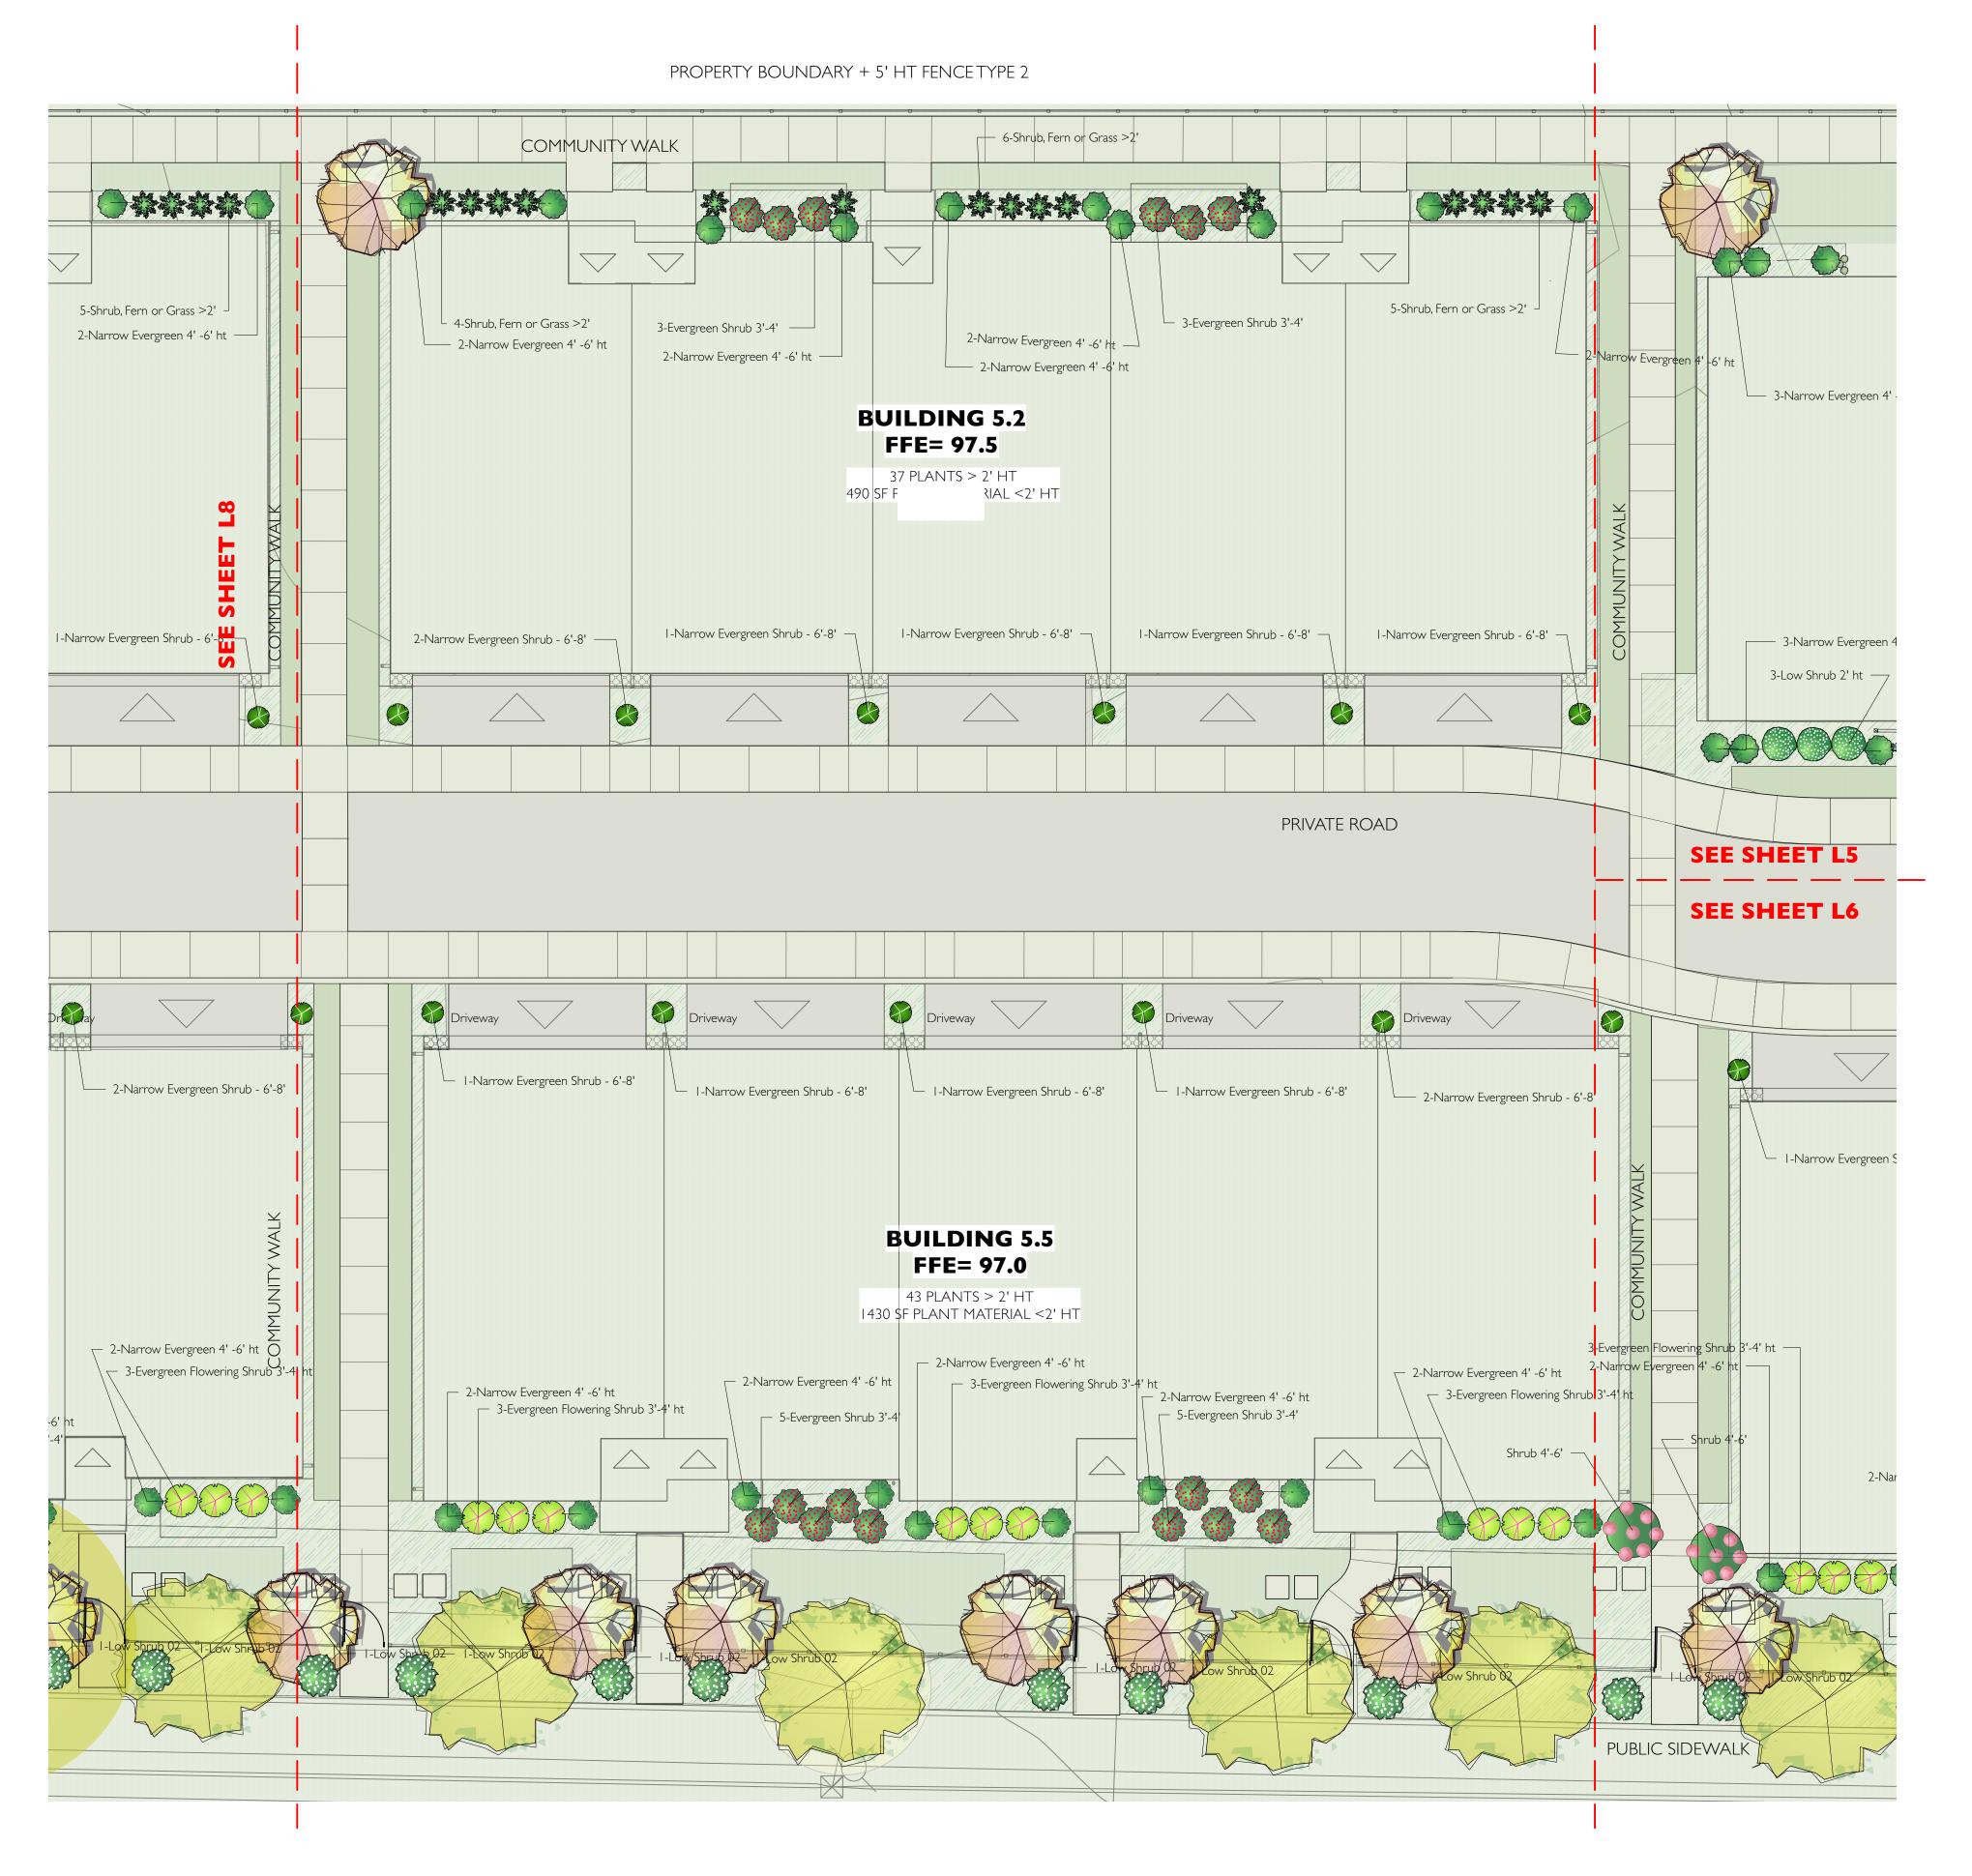

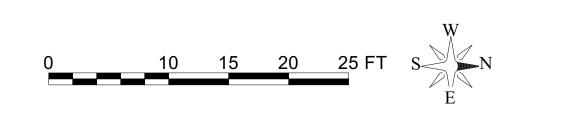

KIM ROONEY

landscape architecture
3627 w.Viewmont Way West
Seattle, Wa. 98199
office: 206-920-1323



ISSUE DATE: 7/29/22
REISSUE DATE: 01/13/23
REISSUE DATE: 04/17/23
REISSUE DATE: 09/13/23

PROJECT NAME:

SEAM BELLINGHAM
TOWNHOMES
3726 Meridian Street


SHEET NAME:

CONCEPTUAL LANDSCAPE PLAN

BUILDING 5.2+ 5.5

SCALE: 1/8" = 1'-0"

SHEET NUMBER:

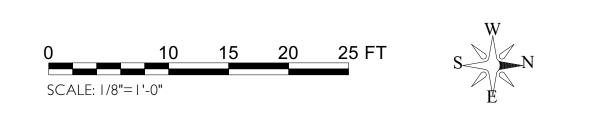

KIM ROONEY

landscape architecture
3627 w.Viewmont Way West
Seattle, Wa. 98199



office: 206-920-1323

ISSUE DATE: 7/29/22
REISSUE DATE: 01/13/23
REISSUE DATE: 04/17/23
REISSUE DATE: 09/13/23

PROJECT NAME:

EAM BELLINGHAM
TOWNHOMES
3726 Meridian Street

SHEET NAME:

CONCEPTUAL LANDSCAPE PLAN

BUILDINGS 5.3 + 5.4

SCALE: 1/8" = 1'-0"

SHEET NUMBER:







ISSUE DATE: 7/29/22
REISSUE DATE: 01/13/23
REISSUE DATE: 04/17/23
REISSUE DATE: 09/13/23

PROJECT NAME:

STREAM BELLINGHAM TOWNHOMES 3726 Meridian Street

SHEET NAME:

CONCEPTUAL LANDSCAPE PLAN

Southern Parking Area

SCALE: 1/8" = 1'-0"

SHEET NUMBER:

NEIGHBORHOOD POCKET PARK- MICRO GATHERING AREAS PLACES TO CONNECT WITH NEIGHBORS FRONT PORCH AND/OR BACK YARD SITE FURNISHING













Outdoor Fitness Equipment

NEIGHBORHOOD POCKET PARK





Community Mail Box- Gatering Area

landscape architecture 3627 w.Viewmont Way West Seattle, Wa. 98199 office: 206-920-1323

> **ISSUE DATE**: 7/29/22 REISSUE DATE: 01/13/23 REISSUE DATE: 04/17/23 REISSUE DATE: 09/13/23

PROJECT NAME:

SHEET NAME:

CONCEPTUAL **LANDSCAPE PLAN**


COMMUNITY PARK

SCALE: 1/8" = 1'-0"

SHEET NUMBER:

L-IO




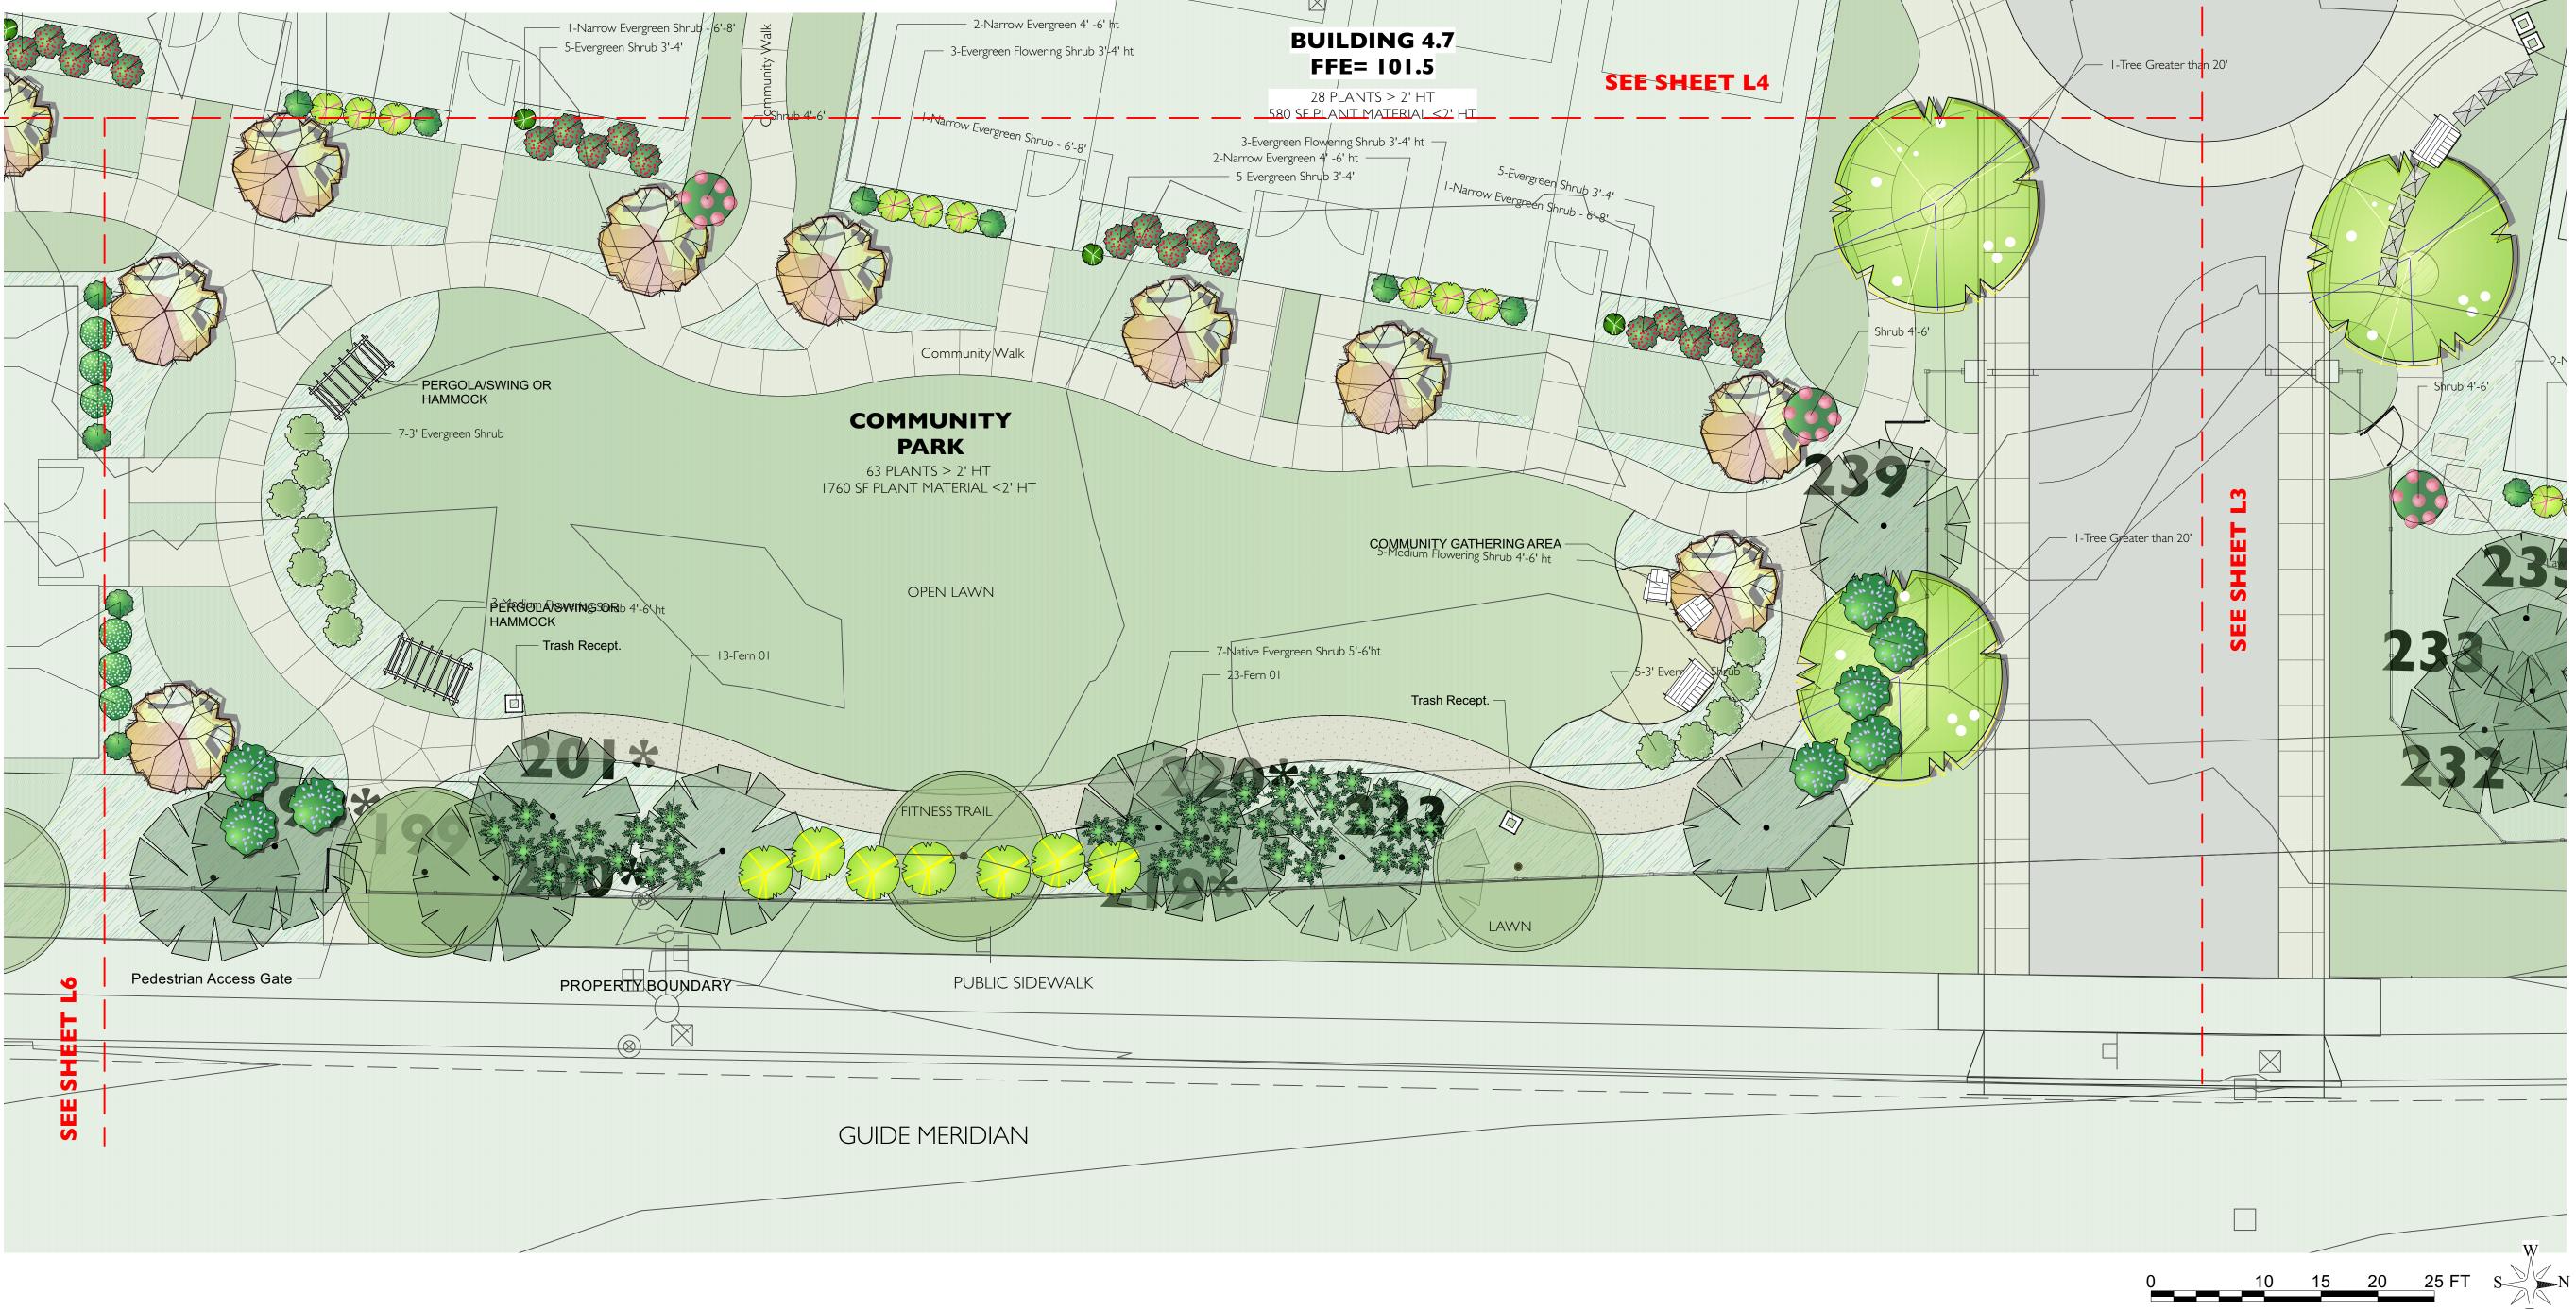






Crushed Gravel Path Tree Lined Gravel Path /adjacent Open Lawn

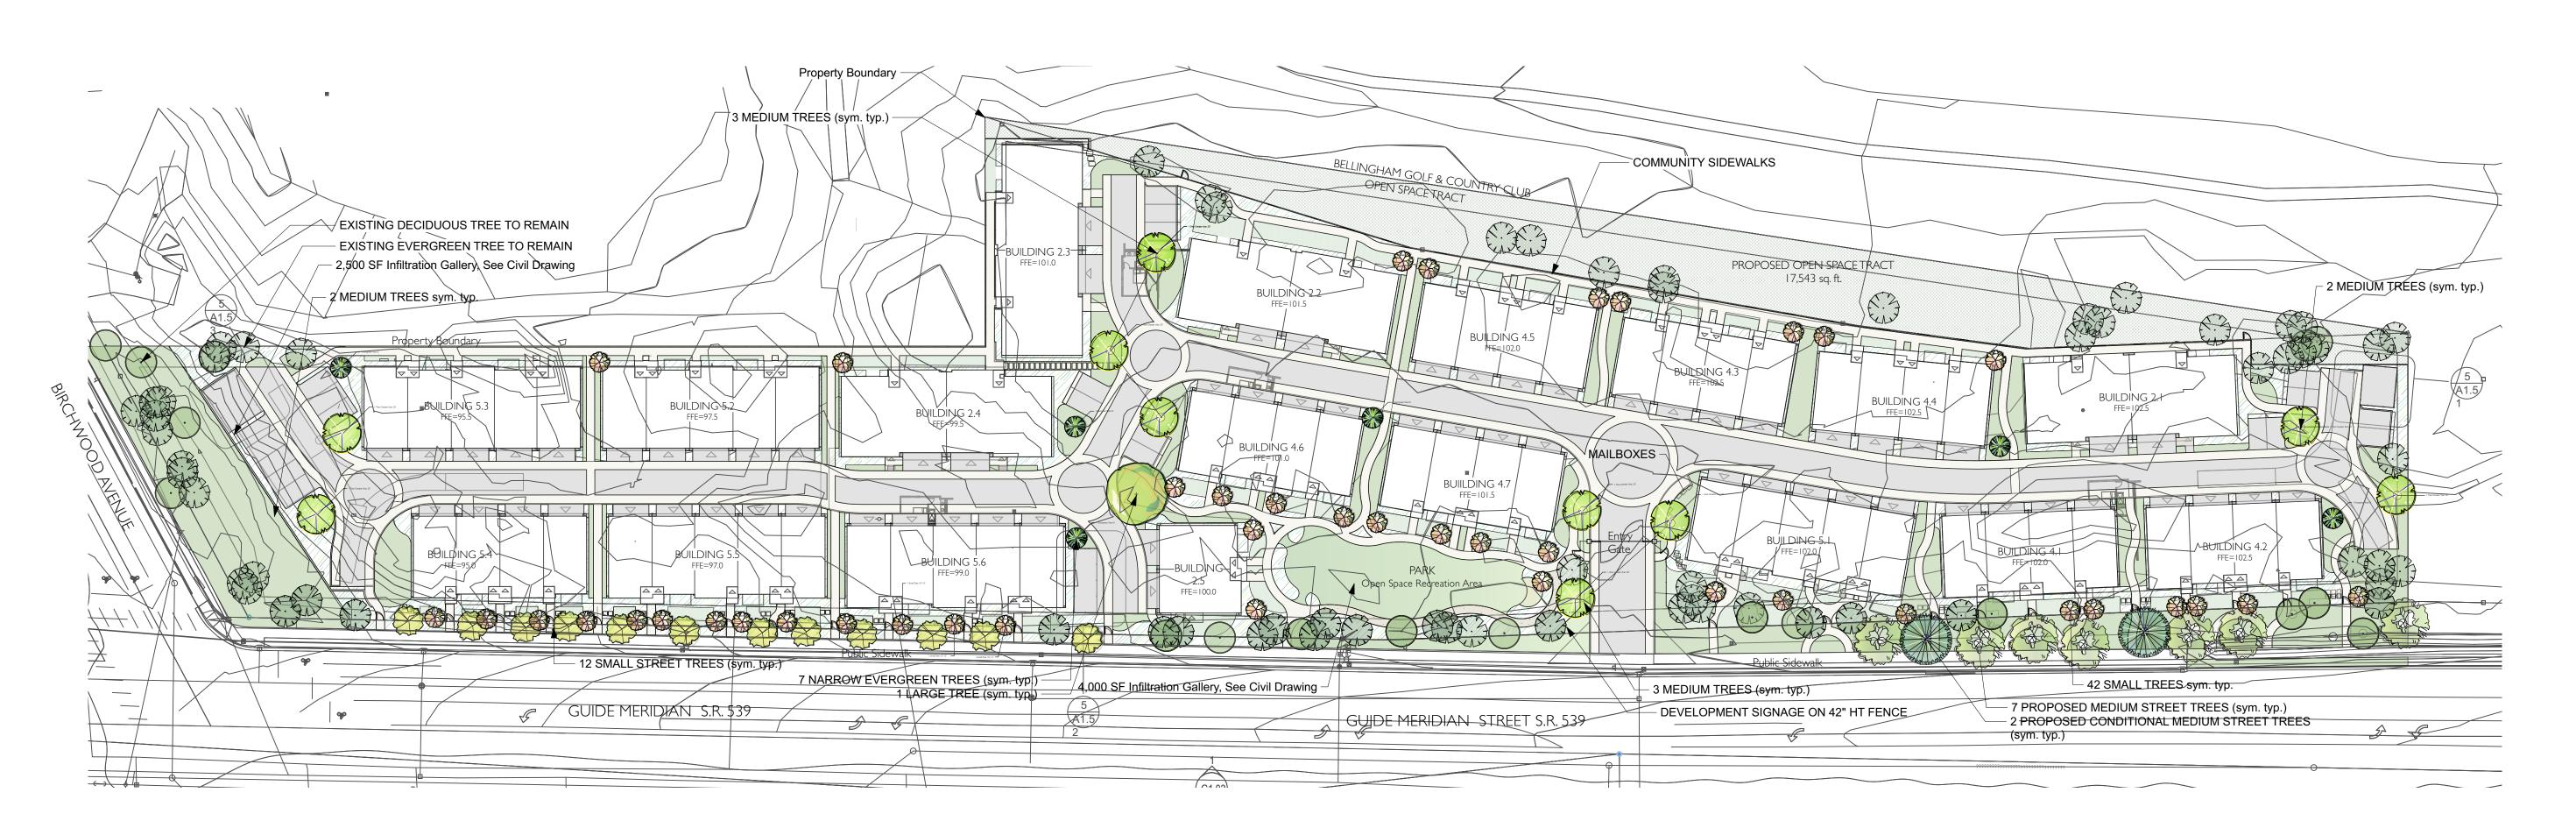

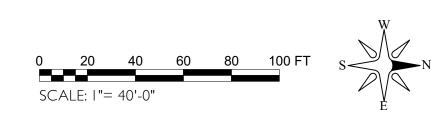


1 GREEN FACTOR CALCULATION PLAN Scale: 1" = 40'-0"

a. Groundcover or othe Common Name	er plants less than 2' fee Botanic Name	Spacing		(GF SCORE 3842. Evergreen
Kinnickinick	Arctostaphylos uva-ursi	2' oc	X	X
Deer Fern	Blechnum spicant	2' oc	X	X
Low Oregon Grape	Mahonia repens	3'oc	X	X
Winter Creeper	Euonymous fort.	8" oc	^	X
apanese Forest Grass Hache	•	2'oc		X
apanese Forest Grass Flache Dwarf Candytuft	Iberis sempervirens	2'oc		X
Harbor Dwarf Nandina	Nandina dom.'Harb. Dwarf	2 oc 2''oc		X
Periwinkle	Vinca Minor 'Bowles'	2 oc 8" oc		X
Hosta varities Hosta	VIIIca Millior Bowles	6 0c 1'-3' oc		^
Sweet Woodruff	Galium odoratum	1 -3 OC 1 oc		
	er = 695 Plants (GF SCO			
Common Name	Botanic Name	Spacing	Native	Evergreen
Serviceberry	Amelanchier			
Tall Oregon Grape	Mahonia aquifolium	5'-6'	X	X
Sala	Gaultheria shallon Salal	4'oc	X	X
Nootka Rose	Rosa nutkana	5'oc	X	
Sword fern	Polystichum munitum	3'oc	X	X
Red-flowering Current	Ribes sanguineum	5'-6'oc	X	
Snowberry	Symphoricarpos albus	5' oc	X	
Evergreen Huckleberry	Vaccinium ovatum	5'oc	X	X
Mexican Orage	Choysia ternata	6' oc		X
Heavenly Bamboo	Nandina domestica	5'oc		X
Hydrangea	Hydrangea spp.	5'-6'		
Knock Out® Shrub Rose	Rosa x 'Radrazz'	4'-5'oc		
Miss Kim Lilac	Syringa x. pat. 'Miss Kim'	5'oc		
Spirea	Spirea spp.	2'-6'oc		
Carl Forester Grass	Calamagrostis x acutiflora	3' oc.		
Maiden Grass	Misacnthus spp.	3'-4'oc		
Muhly Grass	Muhlenbergia capillaris	3' oc	X	
Dwarf Fountain Grass	Pennisetum alopecuroides	3' oc		
Rhododendron	Rhododendron spp.	5-6' oc	X	X
Azalea	Azalea spp.	2'-4' oc	X	X
Pieris	Pieris spp.			
4. Vegetative Walls - 2.	• Vine of Garbage Encloser F	ence (GF SCC	ORE 40)	
Common Name	Botanic Name	Spacing	,	Evergreen
Climbing Hydrangea	Hydrangea	20'		
Evergreen Clematis	Clematis	15'		X
Asian Jasmine	Trachelospermum asia.	12'		X
Climbing Rose	Rosa 'Alchymist'	12'		
Honeysuckle	Lonicera ciliosa	12'		
SEE SHEET LI FORTREE GR 2 MEDIUMTREES PER 8 PAI				

TOTAL GREEN FACTOR SCORE FOR PLANTING				
Building/Area	Plants >2'	Plants <2' SF		
2.1	37	575		
2.2	34	1145		
2.3	34	530		
2.4	38	810		
2.5	12	1090		
4.1	35	600		
4.2	39	670		
4.3	27	530		
4.4	27	410		
4.5	27	465		
4.6	28	655		
4.7	28	580		
5.1	39	1260		
5.2	37	490		
5.3	38	550		
5.4	42	1320		
5.5	43	1420		
5.6	43	1650		
Northern Parking	9	680		
Southern Parking	27	2020		
Community Park	63	1760		
Total	713	19210		

	r Landscape Element	Multiplier	Total	Sq. Ft.	GF Score
1. Landscap	ed Areas (select one of the following for each are	a):			
a. Landscape	areas with soil depth of less than 24"	0.1			0
b. Landscape areas with soil depth of 24" or greater		0.8		50023	40018.4
c. Bioretention facility		1		6,500	6,000
Southern Infiltration Gallery (2,500 Total)					
	Northern Infiltration Gallery (4,000 Total)				
2. Planting (credit for plants in landscaped areas above):				
maturity. For D	and covers, or other plants less than two feet tall at Detailed Break Down of Planting Credits, See areas Sheet (Sheets L2-L13)	0.2		19210	3842
plant. For Deta	feet or Taller at Maturity, calculated at 16' square feet per ailed Break Down of Planting Credits, See Landscaped Sheets L2-L13)	0.3	713	11408	3422.4
	of for small trees in Bellingham List of Approved Street alent (canopy spread of 15') calculated at 50 sq. Ft. Per	0.3	54	2700	810
(et L1)				
	Small Street Trees Along Meridian (12 Total)				
	,				
d. Tree canopy Approved Stre	Small Street Trees Along Meridian (12 Total)	0.3	10	1000	300
d. Tree canopy Approved Stre	Small Street Trees Along Meridian (12 Total) Small Trees (42 Total) If for small trees/medium trees in Bellingham List of the trees or equivalent (canopy spread of 20') calculated	0.3	10	1000	300
d. Tree canopy Approved Stre at 100 sq. Ft. I e. Tree canopy Trees or equive	Small Street Trees Along Meridian (12 Total) Small Trees (42 Total) If for small trees/medium trees in Bellingham List of set Trees or equivalent (canopy spread of 20') calculated Per tree. (See Sheet L1) Medium Trees (10 Total) If for medium trees in Bellingham List of Approved Street salent (canopy spread of 25') calculated at 150 sq. Ft. Per	0.3	10	1000	300
d. Tree canopy Approved Stre at 100 sq. Ft. I e. Tree canopy Trees or equive	Small Street Trees Along Meridian (12 Total) Small Trees (42 Total) If for small trees/medium trees in Bellingham List of set Trees or equivalent (canopy spread of 20') calculated Per tree. (See Sheet L1) Medium Trees (10 Total) If for medium trees in Bellingham List of Approved Street salent (canopy spread of 25') calculated at 150 sq. Ft. Per				
d. Tree canopy Approved Stre at 100 sq. Ft. I e. Tree canopy Trees or equive	Small Street Trees Along Meridian (12 Total) Small Trees (42 Total) If for small trees/medium trees in Bellingham List of the trees or equivalent (canopy spread of 20') calculated tree. (See Sheet L1) Medium Trees (10 Total) If for medium trees in Bellingham List of Approved Street the following spread of 25') calculated at 150 sq. Ft. Per tet L1)				
d. Tree canopy Approved Stre at 100 sq. Ft. I e. Tree canopy Trees or equive tree. (See She	Small Street Trees Along Meridian (12 Total) Small Trees (42 Total) If for small trees/medium trees in Bellingham List of the trees or equivalent (canopy spread of 20') calculated tree. (See Sheet L1) Medium Trees (10 Total) If for medium trees in Bellingham List of Approved Street the falent (canopy spread of 25') calculated at 150 sq. Ft. Per tet L1) Medium Street Trees Along Meridian (7 Total)				
d. Tree canopy Approved Stre at 100 sq. Ft. I e. Tree canopy Trees or equive tree. (See She	Small Street Trees Along Meridian (12 Total) Small Trees (42 Total) If for small trees/medium trees in Bellingham List of the trees or equivalent (canopy spread of 20') calculated tree. (See Sheet L1) Medium Trees (10 Total) If for medium trees in Bellingham List of Approved Street the left (canopy spread of 25') calculated at 150 sq. Ft. Per tet L1) Medium Street Trees Along Meridian (7 Total) Medium Conditional Street Trees Along Meridian (2 Total) If or large trees in Bellingham List of Approved Street	0.4	9	1350	540

Green Factor	Landscape Element	Multiplier	Total	Sq. Ft.	GF Scor
3. Green Roofs	s		<u> </u>		
a. Over at least 2	2" and less than 4" of growth medium	0.4		0	0
b. Over at least 4	b. Over at least 4" of growth medium			0	0
4. Vegetative \	4. Vegetative Walls			0	0
5. Approved W	/ater Feature	0.7		0	0
6. Permeable	Paving				
a. Permeable Pa	ving over at least 6" and less than 24" of soil or gravel	0.3		0	0
b. Permeable pa	ving over at least 24" of soil or gravel	0.5		0	0
	Permeable Fire Truck Entrance (Permeable Paving Grid	d with Grass) (950 Tota	al)	
7. Structural S	Soils	0.4			0
8. Bonuses					
a. Drought Tolera	ant or Native Plant Species	0.1	10	160	16
	areas where at least 50% of annual irrigation needs are use of harvested rainwater	0.2		0	0
c. Landscaping i	in food cultivation	0.3		0	0
Total Lot Area:			1		179793
Total Green Factor Area					72604.8
Total Green Factor Area Score					0.4038
					31.1330

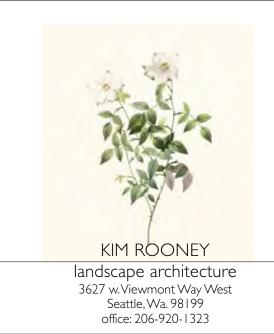



ISSUE DATE: 7/29/22
REISSUE DATE: 01/13/23
REISSUE DATE: 04/17/23
REISSUE DATE: 09/13/23

PROJECT NAME:

TREAM BELLINGHAM TOWNHOMES

SHEET NAME:


GREEN
FACTOR
LANDSCAPE
ELEMENTS


SCALE: 1"=40'-0"

SHEET NUMBER:

L-||


TYPE 1 FENCE - SEE SHEET L1.B FENCE AND GATE PLAN

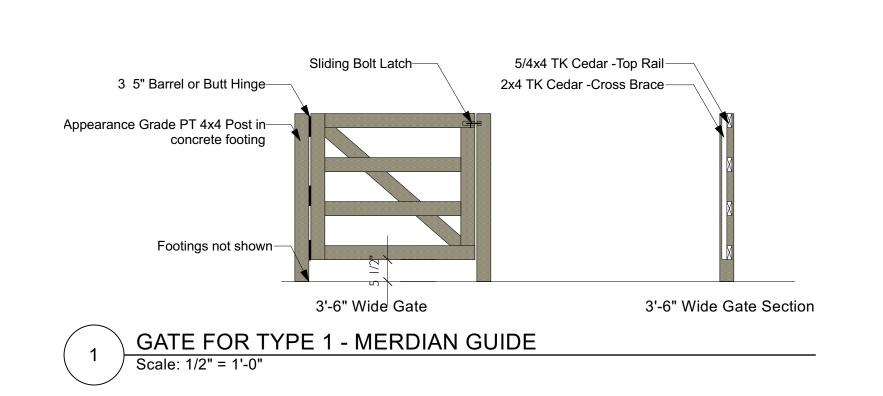

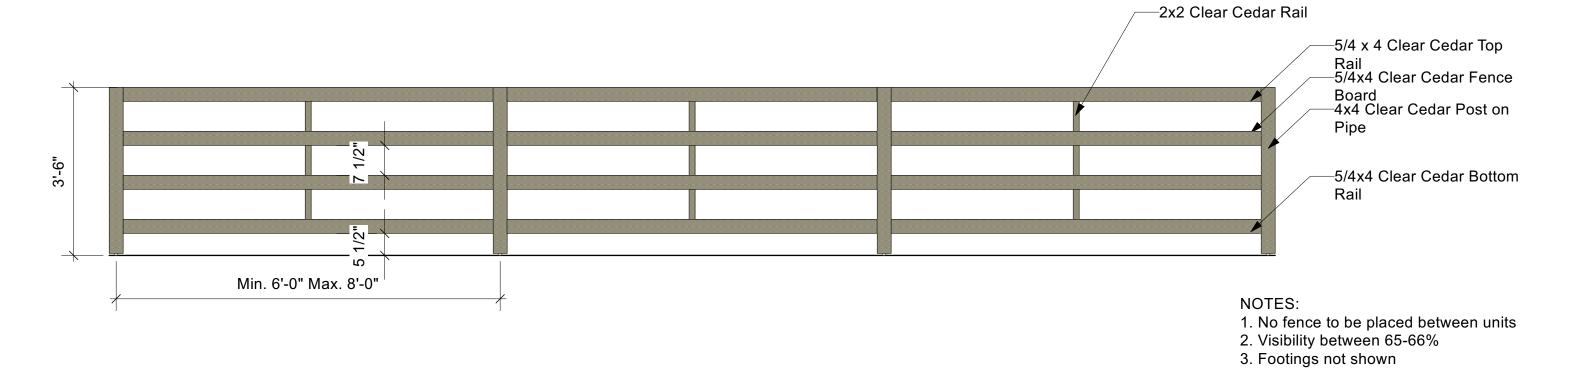




TYPE 2 FENCE - SEE SHEET L1.B FENCE AND GATE PLAN

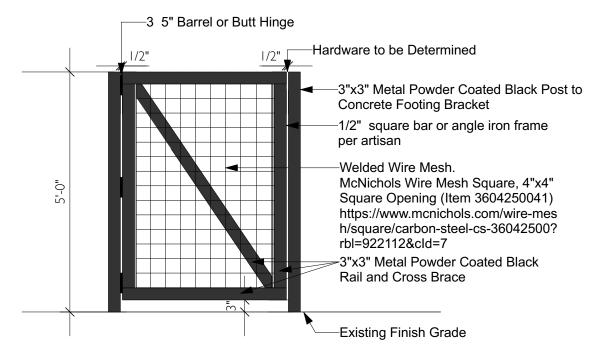



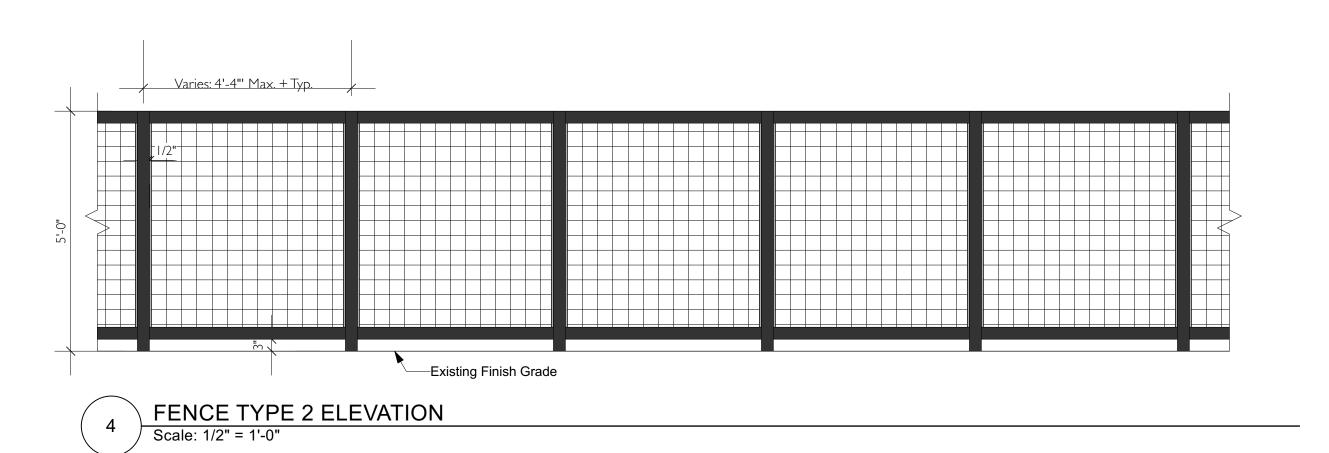


PRECEDENT IMAGES



FENCE TYPE 1 - 42" HT
CEDAR FENCE
Meridian Fence



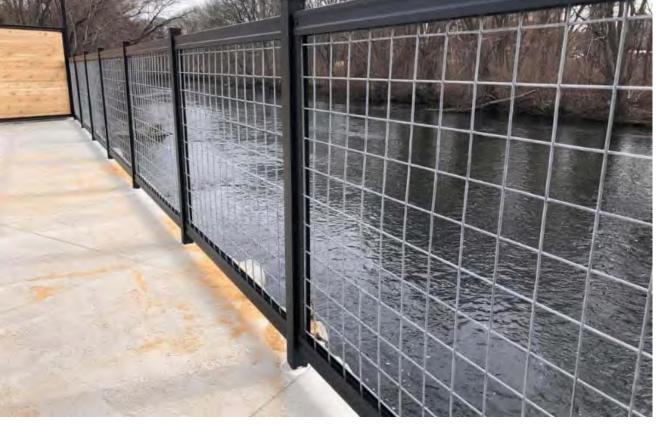

FENCE TYPE "2" 5' HT WIRE MESH FENCE
Open Space Tract Fence





ISSUE DATE: 7/29/22
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PROJECT NAME:

STREAM BELLINGHAM
TOWNHOMES
3726 Meridian Street
Rellingham Washington 98275

SHEET NAME:

FENCE ELEVATIONS + DETAILS

SCALE: 1"=40'-0"

SHEET NUMBER: