

STREAM BELLINGHAM TOWNHOMES

A row of modern, multi-story houses with white and wood paneling, black roofs, and large windows, surrounded by green trees and a white fence.

AT	ANCHOR BOLT	GA	GAUGE, GAGE	PT	PRESSURE TREATED
AB	ABOVE	GL	GALVANIZED	PTD	PAINTED
ABV	ABOVE	GC	GENERAL CONTRACTOR	PWR	POWER
AC	AIR CONDITIONING	GEN	GENERAL		
ADJ	ADJUSTABLE	GLS	GLASS	QTY	QUALITY
ANCH	ANCHOR	GM	GAS METER	QUANT	QUANTITY
APPROX	APPROXIMATE (LY)	GR	GRADE		
ARCH	ARCHITECT (URAL)	GWB	GYPSPUM WALL BOARD	R	RANGE
AUTO	AUTOMATIC			RD	ROOF DRAIN
AW	AWNING	HB	HOSE BIB	REINF	REINFORCING
		HC	HOLLOW CORE	REQ D	REQUIRED
BF	BOTTOM FLUSH	HDR	HEADER	REF	REFRIGERATOR
BLDG	BUILDING	HDW	HARDWARE	REV	REVISION
BM	BEAM	HORZ	HORIZONTAL	RF	ROOF
BOT	BOTTOM	HR	HOUR (FIRE RESISTANT RATING)	RFG	ROOFING
BRG	BEARING	HT	HEIGHT	RM	ROOM
BTWN	BETWEEN	HVAC	HEATING, VENTILATION & AC	RO	ROUGH OPENING
C	CASEMENT	IG	INSULATED GLASS	S	SINK
CB	CATCH BASIN	IN	INCH	SAF	SELF-ADHERED FLASHING
CFM	CUBIC FEET PER MINUTE	INCL	INCLUDING	SC	SOLID CORE
CJ	CEILING JOIST	INFO	INFORMATION	SCS	SCHEDULE
CLS	CEILING	INSUL	INSULATING, INSULATION	SCHED	SCHEDULE
CLR	CLEAR	INT	INTERIOR	SECT	SECTION
ONTR	CENTER	ISG	INSULATED SAFETY GLASS	SF	SAFETY FOOT
COL	COLUMN			SG	SAFETY GLAZING
CONC	CONCRETE	JT	JOINT	SH	SINGLE HUNG
CONST	CONSTRUCTION			SHM	SIMILAR
CONT	CONTINUOUS	KD	KILN DRIED	SI	SLIDING WINDOW OR DOOR
CONTR	CONTRACTOR	KP	KING POST	SPEC	SPECIFICATION
COORD	COORDINATE			SPF	SPRUCE, PINE, FIR
		LAM	LAMINATE(D)	SQ	SQUARE
D	DRYER	LAV	LAVATORY	SO FT	SQUARE FOOT
DB	DROP BEAM	LB	LAG BOLT	SS	STAINLESS STEEL
DEMO	DEMOLITION	LL	LIVE LOAD	SRS	SHELF AND ROD
DHW	DOMESTIC HOT WATER HEATER	LT	LIGHT	STD	STANDARD
DM	DIAMETER	LTG	LIGHTING	STL	STEEL
DIM	DIMENSION	LVR	LOUVER	STRUCT	STRUCTURAL
DL	DEAD LOAD	LT WT	LIGHT WEIGHT	SYM	SYMMETRICAL
DN	DOWN	LVL	LAMINATED VENEER LUMBER		
DRY	DRYER			TF	TOP FLUSH
DS	DOWNSPOUT	MAX	MAXIMUM	T&G	TONGUE AND GROOVE
DW	DISHWASHER	MECH	MECHANICAL	TEMP	TEMPERATURE
DWG	DRAWING	MED	MEDIUM	THK	THICK
		MFR	MANUFACTURER	TOC	TOP OF CONCRETE
EW	EACH WAY	MIN	MINIMUM	TOP	TOGETHER
E	EXISTING	MISC	MISCELLANEOUS	TYP	TYPICAL
EA	EACH	MTL	METAL		
EG	EGRESS	MW	MICROWAVE	UNO	UNLESS NOTED OTHERWISE
ELEC	ELECTRICAL	NEC	NECESSARY	UNON	UNLESS OTHERWISE NOTED
EM	ELECTRIC METER	NIC	NOT IN CONTRACT		
EQ	EQUAL	NTS	NOT TO SCALE	VAR	VARIABLE
EQUIP	EQUIPMENT			VENT	VENTILATION
EXH	EXHAUST	O/	OVER	VERT	VERTICAL
EXIST	EXISTING	OD	OUTSIDE DIAMETER	VF	VERTICAL GRAIN
EXT	EXTERIOR	OC	ON CENTER	WVF	VERIFY IN FIELD
		OH	OVERHEAD		
FD	FLOOR DRAIN	OPP	OPPOSITE	W	WASHER
FDN	FOUNDATION	OV	OVEN	W	WITH
FIN	FINISH			W/O	WITHOUT
FJ	FLOOR JOIST	PC	PIPE COLUMN	WASH	CLOTHES WASHER
FL	FLOOR	PLAM	PLASTIC LAMINATE	WD	WARMING DRAWER
F0	FACE OF	PLYWD	PLYWOOD	WM	WATER METER
FURR	FURRING	PSF	POUNDS PER SQUARE FOOT	WS	WIRE SHELING
FT	FOOT	PSI	POUNDS PER SQUARE INCH	WWM	WELDED WIRE MESH
FTG	FOOTING	PSL	PARALLEL STRAND LUMBER		
FURN	FURNACE	PT	POINT	#	NUMBER; POUND(S)

		DRAWING TITLE	
	NORTH ARROW		DRAWING SCALE
			VIEW TITLE
	<u>BUILDING ELEVATION</u> DRAWING NUMBER SHEET NUMBER		SITE POINT ELEVATION
	<u>FLOOR LEVEL</u> DRAWING NUMBER SHEET NUMBER		<u>FLOOR LEVEL</u> DATUM
	<u>SPOT ELEVATION</u> DRAWING NUMBER SHEET NUMBER		<u>SPOT ELEVATION</u> DATUM
	<u>REVISION TAG</u> DRAWING NUMBER SHEET NUMBER		REVISION TAG
	<u>WALL/FLOOR/ROOF ASSEMBLY TYPE TAG</u> DRAWING NUMBER SHEET NUMBER		
	<u>HOSE BIBB</u> DRAWING NUMBER SHEET NUMBER		HOSE BIBB
	<u>EXHAUST FAN AIR FLOW RATE</u> DRAWING NUMBER SHEET NUMBER		EXHAUST FAN AIR FLOW RATE
	<u>RAMP UP/DOWN PERCENT SLOPE</u> DRAWING NUMBER SHEET NUMBER		RAMP UP/DOWN PERCENT SLOPE
	<u>DECK SLOPE TO DRAIN</u> DRAWING NUMBER SHEET NUMBER		DECK SLOPE TO DRAIN
	<u>CEILING/ROOF SLOPE RISE / RUN</u> DRAWING NUMBER SHEET NUMBER		CEILING/ROOF SLOPE RISE / RUN
	<u>SMOKE DETECTOR</u> DRAWING NUMBER SHEET NUMBER		SMOKE DETECTOR
	<u>CARBON MONOXIDE ALARM</u> DRAWING NUMBER SHEET NUMBER		CARBON MONOXIDE ALARM
	<u>COMBO SMOKE/CARBON MONOXIDE DETECTOR</u> DRAWING NUMBER SHEET NUMBER		COMBO SMOKE/CARBON MONOXIDE DETECTOR
	<u>CLOTHES ROD AND SHELF</u> DRAWING NUMBER SHEET NUMBER		CLOTHES ROD AND SHELF
	<u>CUT MARK</u> DRAWING NUMBER SHEET NUMBER		CUT MARK
	<u>CENTERLINE</u> DRAWING NUMBER SHEET NUMBER		CENTERLINE
	<u>GRID LINE</u> DRAWING NUMBER SHEET NUMBER		GRID LINE

CITY OF BELLINGHAM PROJECT NO:		2021-0105
PROJECT ADDRESS:	3509 MERIDIAN STREET, BELLINGHAM, WA 98225	
PROJECT DESCRIPTION:	CONSTRUCTION OF 67 NEW TOWNHOMES, DISTRIBUTED AMONG 18 BUILDINGS, EACH BUILDING UNDER SEPARATE PERMIT	
SITE AREA:	179,793 SF	
ASSESSOR PARCEL NO:	380213 546133 000	
LEGAL DESCRIPTION:	PER CHICAGO TITLE COMPANY ORDER NO. 245444100 UPDATE #3 COMMITMENT DATE: SEPTEMBER 27, 2022 LOT 2, AS DELINEATED ON BG & CC SHORT PLAT, ACCORDING TO THE PLAT THEREOF. RECORDED UNDER AUDITOR'S FILE NO. 2022-080026, RECORDS OF WHATCOM COUNTY, WASHINGTON. SITUATE IN WHATCOM COUNTY, WASHINGTON.	
NEIGHBORHOOD:	BIRCHWOOD	
ZONING:	RESIDENTIAL MULTI - PLANNED	
APPLICABLE CODE:	INTERNATIONAL BUILDING CODE (IBC) 2018 INTERNATIONAL RESIDENTIAL CODE (IRC) 2018 WASHINGTON STATE ENERGY CODE - RESIDENTIAL PROVISIONS (WSEC-R) - 2018 BELLINGHAM MUNICIPAL CODE (BMC) INFILL TOOLKIT TOWNHOUSE REGULATIONS (BMC 20.28)	
CONSTRUCTION TYPE:	TYPE V-B	
OCCUPANCY:	RESIDENTIAL	
AUTOMATIC FIRE SPRINKLER:	NPA 13D @ TOWNHOME BUILDINGS	
ENVIRONMENTALLY CRITICAL AREAS:	NONE	

G0.00	PROJECT INFORMATION
G0.05	DRAWING INDEX
G1.01	CODE REVIEW - LAND USE
G1.02	CODE DIAGRAMS - BUILDING HEIGHT (ZONING)
G1.03	CODE DIAGRAMS - BUILDING HEIGHT (FIRE)
G1.04	CODE DIAGRAMS - OPEN, COMMON & PRIVATE SPACE
G1.05	FAR CALCULATION

C1	COVER SHEET
C1.1	EXISTING CONDITIONS - SOUTH
C1.2	EXISTING CONDITIONS - NORTH
C2.1	SITE PLAN - SOUTH
C2.2	SITE PLAN - NORTH
C2.3	NORTH FRONTAGE IMPROVEMENT
C3.1	GRADING & DRAINAGE PLAN - SOUTH
C3.2	GRADING & DRAINAGE PLAN - NORTH
C4.1	UTILITY PLAN - SOUTH
C4.2	UTILITY PLAN - NORTH
C5.1	PRELIMINARY PLAT MAP - SOUTH
C5.2	PRELIMINARY PLAT MAP - NORTH
C6.1	TREE & UTILITY PLAN - SOUTH
C6.2	TREE & UTILITY PLAN - NORTH

- L-0 TREE PRESERVATION PLAN
- L-0.8 EXISTING TREES WITH CALIPER 30" OR GREATER
- L-0.C EXISTING TREES WITH CALIPER LESS THAN 30"
- L-1.A CONCEPTUAL LANDSCAPE PLAN - PROPOSED TREES
- L-1.B CONCEPTUAL LANDSCAPE PLAN - PROPOSED TREES
- L-2 CONCEPTUAL LANDSCAPE PLAN - NORTHERN PARKING AREA + BUILDINGS 2.1, 4.1 + 4.2
- L-3 CONCEPTUAL LANDSCAPE PLAN - BUILDINGS 4.3, 4.4 + 5.1
- L-4 CONCEPTUAL LANDSCAPE PLAN - BUILDINGS 2.2, 4.5, 4.6 + 4.7
- L-5 CONCEPTUAL LANDSCAPE PLAN - CENTRAL PARKING + 2.3 + 2.4
- L-6 CONCEPTUAL LANDSCAPE PLAN - BUILDINGS 2.5 + 2.6
- L-7 CONCEPTUAL LANDSCAPE PLAN - BUILDINGS 5.2 + 5.5
- L-8 CONCEPTUAL LANDSCAPE PLAN - BUILDINGS 5.3 + 5.4
- L-9 CONCEPTUAL LANDSCAPE PLAN - SOUTHERN PARKING AREA
- L-10 CONCEPTUAL LANDSCAPE PLAN - COMMUNITY PARK
- L-11 GREEN FACTOR LANDSCAPE ELEMENTS
- L-12 FENCE ELEVATIONS + DETAILS

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|-------|-----------------------------------------------------------------------|
| A1.01 | DEMOLITION SITE PLAN |
| A1.11 | SITE PLAN |
| A1.21 | ENLARGED SITE PLAN - NORTH |
| A1.22 | ENLARGED SITE PLAN - SOUTH |
| A1.51 | CONSOLIDATED GARBAGE/RECYCLING ENCLOSURE #1 |
| A1.52 | CONSOLIDATED GARBAGE/RECYCLING ENCLOSURE #2 |
| A1.53 | CONSOLIDATED GARBAGE/RECYCLING ENCLOSURE #3 |
| A2.10 | FLOOR PLANS - FON & FIRST FLOOR - 2-PACK TH 'C'-C' UNITS |
| A2.11 | FLOOR PLANS - SECOND FLOOR & ROOF - 2-PACK TH 'C'-C' UNITS |
| A2.20 | FLOOR PLANS - FON & FIRST FLOOR - 2-PACK TH 'A'-B' UNITS |
| A2.21 | FLOOR PLANS - SECOND FLOOR & ROOF - 2-PACK TH 'A'-B' UNITS |
| A2.30 | FLOOR PLANS - FON & FIRST FLOOR - 4-PACK TH 'A'-B-A-B' UNITS |
| A2.31 | FLOOR PLANS - SECOND, THIRD FLOOR & ROOF - 4-PACK TH 'A'-B-A-B' UNITS |
| A2.40 | FLOOR PLANS - FON & FIRST FLR - 5-PACK TH 'A'-B-A-B-A' UNITS |
| A2.41 | FLOOR PLANS - SECOND, THIRD FLR & ROOF - 5-PACK TH 'A'-B-A-B-A' UNITS |
| A3.00 | BUILDING ELEVATIONS - MATERIALS |
| A3.10 | BUILDING ELEVATIONS - 2-PACK TH 'C'-C' UNITS |
| A3.20 | BUILDING ELEVATIONS - 2-PACK TH 'A'-B' UNITS |
| A3.30 | BUILDING ELEVATIONS - 4-PACK TH 'A'-B-A-B' UNITS |
| A3.40 | BUILDING ELEVATIONS - 5-PACK TH 'A'-B-A-B-A' UNITS |
| A4.11 | BUILDING SECTIONS - 2-PACK TH 'C'-C' UNITS |
| A4.12 | BUILDING SECTIONS - 2-PACK TH 'A'-B' UNITS |
| A4.13 | BUILDING SECTIONS - 4-PACK TH 'A'-B-A-B' UNITS |
| A4.14 | BUILDING SECTIONS - 5-PACK TH 'A'-B-A-B-A' UNITS |
| A5.11 | UNIT PLANS - TYPE A1 & A2 (A1.M OPP) |
| A5.12 | UNIT PLANS - TYPE B1 & B2 (B1.M OPP) |
| A5.13 | UNIT PLANS - TYPE C1 (C1.M OPP) |

1. DO NOT SCALE THE DRAWINGS. LARGE SCALE DIMENSIONS GOVERN SMALL SCALE DIMENSIONS.
2. GENERAL CONTRACTOR SHALL NOTIFY ARCHITECT OF ANY DISCREPANCY IN DIMENSIONS, PRIOR TO PROCEEDING WITH WORK.
3. AT NEW CONSTRUCTION, ALL DIMENSIONS ARE TO FACE OF FRAMING, FACE OF CONCRETE, CENTER LINE OF COLUMNS
4. AND CENTERLINE OF WINDOWS AND DOORS, UNLESS NOTED OTHERWISE.
5. PLAT DIMENSIONS UNACCOMPANIED BY A LICENSED SURVEY IN THE POST DRAWING SET ARE CONSIDERED
6. APPROVED AND FOR RECORD.
7. GRAPHIC DIMENSIONS ARE PROVIDED FOR REFERENCE ONLY. (WHERE DRAWINGS OF DIFFERENT SCALES ARE PROVIDED ON
8. THE SAME SHEET, GRAPHIC SCALES ARE REMOVED FOR CLARITY.)
9. DIMENSIONS WITH ACCOMPANYING TEXT (E.G. "HOLD EQUAL") SHALL BE VERIFIED IN FIELD. ANY CHANGES TO
10. THESE DIMENSIONS REQUIRE APPROVAL BY ARCHITECT.

**STREAM
BELLINGHAM
TOWNHOMES
3509 MERIDIAN ST**

DEPARTURE REQUEST MATRIX

BMC CODE CITATION	CODE REQUIREMENT	PROPOSED DEPARTURE	DESIGN RATIONALE
DEPARTURE REQUEST #1 20.28.140.C.3: BULK AND MASSING	THE HEIGHT LIMIT IS 35' UNDER BMC 20.08.020, DEFINITION NO. 1.	DEPARTURE REQUEST: • 6 1/2" TO 2'-4 1/2" ABOVE 35' HEIGHT LIMIT *THIS ASSUMES MIDDLE OF THE RIDGE AS THE 35' LIMIT SEE SHEET G1.02 FOR DIAGRAM	THIS SITE IS ZONED RESIDENTIAL MULTI-PLANNED AND HAS NO HEIGHT LIMIT. THE TOWNHOUSE FINISH FLOOR HEIGHT TO ROOF RIDGELINE IS CONSISTENTLY 38'. THE EXISTING GRADES OF THE EXISTING TREE-FILLED AREA SLOPES BELOW MERIDIAN AND BIRCHWOOD. SOME OF THE BUILDINGS ARE SITUATED HIGHER THAN EXISTING GRADE IN AN EFFORT TO CREATE FUNCTIONAL AND ACCESSIBLE BUILDINGS AND TO PROVIDE A CONSISTENT MASSING ACROSS THE SITE. THE TWO BUILDINGS EXCEEDING 35' PER DEFINITION NO 1 CALCULATION ARE: • BLDG 5.2 @ 39'-6 1/2" AND • BLDG 5.3 @ 37'-4 1/2".
DEPARTURE REQUEST #2 20.28.050.A PEDESTRIAN-ORIENTED DESIGN	FRONTING INFILL HOUSING UNITS ON EXISTING IMPROVED STREETS SHALL BE PRIORITIZED OVER FRONTING UNITS INTERNALLY OFF A NEW STREET.	DEPARTURE REQUEST: • ALLOW UNIT 8.2 IN BUILDING 2.5 TO FRONT COMMON AMENITY SEE SHEET A1.11 FOR LOCATION	THE MAJORITY OF THE UNITS ALONG MERIDIAN PROVIDE UNIT ENTRIES THAT FRONT MERIDIAN. UNIT 8.2, IN BUILDING 2.5, IS THE ONLY UNIT ALONG MERIDIAN THAT HAS THE UNIT ENTRY ROTATED TO FACE NORTH, INSTEAD OF EAST. ROTATING THIS UNIT ENTRY ALLOWS THE UNIT TO FOLLOW A SIMILAR CONTEXTUAL PATTERN OF FRONTING THE GREEN SPACE, INSTEAD OF THE MAJOR ARTERIAL. THE SITING OF THIS BUILDING ALLOWS THE CENTRAL TRASH ENCLOSURE TO BE DISCRETELY TUCKED AMONG OTHER GARAGES, RATHER THAN FLANKING THE COMMON GREEN SPACE. UNIT A.1 HAS TWO ENTRIES, ONE FRONTING MERIDIAN AND ONE FRONTING THE GREEN SPACE.
DEPARTURE REQUEST #3 20.28.140.B.2: SITE REQUIREMENTS AND SETBACKS	BUILDINGS SHALL BE PLACED: • WITHIN 20' MAXIMUM FROM PROPERTY LINE AT FRONT AND SIDE FLANKING STREETS • 10' CLEAR FROM PROPERTY LINE AT REAR YARD WHEN NO ALLEY IS PRESENT (OPPOSITE FRONT STREET).	DEPARTURE REQUESTS: • ALLOW SETBACKS RANGE FROM 48'-4" (BUILDING 4.7) TO 80'-2" (BUILDING 4.6) FROM PROPERTY LINE. • ALLOW BLDG 2.3 TO OVERLAP THE 10' SETBACK AT REAR YARD. SEE SHEET G1.04 FOR DIAGRAM	BUILDINGS 4.6 & 4.7 FRONT ALONG MERIDIAN, HOWEVER, THE OPEN SPACE WAS STRATEGICALLY LOCATED IN AN EFFORT TO CREATE A SUBTLE BUFFER BETWEEN THE ARTERIAL AND THE UNITS ON THE EAST. SINCE THE UNITS ON THE WESTERN EDGE ALL FRONT THE GOLF COURSE. LOCATING THE GREEN SPACE ON THE EASTERN EDGE MORE EVENLY DISTRIBUTES THE GREEN SPACE THROUGHOUT THE PROJECT. CITY HAS NOTED THAT MERIDIAN ST IS CONSIDERED THE FRONT YARD AND THEREFORE REQUIRES A 10' REAR YARD SETBACK OPPOSITE THE FRONT YARD. BLDG 2.3 EXTENDS PAST THE 10' SETBACK OPPOSITE MERIDIAN (50 SF AREA) AND ASSUMING THE JDG IN REAR PROPERTY LINE WILL ALSO BE CONSIDERED A 10' SETBACK, BLDG 2.3 EXTENDS OVER THIS SETBACK PARTIALLY FROM 1'-11" TO 4'-11".
DEPARTURE REQUEST #4 20.28.050.G PRIVATE LANES, COMMON PEDESTRIAN CORRIDORS, AND ALLEYS	• PEDESTRIAN PATHS SHALL BE SEPARATED BY A MINIMUM OF 2' FROM PROPERTY LINES, FENCES, WALLS AND HEDGES. • TOWNHOUSES ARE REQUIRED TO BE SETBACK A MINIMUM OF 10' FROM THE COMMON PEDESTRIAN CORRIDORS (COMMON PEDESTRIAN CORRIDORS SHALL BE CONSIDERED STREETS FOR SETBACK PURPOSES). • COMMON PEDESTRIAN CORRIDOR MINIMUM TOTAL WIDTH REQUIRED TO BE 10'.	DEPARTURE REQUESTS: • ALLOW PEDESTRIAN PATHS TO BE SITED AT PROPERTY LINE IN FRONT OF BLDGS 2.3, 2.4, 5.2 AND 5.3, AND ADJACENT TO FENCES ALONG ENTIRE WEST EDGE OF THE BUILT SITE. • A MINOR MODIFICATION FROM BMC 20.28.050.G IS REQUESTED AS TOWNHOUSES ARE REQUIRED TO BE SETBACK A MINIMUM OF 10' FROM THE COMMON PEDESTRIAN CORRIDORS. • A MINOR MODIFICATION FROM BMC 20.28.050.G.3 AS TABLE 20.28.050 REQUIRES A TOTAL WIDTH OF 10' TO BE PROVIDED FOR COMMON PEDESTRIAN CORRIDORS. SEE SHEETS G1.04 AND A1.11	LOCATING THE PEDESTRIAN PATH ALONG THE FENCE AND PROPERTY LINE AT THE WEST EDGE INSTEAD OF PROVIDING THE REQUIRED 2 FEET SEPARATION MAXIMIZES THE OPEN SPACE AREA BETWEEN THE PROPERTY AND THE GOLF FAIRWAY ON THE ADJACENT BELLINGHAM GOLF CLUB PROPERTY AND ALLOWS FOR PRIVATE YARD SPACE AT UNITS FACING THE WEST EDGE.
DEPARTURE REQUEST #5 20.28.050.I.4 LANDSCAPING AND FENCING	• ALL FENCES IN THE FRONT AND SIDE STREET SETBACKS ARE LIMITED TO 42" IN HEIGHT.	DEPARTURE REQUEST: • ALLOW FENCE SEPARATING THE THE TOWNHOUSE PROJECT FROM THE BELLINGHAM COUNTRY CLUB PROPERTY TO BE 60" IN HEIGHT SEE SHEET A1.11 FOR LOCATION	A 60" HIGH FENCE IS THE PREFERENCE OF THE SITE'S NEIGHBORS, THE BELLINGHAM COUNTRY CLUB AND COMPLIANT WITH A REAR YARD SETBACK (PER COB; SEE DEPARTURE REQUEST #3)

BELLINGHAM CODE REVIEW

ZONE	RESIDENTIAL MULTI- PLANNED	20.28.140.D USABLE SPACE, OPEN SPACE AND LANDSCAPING	<ul style="list-style-type: none">EACH DWELLING UNIT SHALL HAVE:<ul style="list-style-type: none">200 SF OF PRIVATE USABLE SPACE WITH NO DIMENSION LESS THAN 5'.UP TO 100 SF OF DECK, PATIO OR STRUCTURE MAY BE INCLUDED TOWARDS 200 SF REQUIREMENT.PRIVATE USABLE SPACE MAY BE CONSOLIDATED AND PROVIDED AS COMMON USABLE SPACE WITH MINIMUM DIMENSIONS OF 10' BY 10'.ALL UNITS SHALL HAVE DIRECT ACCESS TO USABLE SPACE. <p>REQUIRED PRIVATE USABLE SPACE: 67 UNITS X 200 SF = 13,400 SF</p> <p>PROPOSED PRIVATE USABLE SPACE: PRIVATE USABLE SPACE = VARIES (SEE SHEET G1.03 FOR DIAGRAM) COMMON USABLE SPACE = 3,862 SF SEE SHEET G1.04 FOR PRIVATE USABLE SPACE CALCULATIONS.</p> <ul style="list-style-type: none">A MINIMUM OF 30% OF THE SITE AREA SHALL BE IN OPEN SPACE CONSISTING OF LANDSCAPING OR PERMEABLE MATERIALS. <p>REQUIRED SITE OPEN SPACE: 179,793 X .3 = 53,938 SF PROPOSED SITE OPEN SPACE: 67,396 SF SEE SHEET G1.04 FOR OPEN SPACE CALCULATIONS</p> <ul style="list-style-type: none">A GREEN FACTOR LANDSCAPING SCORE OF 0.4 IS REQUIRED <p>PROPOSED: 0.5324 SEE SHEET L-11 FOR GREEN FACTOR CALCULATIONS</p>
LOT AREA	179,793 SF		
20.28.050.A PEDESTRIAN-ORIENTED DESIGN	<ul style="list-style-type: none">FRONTING INFILL HOUSING UNITS ON EXISTING IMPROVED STREETS SHALL BE PRIORITIZED OVER FRONTING UNITS INTERNALLY OFF A NEW STREET. GAPS MAY OCCUR AS NECESSARY FOR BUILDING SETBACKS, VEHICULAR AND PEDESTRIAN ACCESS, AND FEATURES THAT CONTRIBUTE TO THE PEDESTRIAN REALM.PARKING SHALL NOT BE LOCATED BETWEEN DWELLING UNITS AND THE STREET OR LANE. <p>DEPARTURE REQUESTED - SEE DEPARTURE REQUEST #2 ON DEPARTURE REQUEST MATRIX</p>		
20.28.050.C LOT REQUIREMENTS	<ul style="list-style-type: none">THERE ARE NO MINIMUM LOT DIMENSIONS, LOT SIZES OR MINIMUM STREET FRONTAGE REQUIREMENTS.ALL INFILL HOUSING DEVELOPMENT SHALL PROVIDE ACCESS TO A PUBLIC RIGHT-OF-WAY.		
20.28.050.D SUBDIVISION	<ul style="list-style-type: none">SITES WITH DUPLEX AND TOWNHOUSE TYPES MAY BE SUBDIVIDED INTO LOTS THAT DO NOT COMPLY WITH DEVELOPMENT STANDARDS IN THIS TITLE OR BMC TITLE 23 INDIVIDUALLY, AS LONG AS THE PARENT SITE AS A WHOLE COMPLIES WITH THIS CHAPTER.		
20.28.050.F ENCROACHMENTS AND COMMON WALL DEVELOPMENT	<ul style="list-style-type: none">ENCROACHMENTS INTO REQUIRED YARDS ARE ALLOWED AS SPECIFIED IN BMC 20.10.080(B).FENCES AND WALLS<ul style="list-style-type: none">UNCOVERED DECK OR BALCONY, EXCEEDING 30" ABOVE GRADE:<ul style="list-style-type: none">FRONT YARD SETBACK = 6' PERMITTED ENCROACHMENTREAR YARD SETBACK = 5' PERMITTED ENCROACHMENTMECHANICAL EQUIPMENT, SUCH AS: AIR CONDITION UNIT, HEAT PUMP UNITREAR YARD SETBACK = 4' PERMITTED ENCROACHMENTCOVERED PORCH, SINGLE STORY MAIN ENTRY OPEN ON 3 SIDES (UNCOVERED STEPS LEADING INTO A PORCH OR DECK WHICH ARE NOT EXCEEDING 4 ABOVE GRADE ARE NOT COUNTED TOWARDS THE 6' FRONT YARD ENCROACHMENT)<ul style="list-style-type: none">FRONT YARD SETBACK = 6' PERMITTED ENCROACHMENTFOR COMMON WALL DEVELOPMENT SUCH AS TOWNHOUSES AND ENCROACHMENTS OVER PROPERTY LINES SUCH AS EAVES, A JOINT AGREEMENT MUST BE APPROVED BY THE CITY OF BELLINGHAM AND RECORDED WITH THE WHATCOM COUNTY AUDITOR'S OFFICE AND THEREAFTER FILED WITH THE CITY.		
20.28.050.G PRIVATE LANES, COMMON PEDESTRIAN CORRIDORS, AND ALLEYS	<ul style="list-style-type: none">LANES, COMMON PEDESTRIAN CORRIDORS, AND ALLEYS MUST BE CONSTRUCTED AND MAINTAINED TO THE FOLLOWING MINIMUM IMPROVEMENT STANDARDS:<ul style="list-style-type: none">ALLEYS: TRAVEL LANE WIDTH = 15' PEDESTRIAN PATH WIDTH = N/A TOTAL WIDTH = 15'PROPOSED TOTAL WIDTH = 20'LANES, COMMON PEDESTRIAN CORRIDORS, AND ALLEYS MUST BE:<ul style="list-style-type: none">SURFACED WITH A HARD MATERIAL SUCH AS CONCRETE OR ASPHALT, EXCEPT THAT ASPHALT SHALL NOT BE USED FOR COMMON PEDESTRIAN CORRIDORS. PERMEABLE PAVEMENT SHALL BE USED FOR HARD SURFACE GROUND COVER AREAS UNLESS INFEASIBLE.PEDESTRIAN PATHS SHALL BE SEPARATED FROM PROPERTY LINES, FENCES, WALLS AND HEDGES BY A MINIMUM OF 2' <p>DEPARTURE REQUESTED - SEE DEPARTURE REQUEST #4 ON DEPARTURE REQUEST MATRIX</p>		
20.28.050.H PARKING	<ul style="list-style-type: none">NUMBER OF SPACES<ul style="list-style-type: none">UNITS OF 1,000 SQUARE FEET OR GREATER SHALL PROVIDE TWO ON-SITE PARKING STALLS.PROPOSED DWELLING UNIT PARKING: 2 GARAGE STALLS (880 UNITS > 1,000 SF)GUEST PARKING, WHEN A SITE CONTAINS 20 OR MORE UNITS AND LACKS ON-STREET PARKING ABUTTING OR PARKING WITHIN THE PARENT SITE, THE PLANNING DIRECTOR MAY REQUIRE ADDITIONAL GUEST PARKING.<ul style="list-style-type: none">PROPOSED GUEST PARKING ON SITE: 21 SURFACE PARKING STALLSPARKING STALL DIMENSIONS<ul style="list-style-type: none">UNIT GARAGE PARKING STALLS SHALL BE AT LEAST 9' BY 18'.PARKING SETBACKS<ul style="list-style-type: none">THE REQUIRED MINIMUM SETBACKS FOR OPEN PARKING ARE:<ul style="list-style-type: none">FRONT STREET: 25'SIDE FLANKING STREET: 10'SIDE AND REAR YARDS: 5'		
20.28.050.I LANDSCAPING AND FENCING	<ul style="list-style-type: none">LANDSCAPING SHALL BE PROVIDED BETWEEN EACH HOUSING UNIT AND ABUTTING STREETS, LANES, ALLEYS, AND COMMON PEDESTRIAN CORRIDORS EXCEPT WHERE DRIVEWAY AND WALKWAY CROSSINGS OCCUR.ALONG STREETS, LANES AND ALLEYS, LANDSCAPING SHALL BE PROVIDED TO SEPARATE THE PARKING AND DRIVEWAYS BETWEEN INDIVIDUAL DWELLING UNITS.ALL FENCES IN THE FRONT AND SIDE STREET SETBACKS ARE LIMITED TO 42" IN HEIGHT AND MAY BE NO MORE THAN 60% OPAQUE. CHAIN LINK OR CYCLONE FENCING IS NOT ALLOWED IN THE FRONT OR SIDE STREET SETBACK.		
20.28.140.B TOWNHOUSE - SITE REQUIREMENTS AND SETBACKS	<ul style="list-style-type: none">TOWNHOUSES MAY BE LOCATED ON A SEPARATE (FEE SIMPLE) LOT OR SEVERAL UNITS MAY BE LOCATED ON A COMMON PARCEL.THE REQUIRED SETBACKS ARE:<ul style="list-style-type: none">GARAGES AND CARPORTS SHALL BE SET BACK AT LEAST 4' FROM THE STREET FACE OF RESIDENTIAL BUILDINGS (EXCLUDING FRONT PORCHES).BUILDINGS SHALL BE PLACED:<ol style="list-style-type: none">10' CLEAR FROM PROPERTY LINE AT FRONT AND SIDE FLANKING STREETS.WITHIN 20' MAXIMUM FROM PROPERTY LINE AT FRONT AND SIDE FLANKING STREETS.5' CLEAR FROM PROPERTY LINE AT ADJACENT PARCELS. <p>DEPARTURE REQUESTED - SEE DEPARTURE REQUEST #3 ON DEPARTURE REQUEST MATRIX</p>		
20.28.140.C BULK AND MASSING	<ul style="list-style-type: none">MAXIMUM ATTACHED DWELLING UNITS IS 8. PROPOSED MAXIMUM ATTACHED DWELLING UNITS: 5.MAXIMUM FLOOR AREA RATIO (FAR) IS 0.75. PROPOSED FAR: 0.71 SEE SHEET G1.03 FOR FAR DIAGRAMS & CALCULATIONSMAXIMUM HEIGHT LIMIT IS 35' (PER DEFINITION NO 1). PROPOSED MAXIMUM STRUCTURE HEIGHT: 39'-11" (VARIES PER BUILDING) SEE SHEET G1.02 FOR HEIGHT DIAGRAMS & CALCULATIONS <p>DEPARTURE REQUESTED - SEE DEPARTURE REQUEST #1 ON DEPARTURE REQUEST MATRIX</p>		
20.32.040.B STANDARD DEVELOPMENT - REGULATIONS - DENSITY		<p>MAXIMUM DENSITY: (HIGH DENSITY CLASSIFICATION) NO EXPRESSED MAXIMUM DENSITY WITHIN A HIGH-DENSITY CLASSIFICATION</p> <p>MINIMUM DENSITY: (HIGH DENSITY CLASSIFICATION) 3,599 SF OF GROSS LAND AREA/1 RESIDENTIAL UNIT 179,793 SF GROSS LAND AREA/3,559 SF = 50 UNIT MINIMUM REQUIRED</p> <p>67 UNITS PROPOSED</p>	
20.32.040.C4. PEDESTRIAN CIRCULATION	<p>SIDEWALK</p> <ul style="list-style-type: none">SHALL BE CONSTRUCTED WITHIN ALL ABUTTING ROW. (A LOCAL IMPROVEMENT DISTRICT COMMITMENT MAY BE REQUIRED IN LIEU OF CONSTRUCTION IF THE CITY DETERMINES IMMEDIATE CONSTRUCTION IS NOT WARRANTED.) <p>WALKWAYS</p> <ul style="list-style-type: none">REQUIRED LINKING BUILDING ENTRANCES TO PARKING AREAS, SIDEWALKS AND OTHER BUILDING ENTRANCES.IF NO SIDEWALK IS CONSTRUCTED OR EXISTS, THE CONNECTING WALKWAY SHALL EXTEND TO THE PROPOSED LOCATION OF A SIDEWALK OR TO THE EDGE OF THE PAVEMENT.		
20.32.070.B LANDSCAPING REQUIREMENTS (SEE SHEETS L-1 - L-11 FOR LANDSCAPE DESIGN)	<p>STREET TREES</p> <ul style="list-style-type: none">ONE STREET TREE SHALL BE PROVIDED FOR EVERY 50 FEET OF STREET FRONTAGE ABUTTING THE PROPERTY. SAID TREES SHALL BE INSTALLED ADJACENT TO THE RIGHT-OF-WAY WITHIN THE PROPERTY LINES OR WITHIN THE RIGHT-OF-WAY SUBJECT TO THE APPROVAL OF THE PUBLIC WORKS AND PARKS DEPARTMENT. <p>GARBAGE RECEPTACLE AREAS</p> <ul style="list-style-type: none">SHALL BE SCREENED ON AT LEAST TWO SIDES. <p>OPEN SPACE</p> <ul style="list-style-type: none">A MINIMUM OF 25% OF THE REQUIRED OPEN SPACE SHALL BE LANDSCAPED. (LANDSCAPE-BASED LID BMP'S SHALL COUNT TOWARD THIS REQUIREMENT.) <p>PARKING</p> <ul style="list-style-type: none">FOR EVERY 10 OPEN PARKING SPACES, ONE TREE SHALL BE INSTALLED AROUND THE FACILITY PERIMETER. THESE TREES MAY BE GROUPED OR SPREAD LINEALLY.AREAS BETWEEN PARKING AND ADJACENT PROPERTY SHALL BE LANDSCAPED AND/OR SCREENED.WHEN ADJACENT TO LANDSCAPING, A PORTION OF A STANDARD PARKING SPACE MAY BE LANDSCAPED INSTEAD OF PAVED, AS FOLLOWS:<ol style="list-style-type: none">THE LANDSCAPED AREA MAY BE UP TO TWO FEET OF THE FRONT OF THE SPACE . ANY VEHICLE OVERHANG MUST BE FREE FROM INTERFERENCE FROM SIDEWALKS, LANDSCAPING, OR OTHER REQUIRED ELEMENTS.LANDSCAPING WITHIN THE PARKING OVERHANG AREA MUST BE GROUND COVER PLANTS.THE LANDSCAPED AREA COUNTS TOWARD PARKING LOT LANDSCAPING REQUIREMENTS AND TOWARD ANY OVERALL OPEN SPACE REQUIREMENTS.UNLESS INFEASIBLE, LANDSCAPE-BASED LID BMP'S SHALL BE USED WITHIN PARKING LOT LANDSCAPING TO MEET DRAINAGE REQUIREMENTS.		

STREAM BELLINGHAM - SITE

REVISION	DATE	DESCRIPTION
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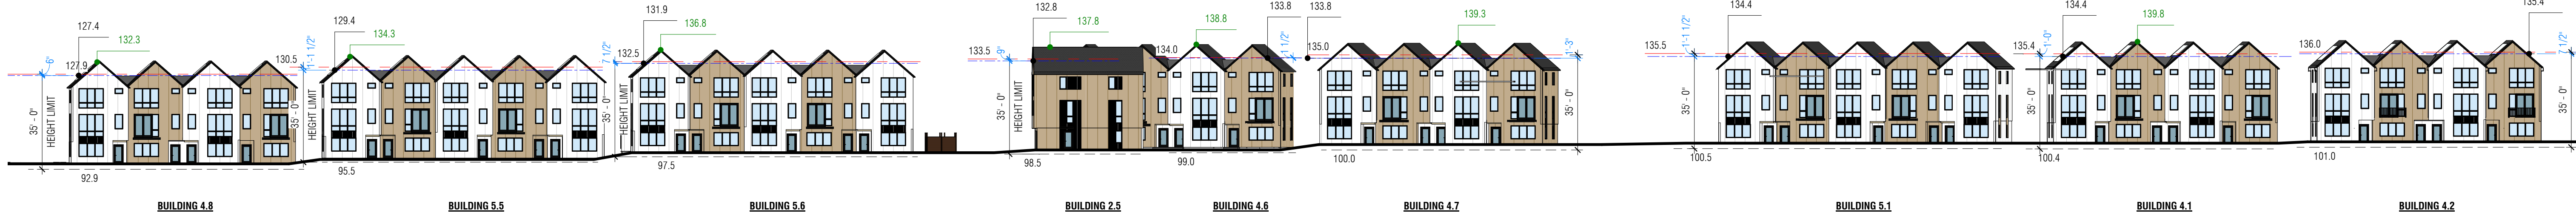
ISSUANCES	
DATE	DESCRIPTION
7/29/2022	LAND USE APPLICATION
1/13/2023	LAND USE APP RESUBMITTAL
4/14/2023	LAND USE APP RESUBMITTAL

GENERAL NOTES


HEIGHT CALCULATED PER CITY OF BELLINGHAM BUILDING HEIGHT DEFINITION NO. 1:
THE VERTICAL DISTANCE FROM THE LOWEST EXISTING GRADE AT THE WALL OF THE
BUILDING TO THE HIGHEST POINT OF THE COPING OF A FLAT ROOF OR TO THE AVERAGE
HEIGHT OF THE HIGHEST GABLE OF A PITCH OR HIP ROOF.

LEGEND

- 35' HEIGHT LIMIT
- AVERAGE HEIGHT OF ROOF
- LOWEST EXISTING GRADE
- DIMENSION BELOW 35' HEIGHT LIMIT
- DIMENSION ABOVE 35' HEIGHT LIMIT
- AVERAGE HEIGHT POINT OF GABLE / SHED
- RIDGE ELEVATION
- LOWEST EXISTING GRADE AT BUILDING EXTERIOR WALL
- LEVEL 1 FINISH FLOOR ELEVATION AT ENTRY



EAST SITE ELEVATION - HEIGHT DIAGRAM
1" = 30'-0"

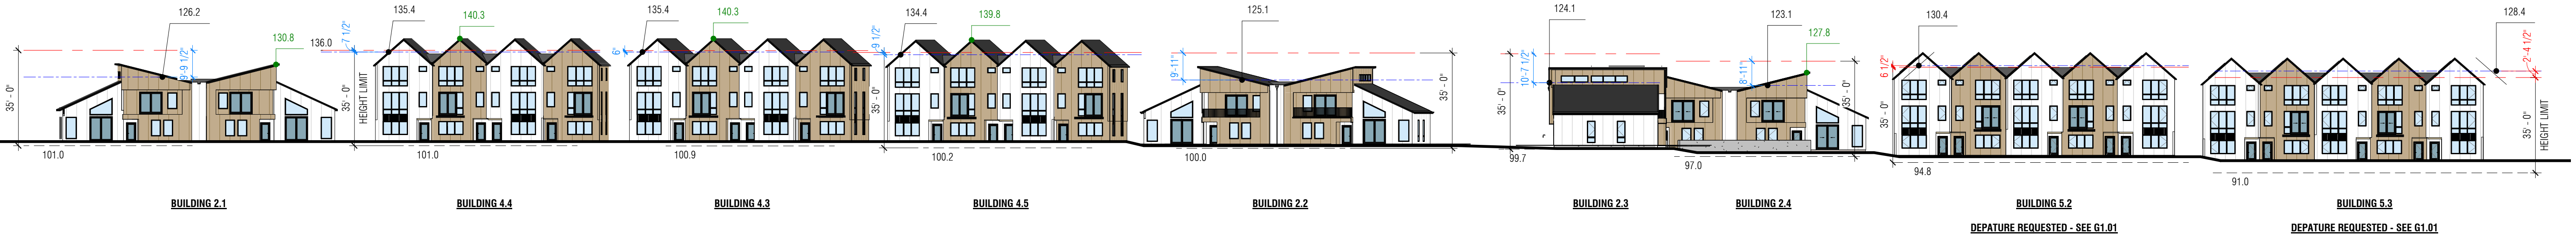

WEST SITE ELEVATION - HEIGHT DIAGRAM
1" = 30'-0"

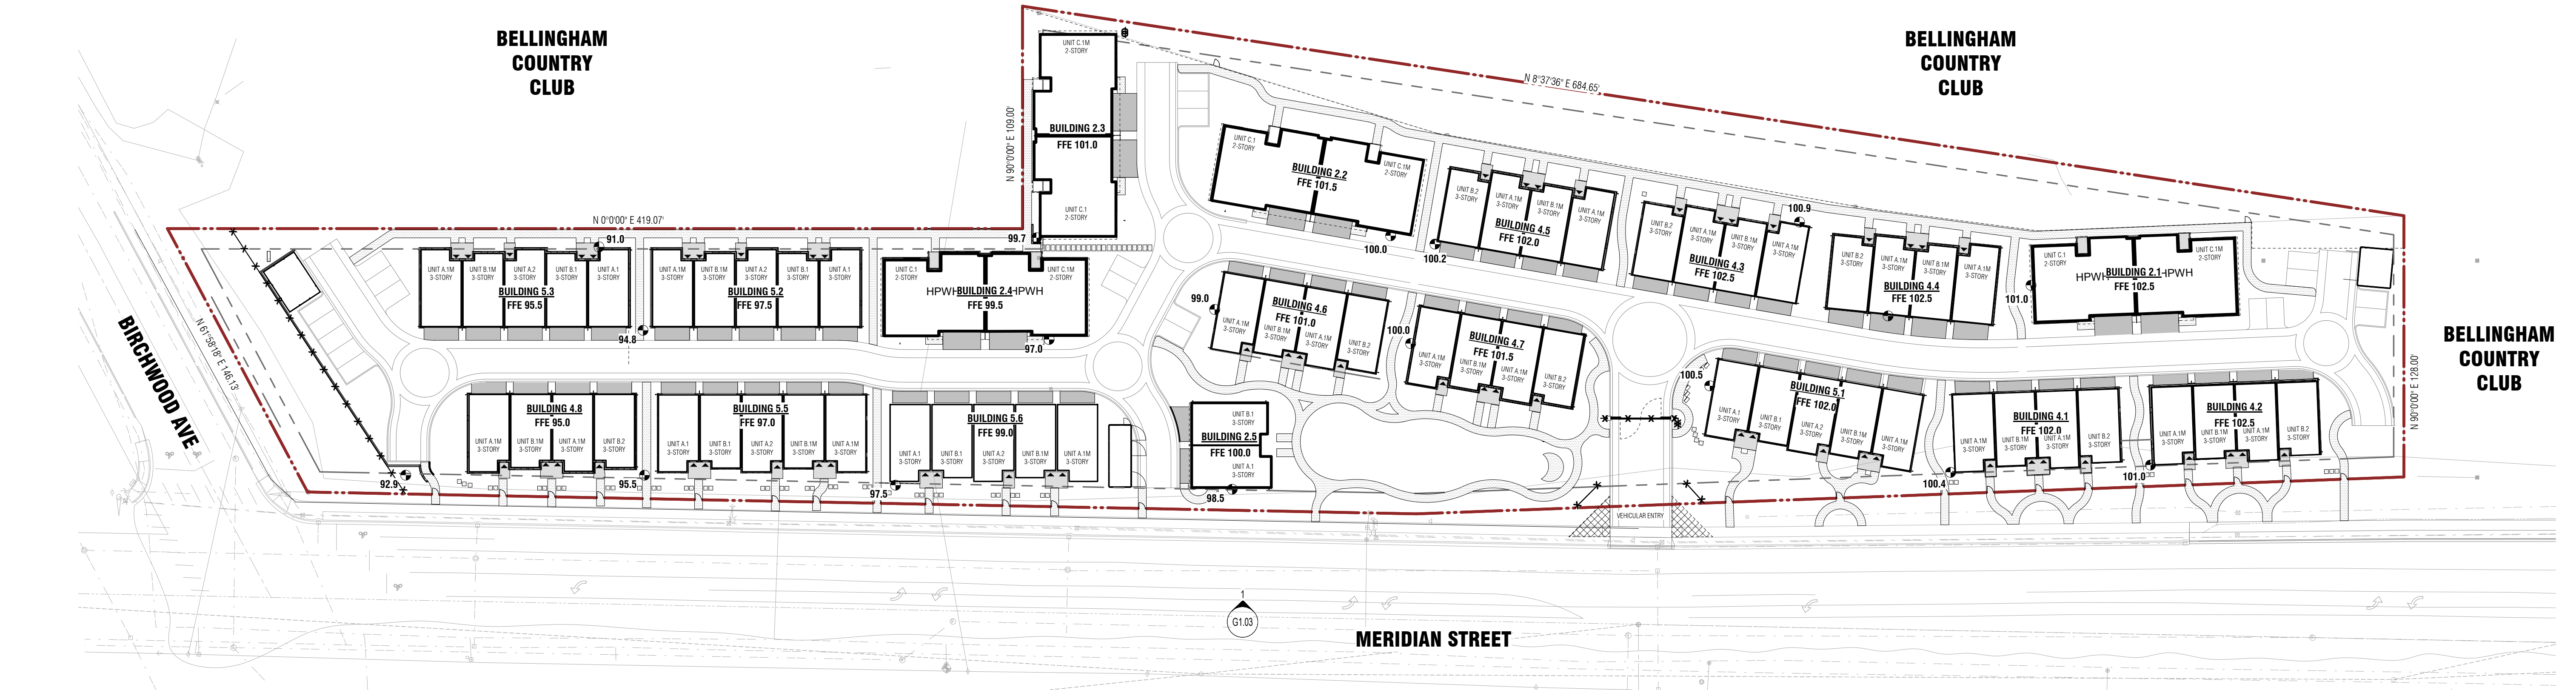


DIAGRAM - LOCATION OF LOWEST EXISTING GRADE PER BUILDING
1" = 40'-0"

REVISION	DATE	DESCRIPTION
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ISSUANCES	DATE	DESCRIPTION
	7/29/2022	LAND USE APPLICATION
	1/13/2023	LAND USE APP RESUBMITTAL
	4/14/2023	LAND USE APP RESUBMITTAL

COPYRIGHT BOARD AND VELLUM LLC. ALL RIGHTS RESERVED.
ORIGINAL SHEET SIZE IS 22"x34"

BOARD & VELLUM PROJECT #: 2021170.00
COB PROJECT #: 2021-0105

PLOT DATE: 4.12.2023

CODE DIAGRAMS -
BUILDING HEIGHT (ZONING)

SHEET NO.:

GENERAL NOTES

- 1. THE PROPOSED BUILDINGS ARE WITHIN 30 FEET IN HEIGHT ABOVE THE LOWEST LEVEL OF FIRE DEPARTMENT VEHICLE ACCESS.
- 2. PER SECTION 503.1.4, THE HIGHEST ROOF SURFACE SHALL BE DETERMINED BY MEASUREMENT TO THE EAVE OR A PITCHED ROOF, THE INTERSECTION OF THE ROOF TO THE EXTERIOR WALL, OR THE TOP OF PARAPET WALLS, WHICHEVER IS GREATER.


LEGEND

- HIGHEST ROOF MEASURE AT EAVE OR INTERSECTION OF ROOF AND EXTERIOR WALL (WHICHEVER IS GREATER)
- LOWEST FIRE APPARATUS ACCESS ELEVATION
- HIGHEST ROOF MEASURE AT EAVE OR INTERSECTION OF ROOF AND EXTERIOR WALL (WHICHEVER IS GREATER)
- LOWEST FIRE APPARATUS ACCESS ELEVATION
- BELOW 30' HEIGHT LIMIT PER BELLINGHAM IFC 503.1.4

1 EAST SITE ELEVATION - HEIGHT DIAGRAM FOR IFC
1" = 30'-0"



2 WEST SITE ELEVATION - HEIGHT DIAGRAM FOR IFC
1" = 30'-0"

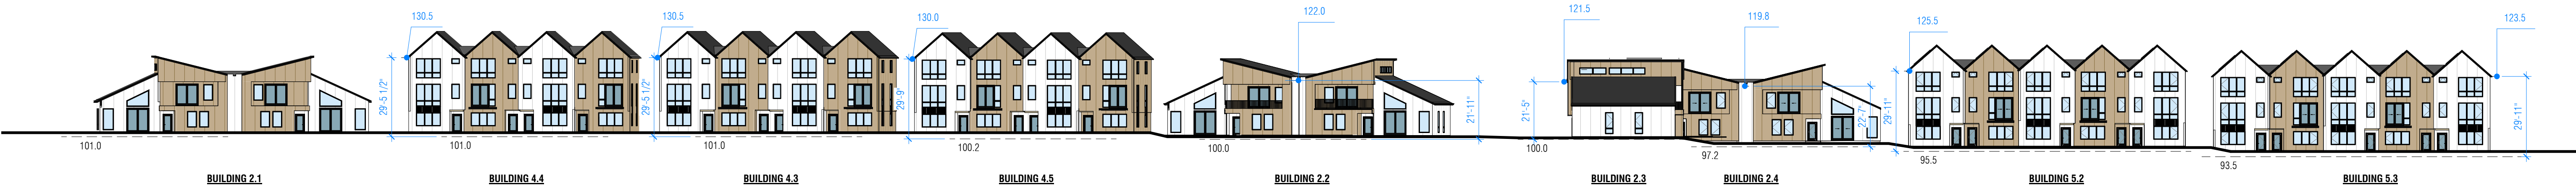

3 DIAGRAM - LOCATION OF LOWEST FIRE APPARATUS ACCESS PER BUILDING
1" = 40'-0"





3 BLDG 2.3 SETBACK (DEPATUURE REQUEST #4)

1/8" = 1'-0"


2 MAIN ENTRY PORCHES & DECKS, TYPICAL UNO

1/8" = 1'-0"

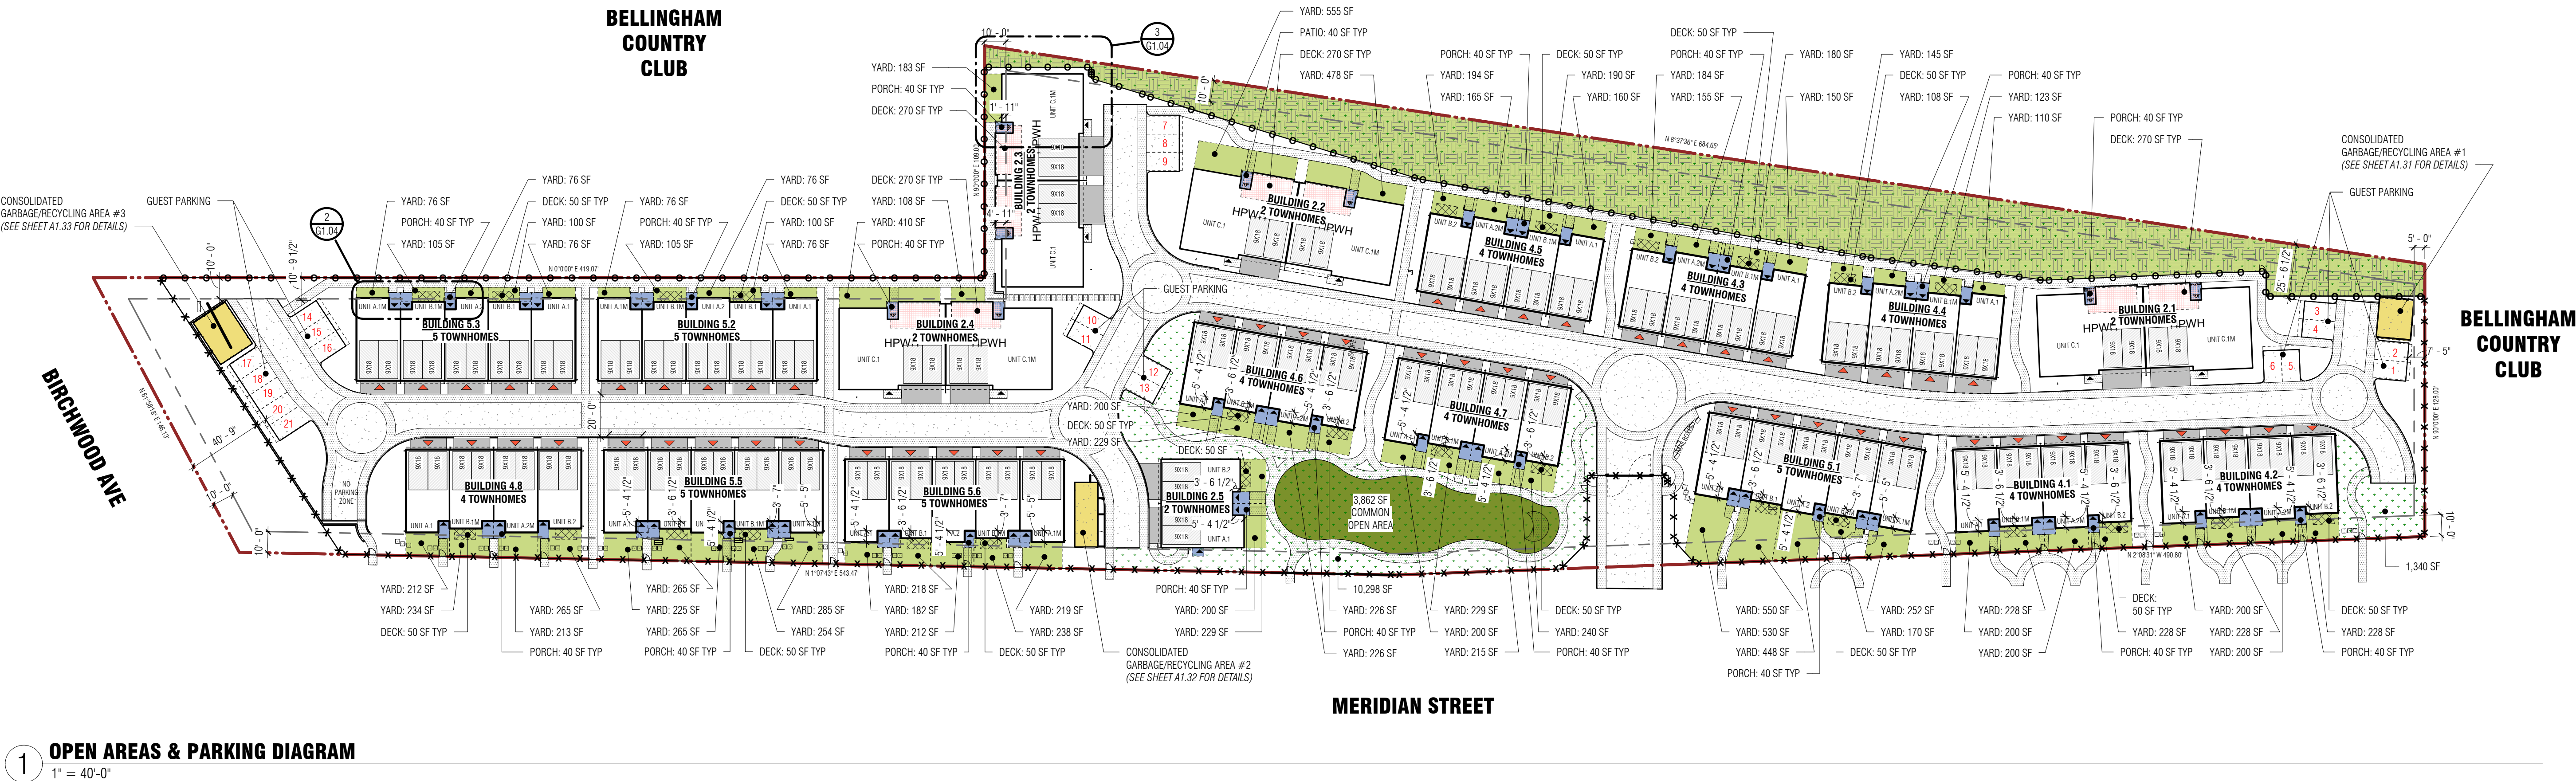


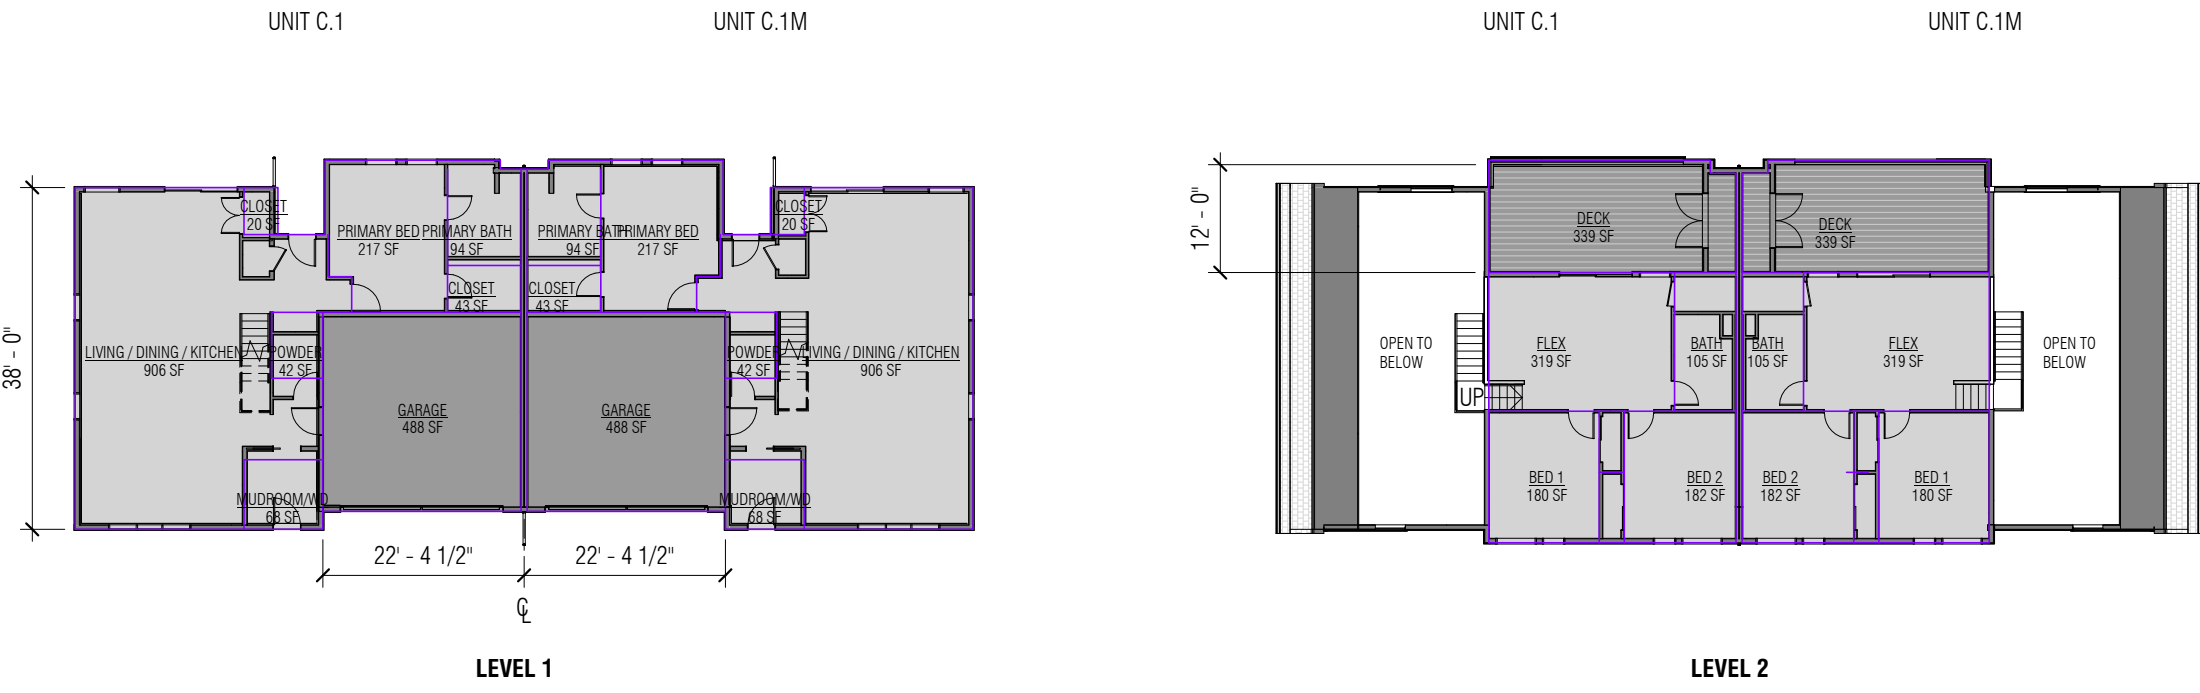


TYPICAL BUILDING PATIO HOME

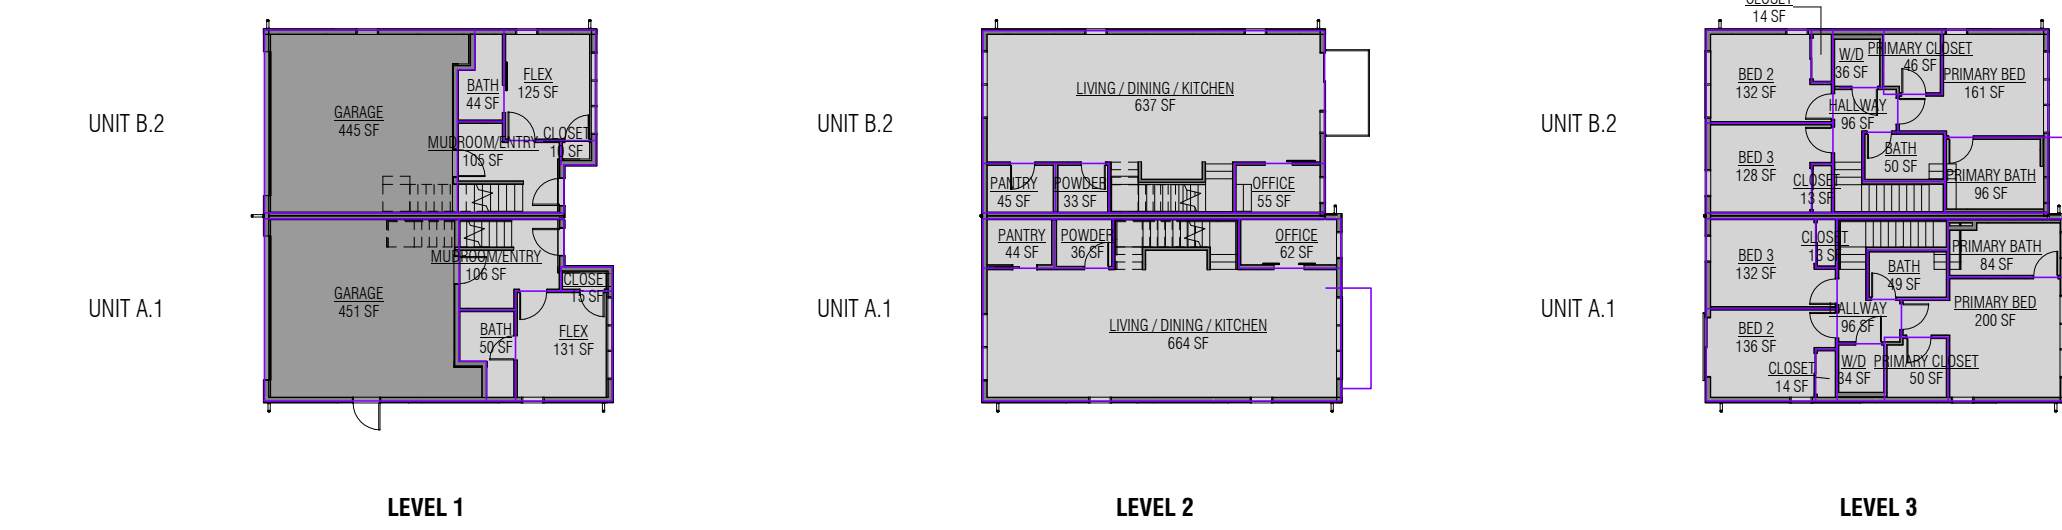

TYPICAL BUILDING 2-2-PACK

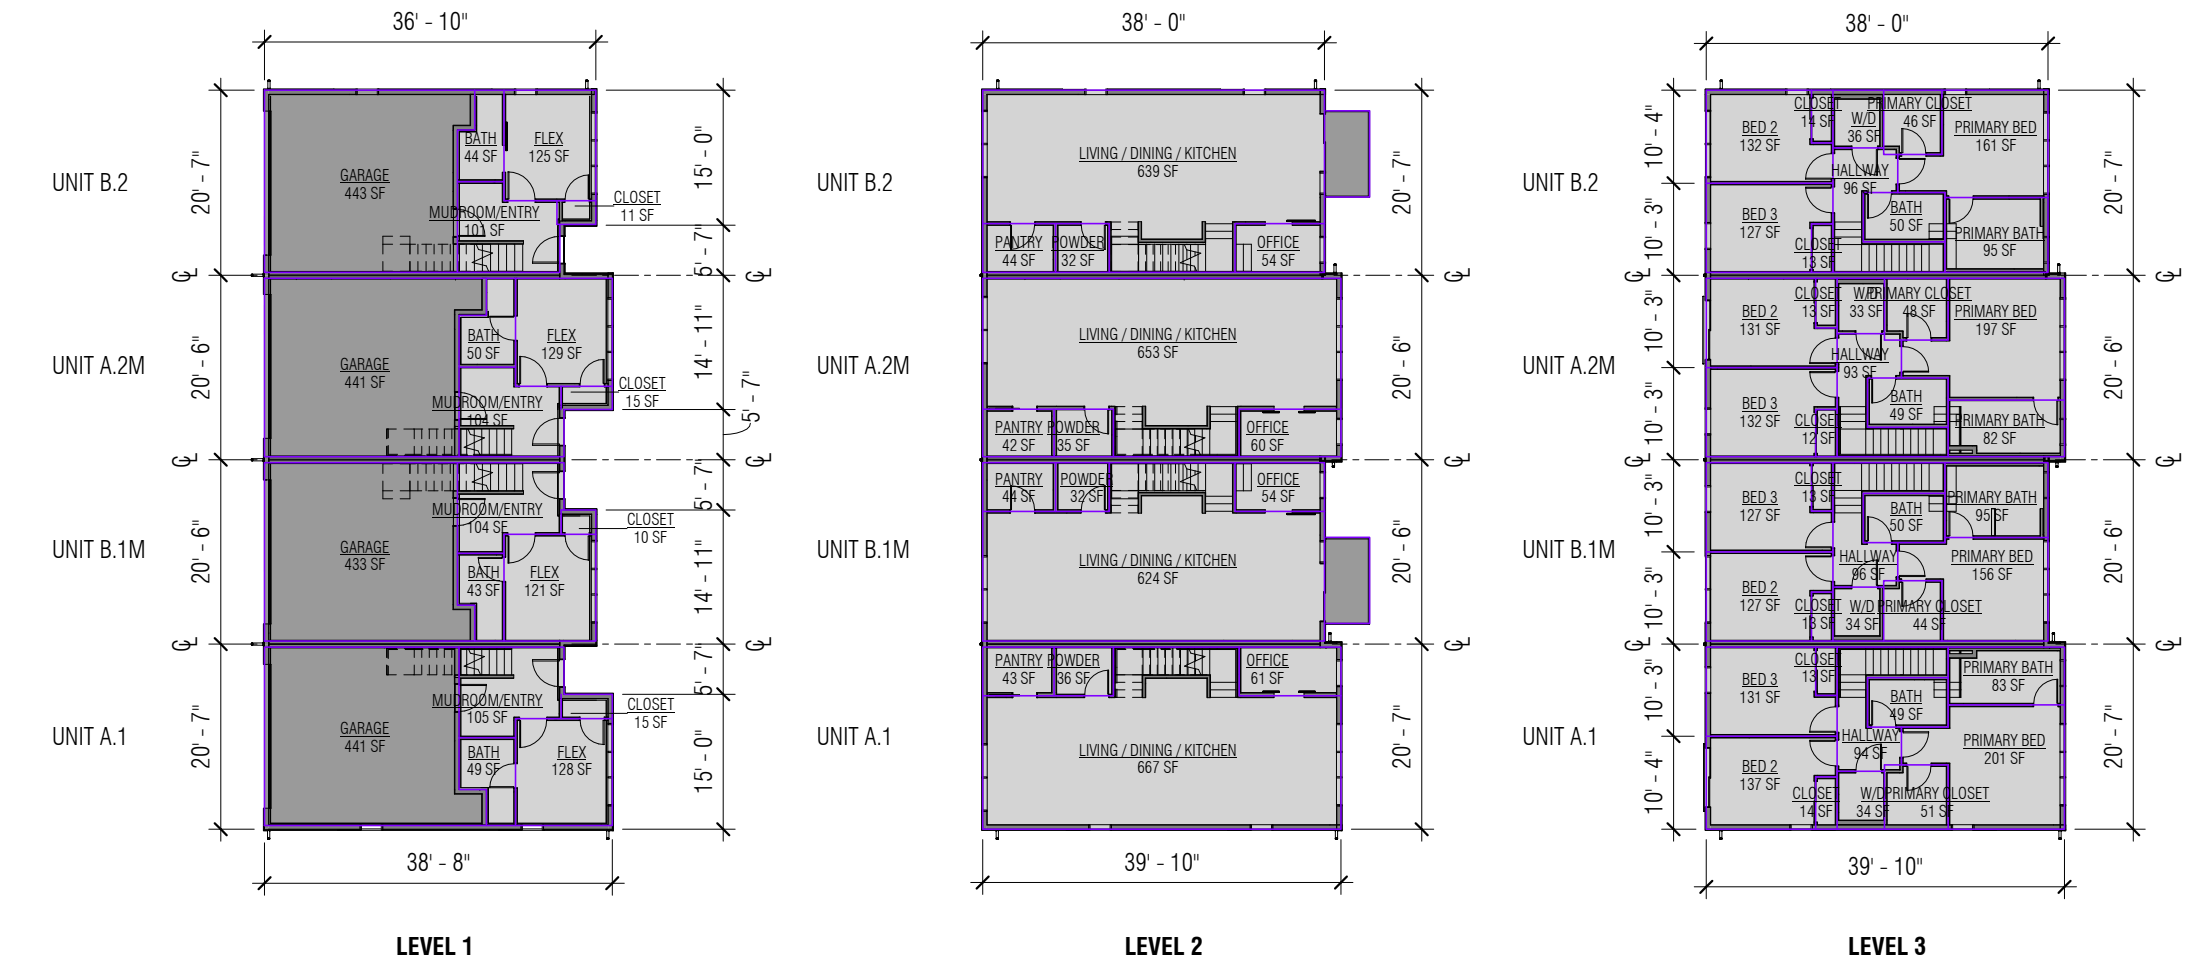

TYPICAL BUILDING 4-PACK

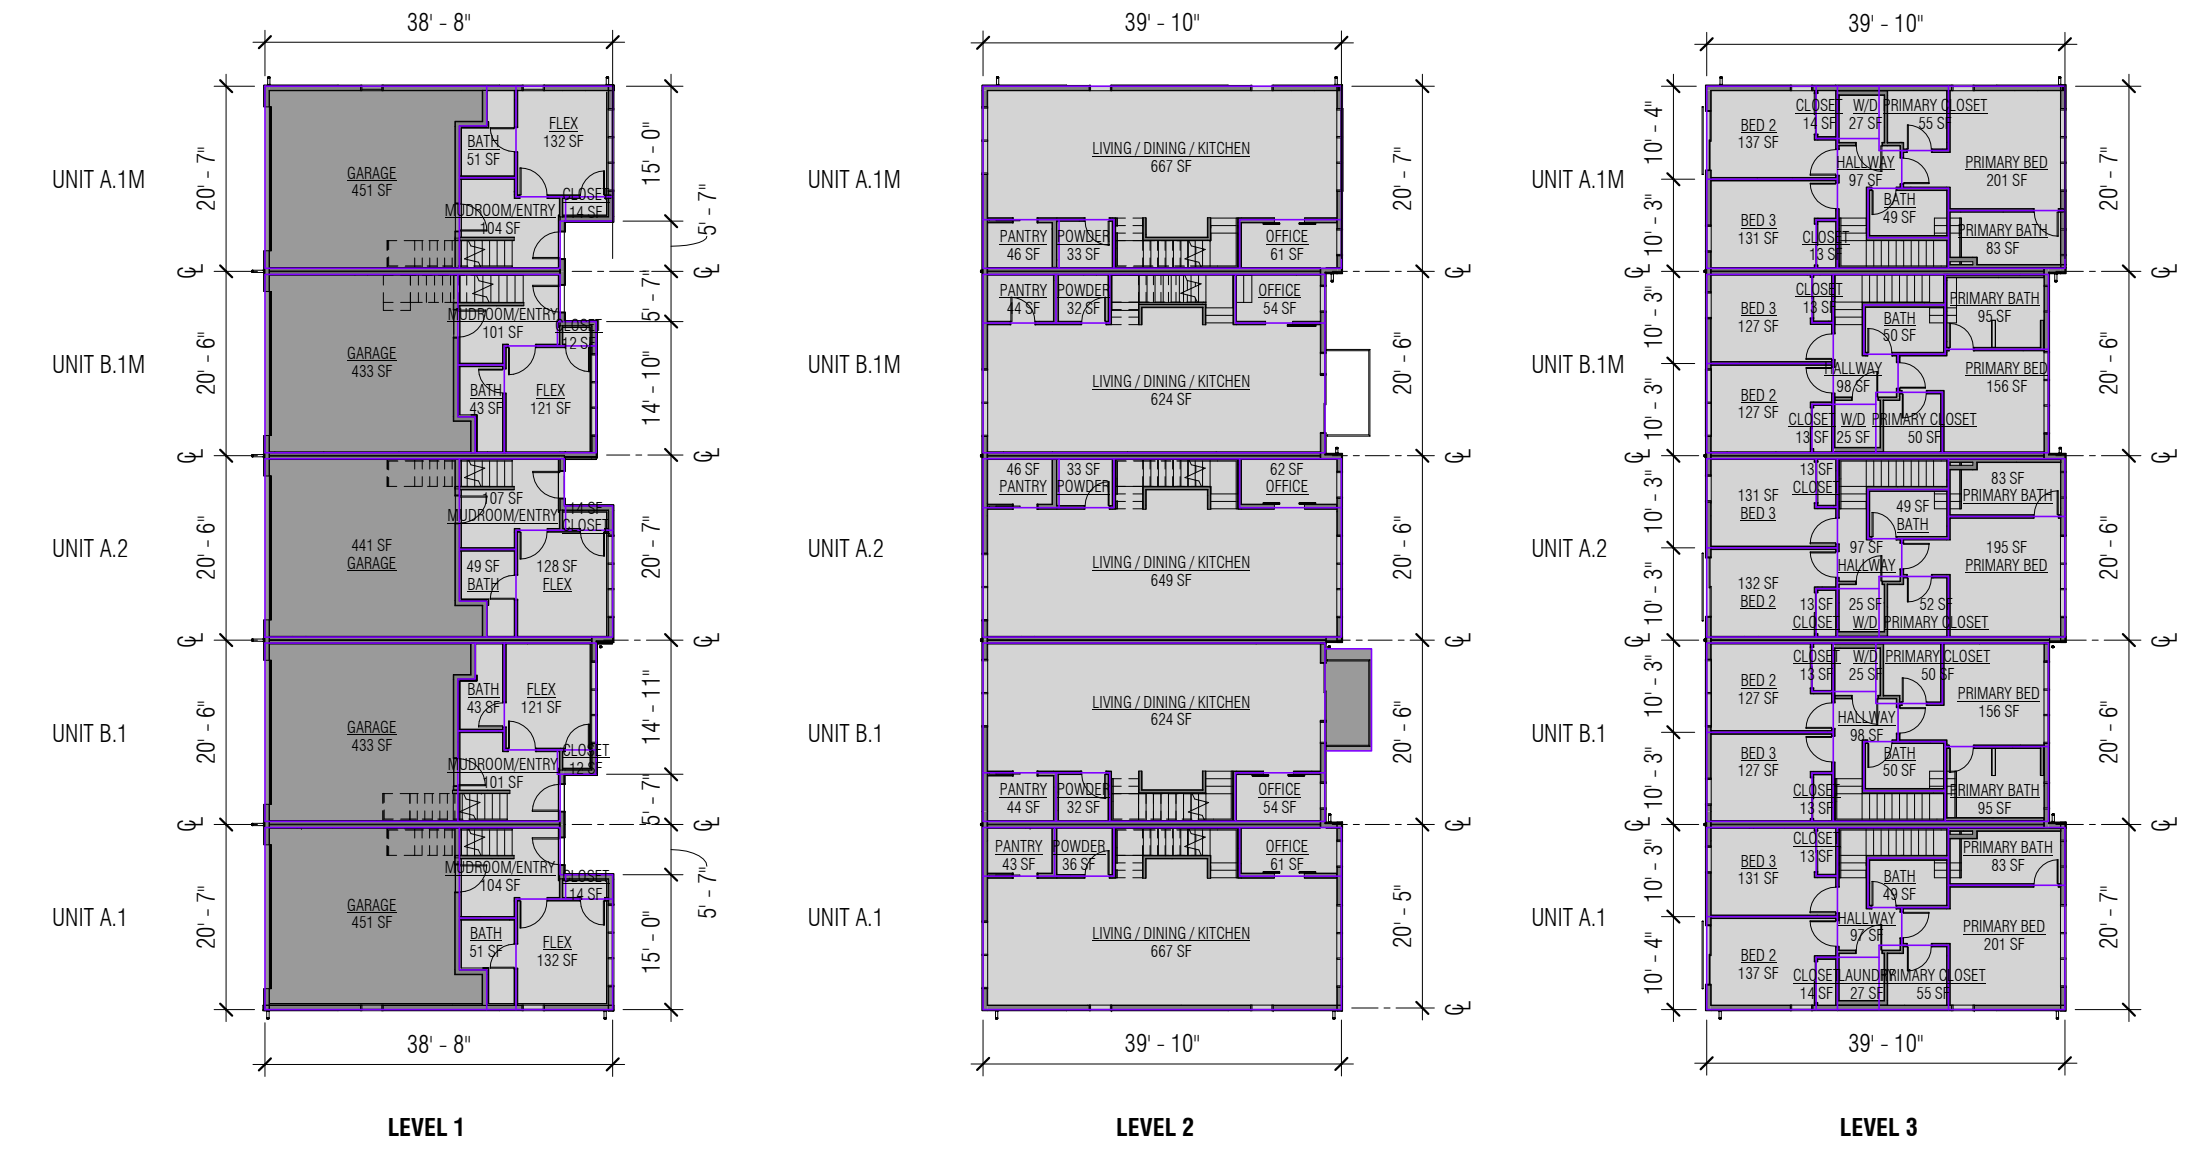

TYPICAL BUILDING 5-PACK

BLDG PATIO HOME				
UNIT	LEVEL	NAME	AREA	
C.1	LEVEL 1	CLOSET	43 SF	
C.1	LEVEL 1	CLOSET	20 SF	
C.1	LEVEL 1	LIVING / DINING / KITCHEN	906 SF	
C.1	LEVEL 1	MUDROOM/W/D	68 SF	
C.1	LEVEL 1	POWDER	42 SF	
C.1	LEVEL 1	PRIMARY BATH	94 SF	
C.1	LEVEL 1	PRIMARY BED	217 SF	
			1,389 SF	
C.1	LEVEL 2	BATH	105 SF	
C.1	LEVEL 2	BED 1	180 SF	
C.1	LEVEL 2	BED 2	182 SF	
C.1	LEVEL 2	CLOSET	19 SF	
C.1	LEVEL 2	CLOSET	22 SF	
C.1	LEVEL 2	FLEX	319 SF	
			826 SF	
			2,215 SF	
C.1M	LEVEL 1	CLOSET	43 SF	
C.1M	LEVEL 1	CLOSET	20 SF	
C.1M	LEVEL 1	LIVING / DINING / KITCHEN	906 SF	
C.1M	LEVEL 1	MUDROOM/W/D	68 SF	
C.1M	LEVEL 1	POWDER	42 SF	
C.1M	LEVEL 1	PRIMARY BATH	94 SF	
C.1M	LEVEL 1	PRIMARY BED	217 SF	
			1,389 SF	
C.1M	LEVEL 2	BATH	105 SF	
C.1M	LEVEL 2	BED 1	180 SF	
C.1M	LEVEL 2	BED 2	182 SF	
C.1M	LEVEL 2	CLOSET	19 SF	
C.1M	LEVEL 2	CLOSET	22 SF	
C.1M	LEVEL 2	FLEX	319 SF	
			826 SF	
			2,215 SF	
			4,430 SF	

BLDG 2-PACK			
UNIT	LEVEL	NAME	AREA
A.1	LEVEL 1	BATH	50 SF
A.1	LEVEL 1	FLEX	131 SF
A.1	LEVEL 1	MUDROOM/ENTRY	106 SF
A.1	LEVEL 1	CLOSET	15 SF
			303 SF
A.1	LEVEL 2	LIVING / DINING / KITCHEN	664 SF
A.1	LEVEL 2	PANTRY	44 SF
A.1	LEVEL 2	POWDER	36 SF
A.1	LEVEL 2	OFFICE	62 SF
			807 SF
A.1	LEVEL 3	BED 2	136 SF
A.1	LEVEL 3	BED 3	132 SF
A.1	LEVEL 3	W/D	34 SF
A.1	LEVEL 3	CLOSET	14 SF
A.1	LEVEL 3	CLOSET	13 SF
A.1	LEVEL 3	PRIMARY CLOSET	50 SF
A.1	LEVEL 3	PRIMARY BED	200 SF
A.1	LEVEL 3	BATH	49 SF
A.1	LEVEL 3	PRIMARY BATH	84 SF
A.1	LEVEL 3	HALLWAY	96 SF
			807 SF
			1,916 SF

B.2	LEVEL 1	BATH	44 SF
B.2	LEVEL 1	FLEX	125 SF
B.2	LEVEL 1	MUDROOM/ENTRY	105 SF
B.2	LEVEL 1	CLOSET	10 SF
			285 SF
B.2	LEVEL 2	LIVING / DINING / KITCHEN	637 SF
B.2	LEVEL 2	PANTRY	45 SF
B.2	LEVEL 2	POWDER	33 SF
B.2	LEVEL 2	OFFICE	55 SF
			770 SF
B.2	LEVEL 3	BED 2	132 SF
B.2	LEVEL 3	BED 3	128 SF
B.2	LEVEL 3	W/D	36 SF
B.2	LEVEL 3	CLOSET	14 SF
B.2	LEVEL 3	CLOSET	13 SF
B.2	LEVEL 3	PRIMARY CLOSET	46 SF
B.2	LEVEL 3	PRIMARY BED	161 SF
B.2	LEVEL 3	BATH	50 SF
B.2	LEVEL 3	PRIMARY BATH	96 SF
B.2	LEVEL 3	HALLWAY	96 SF
			773 SF
			1,827 SF
			3,744 SF

BLDG PATIO HOME		
UNIT	LEVEL	AREA
C.1	LEVEL 1	1,389 SF
C.1	LEVEL 2	826 SF
		2,215 SF
C.1M	LEVEL 1	1,389 SF
C.1M	LEVEL 2	826 SF
		2,215 SF
		4,430 SF

BLDG 2-PACK		
UNIT	LEVEL	AREA
A.1	LEVEL 1	303 SF
A.1	LEVEL 2	807 SF
A.1	LEVEL 3	807 SF
		1,916 SF
B.2	LEVEL 1	285 SF
B.2	LEVEL 2	770 SF
B.2	LEVEL 3	773 SF
		1,827 SF
		3,744 SF

BLDG 4-PACK			
UNIT	LEVEL	NAME	AREA
A.1	LEVEL 1	BATH	49 SF
A.1	LEVEL 1	FLEX	128 SF
A.1	LEVEL 1	MUDROOM/ENTRY	105 SF
A.1	LEVEL 1	CLOSET	15 SF
			298 SF
A.1	LEVEL 2	LIVING / DINING / KITCHEN	667 SF
A.1	LEVEL 2	PANTRY	43 SF
A.1	LEVEL 2	POWDER	36 SF
A.1	LEVEL 2	OFFICE	61 SF
			807 SF
A.1	LEVEL 3	BED 2	137 SF
A.1	LEVEL 3	BED 3	131 SF
A.1	LEVEL 3	W/D	34 SF
A.1	LEVEL 3	CLOSET	14 SF
A.1	LEVEL 3	CLOSET	13 SF
A.1	LEVEL 3	BATH	49 SF
A.1	LEVEL 3	PRIMARY CLOSET	51 SF
A.1	LEVEL 3	PRIMARY BED	201 SF
A.1	LEVEL 3	PRIMARY BATH	83 SF
A.1	LEVEL 3	HALLWAY	94 SF
			807 SF
			1,911 SF

A.2M	LEVEL 1	BATH	50 SF
A.2M	LEVEL 1	FLEX	129 SF
A.2M	LEVEL 1	MUDROOM/ENTRY	104 SF
A.2M	LEVEL 1	CLOSET	15 SF
			297 SF
A.2M	LEVEL 2	LIVING / DINING / KITCHEN	653 SF
A.2M	LEVEL 2	PANTRY	42 SF
A.2M	LEVEL 2	POWDER	35 SF
A.2M	LEVEL 2	OFFICE	60 SF
			790 SF
A.2M	LEVEL 3	BED 2	131 SF
A.2M	LEVEL 3	BED 3	132 SF
A.2M	LEVEL 3	W/D	33 SF
A.2M	LEVEL 3	CLOSET	13 SF
A.2M	LEVEL 3	CLOSET	12 SF
A.2M	LEVEL 3	BATH	49 SF
A.2M	LEVEL 3	PRIMARY CLOSET	48 SF
A.2M	LEVEL 3	PRIMARY BED	197 SF
A.2M	LEVEL 3	PRIMARY BATH	82 SF
A.2M	LEVEL 3	HALLWAY	93 SF
			790 SF
			1,877 SF

B.1M	LEVEL 1	BATH	43 SF
B.1M	LEVEL 1	FLEX	121 SF
B.1M	LEVEL 1	MUDROOM/ENTRY	104 SF
B.1M	LEVEL 1	CLOSET	10 SF
			279 SF
B.1M	LEVEL 2	LIVING / DINING / KITCHEN	624 SF
B.1M	LEVEL 2	PANTRY	44 SF
B.1M	LEVEL 2	POWDER	32 SF
B.1M	LEVEL 2	OFFICE	54 SF
			754 SF
B.1M	LEVEL 3	BED 2	127 SF
B.1M	LEVEL 3	BED 3	127 SF
B.1M	LEVEL 3	W/D	34 SF
B.1M	LEVEL 3	CLOSET	13 SF
B.1M	LEVEL 3	CLOSET	13 SF
B.1M	LEVEL 3	BATH	50 SF
B.1M	LEVEL 3	PRIMARY CLOSET	44 SF
B.1M	LEVEL 3	PRIMARY BED	156 SF
B.1M	LEVEL 3	PRIMARY BATH	95 SF
B.1M	LEVEL 3	HALLWAY	96 SF
			754 SF
			1,786 SF

B.2	LEVEL 1	BATH	44 SF
B.2	LEVEL 1	FLEX	125 SF
B.2	LEVEL 1	MUDROOM/ENTRY	101 SF
B.2	LEVEL 1	CLOSET	11 SF
			282 SF
B.2	LEVEL 2	LIVING / DINING / KITCHEN	639 SF
B.2	LEVEL 2	PANTRY	44 SF
B.2	LEVEL 2	POWDER	32 SF
B.2	LEVEL 2	OFFICE	54 SF
			770 SF
B.2	LEVEL 3	BED 2	132 SF
B.2	LEVEL 3	BED 3	127 SF
B.2	LEVEL 3	W/D	36 SF
B.2	LEVEL 3	CLOSET	14 SF
B.2	LEVEL 3	CLOSET	13 SF
B.2	LEVEL 3	BATH	50 SF
B.2	LEVEL 3	PRIMARY CLOSET	46 SF
B.2	LEVEL 3	PRIMARY BED	161 SF
B.2	LEVEL 3	PRIMARY BATH	95 SF
B.2	LEVEL 3	HALLWAY	96 SF
			770 SF
			1,821 SF
			7,395 SF

BLDG 4-PACK		
UNIT	LEVEL	AREA
A.1	LEVEL 1	298 SF
A.1	LEVEL 2	807 SF
A.1	LEVEL 3	807 SF
		1,911 SF
A.2M	LEVEL 1	297 SF
A.2M	LEVEL 2	790 SF
A.2M	LEVEL 3	790 SF
		1,877 SF
B.1M	LEVEL 1	279 SF
B.1M	LEVEL 2	754 SF
B.1M	LEVEL 3	754 SF
		1,786 SF
B.2	LEVEL 1	282 SF
B.2	LEVEL 2	770 SF
B.2	LEVEL 3	770 SF
		1,821 SF
		7,395 SF

BLDG 5-PACK			
UNIT	LEVEL	NAME	AREA
A.1	LEVEL 1	BATH	51 SF
A.1	LEVEL 1	FLEX	132 SF
A.1	LEVEL 1	MUDROOM/ENTRY	104 SF
A.1	LEVEL 1	CLOSET	14 SF
			301 SF
A.1	LEVEL 2	LIVING / DINING / KITCHEN	667 SF
A.1	LEVEL 2	PANTRY	43 SF
A.1	LEVEL 2	POWDER	36 SF
A.1	LEVEL 2	OFFICE	61 SF
			807 SF
A.1	LEVEL 3	BED 2	137 SF
A.1	LEVEL 3	BED 3	131 SF
A.1	LEVEL 3	LAUNDRY	27 SF
A.1	LEVEL 3	CLOSET	14 SF
A.1	LEVEL 3	CLOSET	13 SF
A.1	LEVEL 3	BATH	49 SF
A.1	LEVEL 3	PRIMARY CLOSET	55 SF
A.1	LEVEL 3	PRIMARY BED	201 SF
A.1	LEVEL 3	PRIMARY BATH	83 SF
A.1	LEVEL 3	HALLWAY	97 SF
			807 SF
			1,914 SF


A.1M	LEVEL 1	BATH	51 SF
A.1M	LEVEL 1	FLEX	132 SF
A.1M	LEVEL 1	MUDROOM/ENTRY	104 SF
A.1M	LEVEL 1	CLOSET	14 SF
			301 SF
A.1M	LEVEL 2	LIVING / DINING / KITCHEN	667 SF
A.1M	LEVEL 2	PANTRY	46 SF
A.1M	LEVEL 2	POWDER	33 SF
A.1M	LEVEL 2	OFFICE	61 SF
			807 SF
A.1M	LEVEL 3	BED 2	137 SF
A.1M	LEVEL 3	BED 3	131 SF
A.1M	LEVEL 3	W/D	27 SF
A.1M	LEVEL 3	CLOSET	14 SF
A.1M	LEVEL 3	CLOSET	13 SF
A.1M	LEVEL 3	BATH	49 SF
A.1M	LEVEL 3	PRIMARY CLOSET	55 SF
A.1M	LEVEL 3	PRIMARY BED	201 SF
A.1M	LEVEL 3	PRIMARY BATH	83 SF
A.1M	LEVEL 3	HALLWAY	97 SF
			807 SF
			1,914 SF

A.2	LEVEL 1	BATH	49 SF
A.2	LEVEL 1	FLEX	128 SF
A.2	LEVEL 1	MUDROOM/ENTRY	107 SF
A.2	LEVEL 1	CLOSET	14 SF
			298 SF
A.2	LEVEL 2	LIVING / DINING / KITCHEN	649 SF
A.2	LEVEL 2	PANTRY	46 SF
A.2	LEVEL 2	POWDER	33 SF
A.2	LEVEL 2	OFFICE	62 SF
			790 SF
A.2	LEVEL 3	BED 2	132 SF
A.2	LEVEL 3	BED 3	131 SF
A.2	LEVEL 3	W/D	25 SF
A.2	LEVEL 3	CLOSET	13 SF
A.2	LEVEL 3	CLOSET	13 SF
A.2	LEVEL 3	BATH	49 SF
A.2	LEVEL 3	PRIMARY CLOSET	52 SF
A.2	LEVEL 3	PRIMARY BED	195 SF
A.2	LEVEL 3	PRIMARY BATH	83 SF
A.2	LEVEL 3	HALLWAY	97 SF
			790 SF
			1,878 SF

BLDG 5-PACK			
UNIT	LEVEL	NAME	AREA
B.1	LEVEL 1	BATH	43 SF
B.1	LEVEL 1	FLEX	121 SF
B.1	LEVEL 1	MUDROOM/ENTRY	101 SF
B.1	LEVEL 1	CLOSET	12 SF
			276 SF
B.1	LEVEL 2	LIVING / DINING / KITCHEN	624 SF
B.1	LEVEL 2	PANTRY	44 SF
B.1	LEVEL 2	POWDER	32 SF
B.1	LEVEL 2	OFFICE	54 SF
			754 SF
B.1	LEVEL 3	BED 2	127 SF
B.1	LEVEL 3	BED 3	121 SF
B.1	LEVEL 3	W/D	25 SF
B.1	LEVEL 3	CLOSET	13 SF
B.1	LEVEL 3	CLOSET	13 SF
B.1	LEVEL 3	BATH	50 SF
B.1	LEVEL 3	PRIMARY CLOSET	50 SF
B.1	LEVEL 3	PRIMARY BED	156 SF
B.1	LEVEL 3	PRIMARY BATH	95 SF
B.1	LEVEL 3	HALLWAY	98 SF
			754 SF
			1,784 SF

B.1M	LEVEL 1	BATH	43 SF
B.1M	LEVEL 1	FLEX	121 SF
B.1M	LEVEL 1	MUDROOM/ENTRY	101 SF
B.1M	LEVEL 1	CLOSET	12 SF
			276 SF
B.1M	LEVEL 2	LIVING / DINING / KITCHEN	624 SF
B.1M	LEVEL 2	PANTRY	44 SF
B.1M	LEVEL 2	POWDER	32 SF
B.1M	LEVEL 2	OFFICE	54 SF
			754 SF
B.1M	LEVEL 3	BED 2	127 SF
B.1M	LEVEL 3	BED 3	121 SF
B.1M	LEVEL 3	W/D	25 SF
B.1M	LEVEL 3	CLOSET	13 SF
B.1M	LEVEL 3	CLOSET	13 SF
B.1M	LEVEL 3	BATH	50 SF
B.1M	LEVEL 3	PRIMARY CLOSET	50 SF
B.1M	LEVEL 3	PRIMARY BED	156 SF
B.1M	LEVEL 3	PRIMARY BATH	95 SF
B.1M	LEVEL 3	HALLWAY	98 SF
			754 SF
			1,784 SF
			9,273 SF

LEGEND

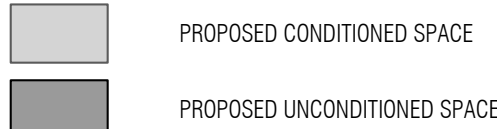

PROJECT INFORMATION

ASSESSOR PARCEL NO: APN 380213 546133 000

LEGAL DESCRIPTION: PER CHICAGO TITLE COMPANY ORDER NO. 245444100 UPDATE #3 COMMITMENT DATE: SEPTEMBER 27, 2022.

LOT 2, AS DELINEATED ON BG & CC SHORT PLAT, ACCORDING TO THE PLAT THEREOF, RECORDED UNDER AUDITOR'S FILE NO. 2022-0800206, RECORDS OF WHATCOM COUNTY, WASHINGTON.

SITUATE IN WHATCOM COUNTY, WASHINGTON.

DEMO SITE PLAN KEY



PROPERTY LINE

GENERAL NOTES - SITE PLAN

1. SITE INFORMATION CONTAINED HEREIN IS BASED ON A SURVEY BY LAND DEVELOPMENT ENGINEERING & SURVEYING, DATED 02/02/2022, GATHERED BY FIELD TRAVERSE UTILIZING ELECTRONIC DATA COLLECTION IN APRIL, MAY, & OCTOBER, 2021.
2. INSTALLATION OF EROSION CONTROL MEASURES IS REQUIRED PRIOR TO ANY GROUND DISTURBANCE PER CIVIL DRAWINGS.
3. CONTRACTOR IS RESPONSIBLE FOR SCHEDULING A "FIRST GROUND DISTURBANCE INSPECTION" AFTER THE BUILDING PERMIT IS ISSUED TO MEET WITH THE SITE INSPECTOR.
4. REFER TO CIVIL FOR ALL WORK PROPOSED IN THE RIGHT OF WAY.
5. REFER TO LANDSCAPE FOR TREE PRESERVATION AND RETENTION PLAN.



CITY OF BELLINGHAM STAMP AREA

STREAM BELLINGHAM - SITE

PROJECT ADDRESS:
3309 MERIDIAN STREET, BELLINGHAM, WA 98225

OWNER:
STREAM REAL ESTATE

REVISION	DATE	DESCRIPTION
----------	------	-------------

ISSUANCES

DATE	DESCRIPTION
7/29/2022	LAND USE APPLICATION
1/13/2023	LAND USE APP RESUBMITTAL
4/14/2023	LAND USE APP RESUBMITTAL

COPYRIGHT BOARD AND VELLUM, LLC. ALL RIGHTS RESERVED.
ORIGINAL SHEET SIZE IS 22"x34"


BOARD & VELLUM PROJECT #: 2021170.00
COB PROJECT #: 2021-0105

PLOT DATE: 04.12.2023

DEMOLITION SITE PLAN

SHEET NO.:


A1.01

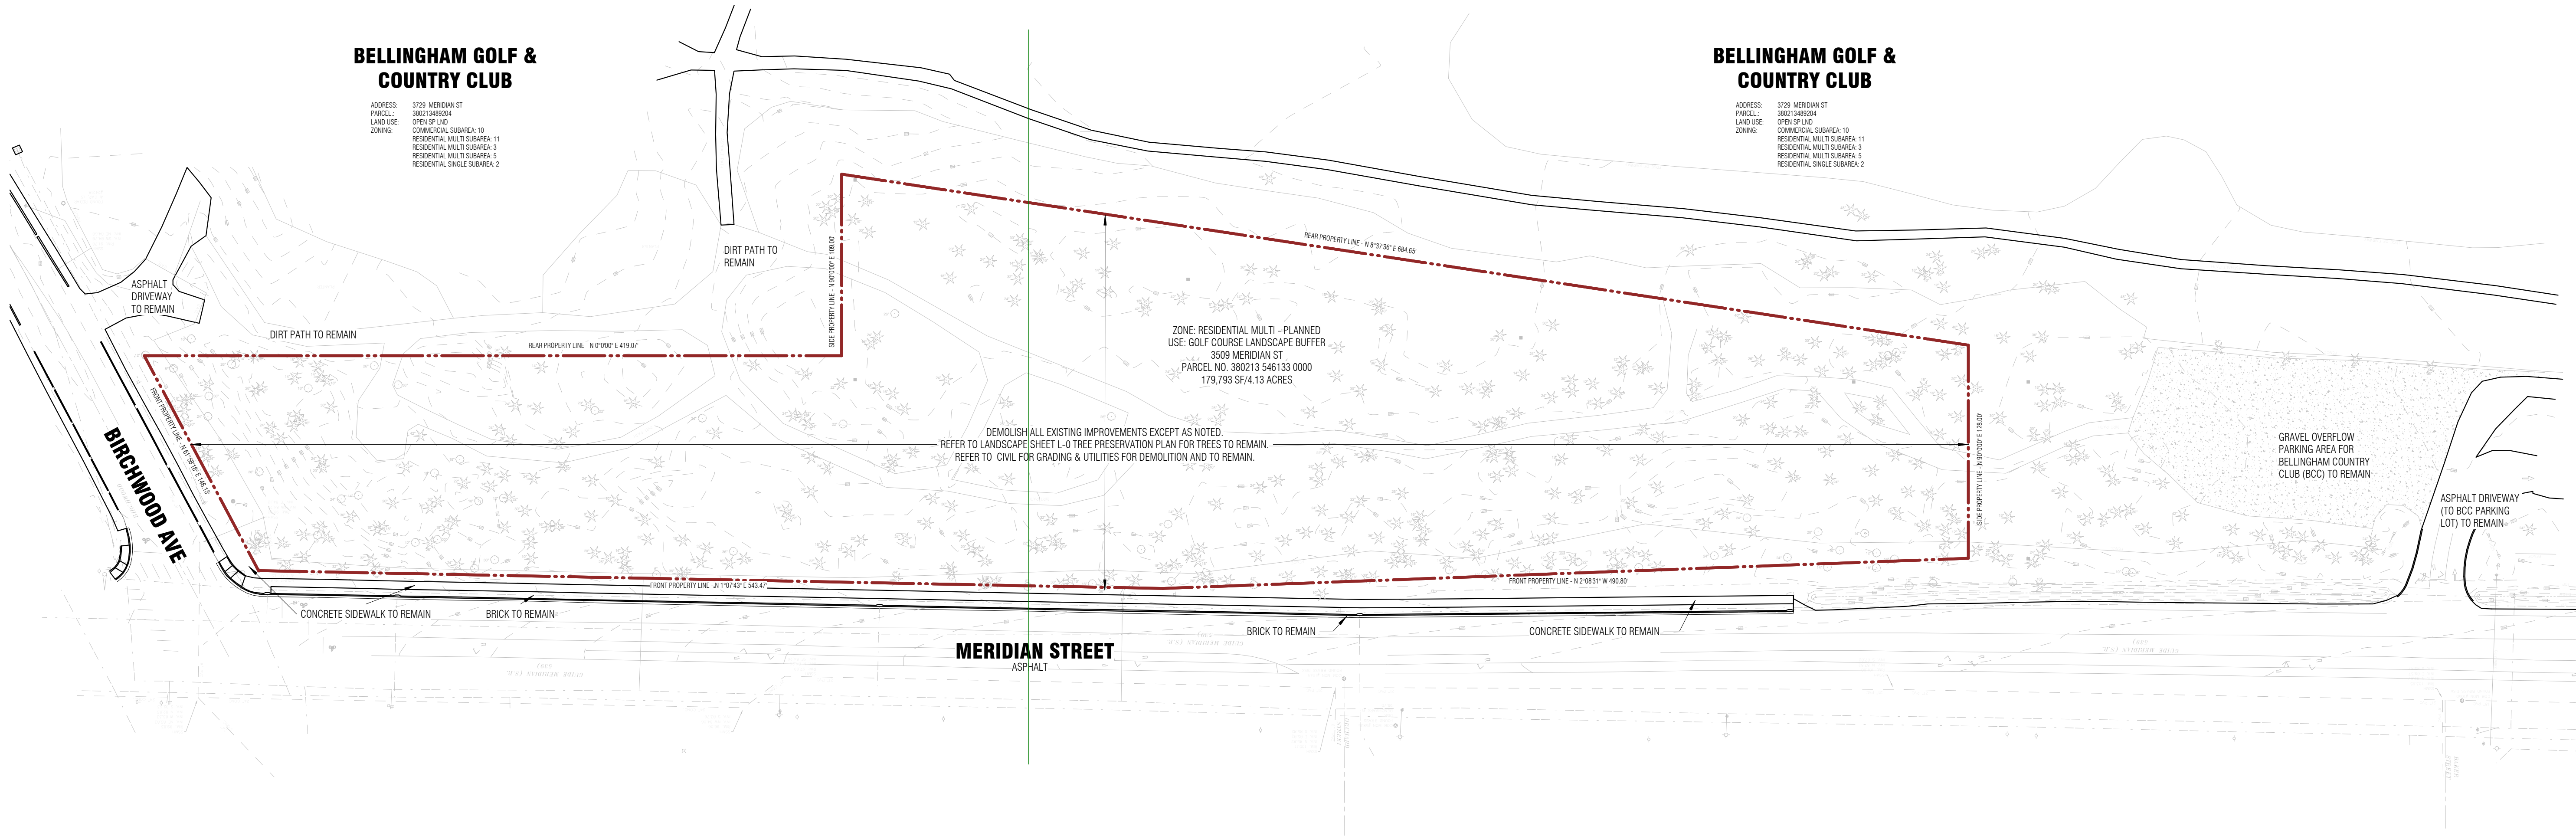

1 DEMOLITION SITE PLAN
1" = 50'-0"

1. SITE INFORMATION CONTAINED HEREIN IS BASED ON A SURVEY BY LAND DEVELOPMENT ENGINEERING & SURVEYING, DATED 02/02/2022, GATHERED BY FIELD TRAVERSE UTILIZING ELECTRONIC DATA COLLECTION IN APRIL, MAY, & OCTOBER, 2021.
2. INSTALLATION OF EROSION CONTROL MEASURES IS REQUIRED PRIOR TO ANY GROUND DISTURBANCE PER CIVIL DRAWINGS.
3. CONTRACTOR IS RESPONSIBLE FOR SCHEDULING A "FIRST GROUND DISTURBANCE INSPECTION" AFTER THE BUILDING PERMIT IS ISSUED TO MEET WITH THE SITE INSPECTOR.
4. REFER TO CIVIL FOR ALL WORK PROPOSED IN THE RIGHT OF WAY.
5. REFER TO LANDSCAPE FOR TREE PRESERVATION AND RETENTION PLAN.

The diagram illustrates a residential lot layout with various setbacks and features. At the top, a red dashed line represents the PROPERTY LINE. Below it is a solid black line for the LINE OF SETBACK. The next feature is a 42" HIGH PERIMETER FENCE, shown as a line with 'X' markers. Below the fence is a 60" HIGH PERIMETER FENCE, shown as a line with 'O' markers. This is followed by a dashed line representing the BUILDING/ROOF OVERHANG. The lot is then divided into three horizontal sections: a CONCRETE PEDESTRIAN WALKWAY (light gray with a dot pattern), PERMEABLE PAVEMENT (dark gray), and a CONCRETE DRIVEWAY (light gray). Below these is a green hatched area representing the DEDICATED OPEN SPACE TRACT. At the bottom, a blue triangle points to the BUILDING ENTRY, and a red triangle points to the GARAGE ENTRY.

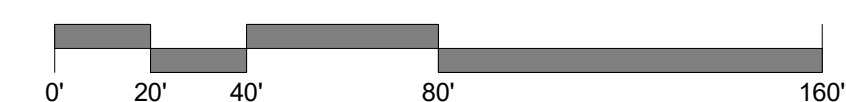



1 EAST SITE ELEVATION - NORTH
1/16" = 1'-0"




2 EAST SITE ELEVATION - CENTRAL
1/16" = 1'-0"



3 EAST SITE ELEVATION - SOUTH
1/16" = 1'-0"



4 EAST SITE ELEVATION - OVERALL
1" = 40'-0"

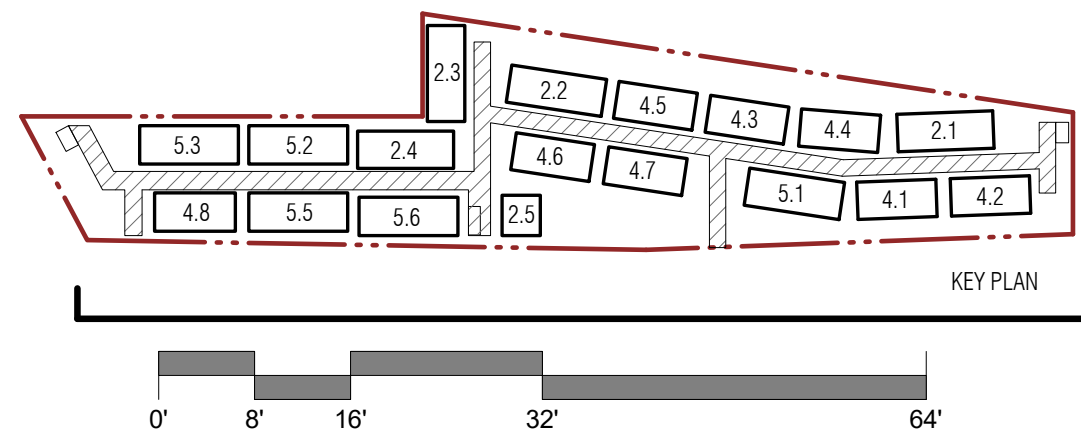

STREAM BELLINGHAM - SITE

PROJECT ADDRESS:
3509 MERIDIAN STREET, BELLINGHAM, WA 98225
OWNER:
STREAM REAL ESTATE

REVISION	DATE	DESCRIPTION
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ISSUANCES	
DATE	DESCRIPTION
7/29/2022	LAND USE APPLICATION
1/13/2023	LAND USE APP RESUBMITTAL
4/14/2023	LAND USE APP RESUBMITTAL

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ORIGINAL SHEET SIZE IS 22"x34"
BOARD & VELLUM PROJECT #: 2021170.00
COB PROJECT #: 2021-0105

PLOT DATE: 04.12.2023

SITE ELEVATIONS

SHEET NO.:

A1.31



1 WEST SITE ELEVATION - NORTH
1/16" = 1'-0"




2 WEST SITE ELEVATION - CENTRAL
1/16" = 1'-0"



3 WEST SITE ELEVATION - SOUTH
1/16" = 1'-0"



4 WEST SITE ELEVATION - OVERALL
1" = 40'-0"

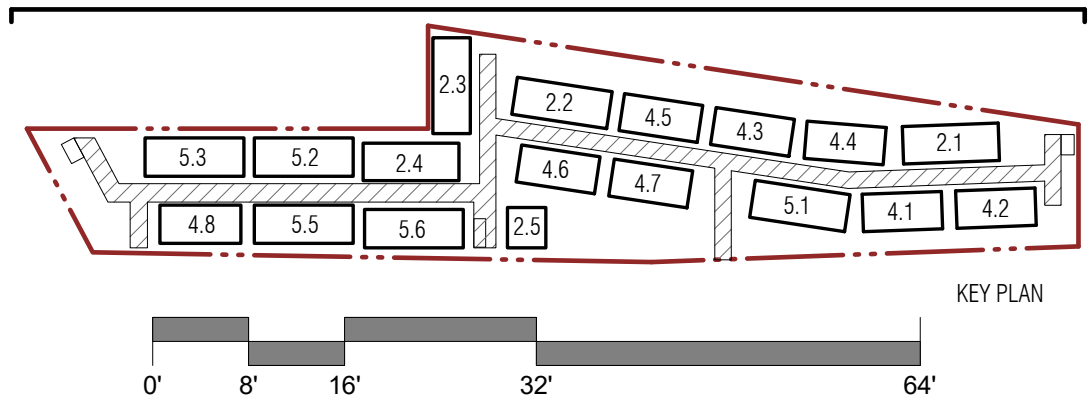

REVISION	DATE	DESCRIPTION
----------	------	-------------

ISSUANCES	DATE	DESCRIPTION
	7/29/2022	LAND USE APPLICATION
	1/13/2023	LAND USE APP RESUBMITTAL
	4/14/2023	LAND USE APP RESUBMITTAL

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ORIGINAL SHEET SIZE IS 22"x34"


BOARD & VELLUM PROJECT #: 2021170.00
COB PROJECT #: 2021-0105

PLOT DATE: 04.12.2023

SITE ELEVATIONS

SHEET NO.:

A1.32

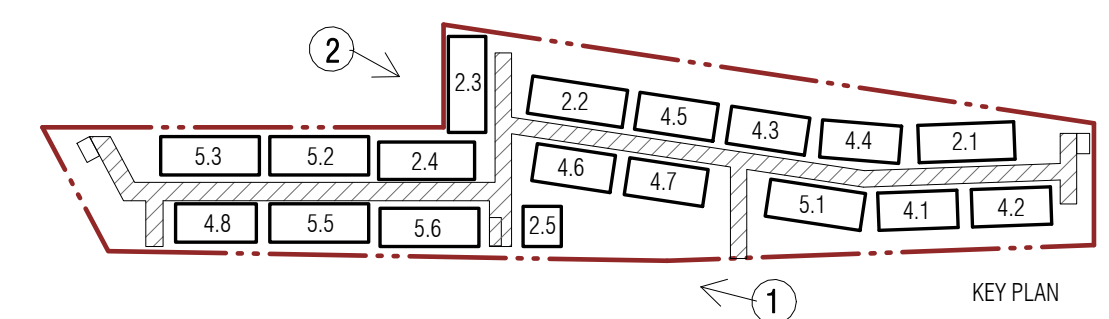

STREAM BELLINGHAM - SITE

STREAM BELLINGHAM

PROJECT ADDRESS:
3509 MERIDIAN STREET, BELLINGHAM, WA 98225

OWNER:
STREAM REAL ESTATE

SESSION	DATE	DESCRIPTION
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DATE	DESCRIPTION
9/2022	LAND USE APPLICATION
3/2023	LAND USE APP RESUBMITTAL
4/2023	LAND USE APP RESUBMITTAL

RIGHT BOARD AND VELLUM LLC. ALL RIGHTS RESERVED.
SHEET SIZE IS 22"x34"

RD & VELLUM PROJECT #:	2021170.00
PROJECT #:	2021-0105

DATE: 04.12.2023

TE PERSPECTIVES

ET NO.:




1 PERSPECTIVE AT 5-HOME BUILDINGS FRONTING MERIDIAN AVENUE



2 PERSPECTIVE AT 4-HOME BUILDINGS FRONTING MERIDIAN AVENUE



3 PERSPECTIVE AT 4-HOME BUILDINGS FRONTING GOLF COURSE

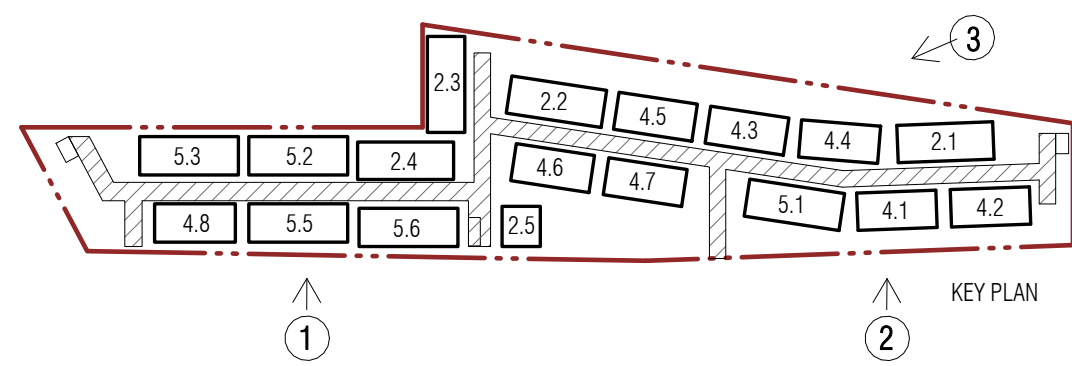

STREAM BELLINGHAM - SITE

PROJECT ADDRESS:
3509 MERIDIAN STREET, BELLINGHAM, WA 98225

OWNER:
STREAM REAL ESTATE

REVISION	DATE	DESCRIPTION
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DATE	DESCRIPTION
7/29/2022	LAND USE APPLICATION
1/13/2023	LAND USE APP RESUBMITTAL
4/14/2023	LAND USE APP RESUBMITTAL


COPYRIGHT BOARD AND VELLUM LLC. ALL RIGHTS RESERVED.
ORIGINAL SHEET SIZE IS 22"x34"

BOARD & VELLUM PROJECT #: 2021170.00
COB PROJECT #: 2021-0105


PLOT DATE: 04.12.2023

SITE PERSPECTIVES


SHEET NO.:

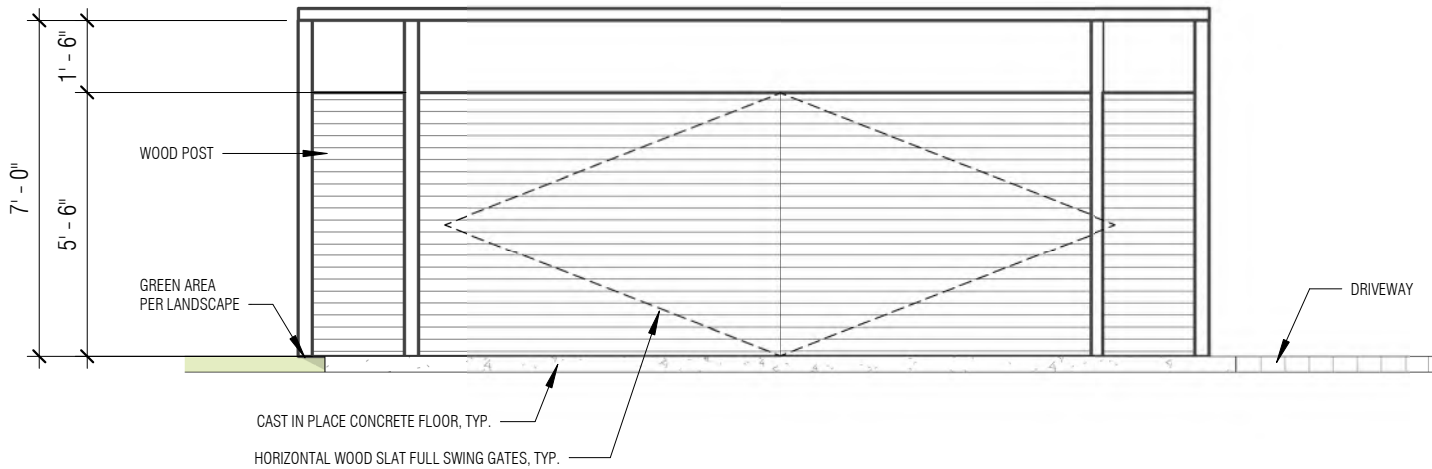


1 **CONSOLIDATED GARBAGE/RECYCLING ENCLOSURE #1 - W ELEVATION**
1/4" = 1'-0"

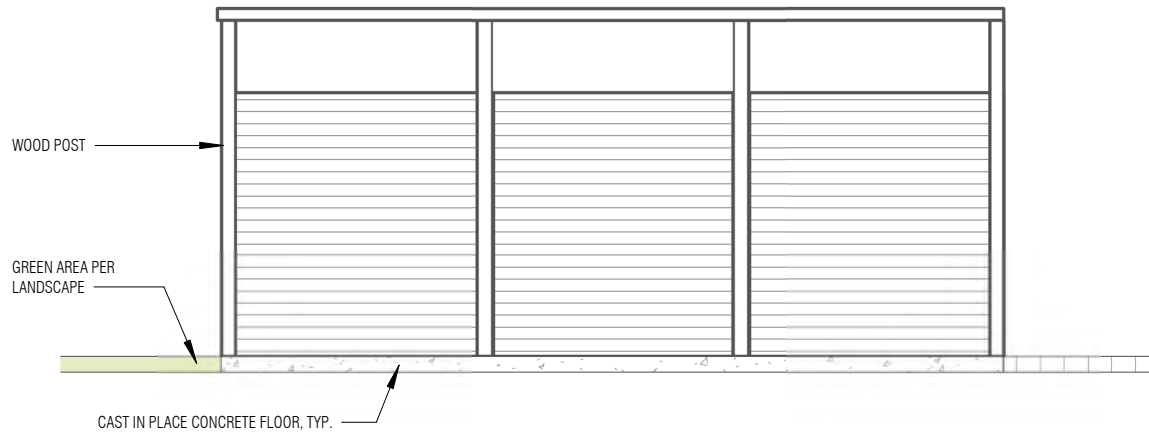


2 **CONSOLIDATED GARBAGE/RECYCLING ENCLOSURE #1 - N ELEVATION**
1/4" = 1'-0"

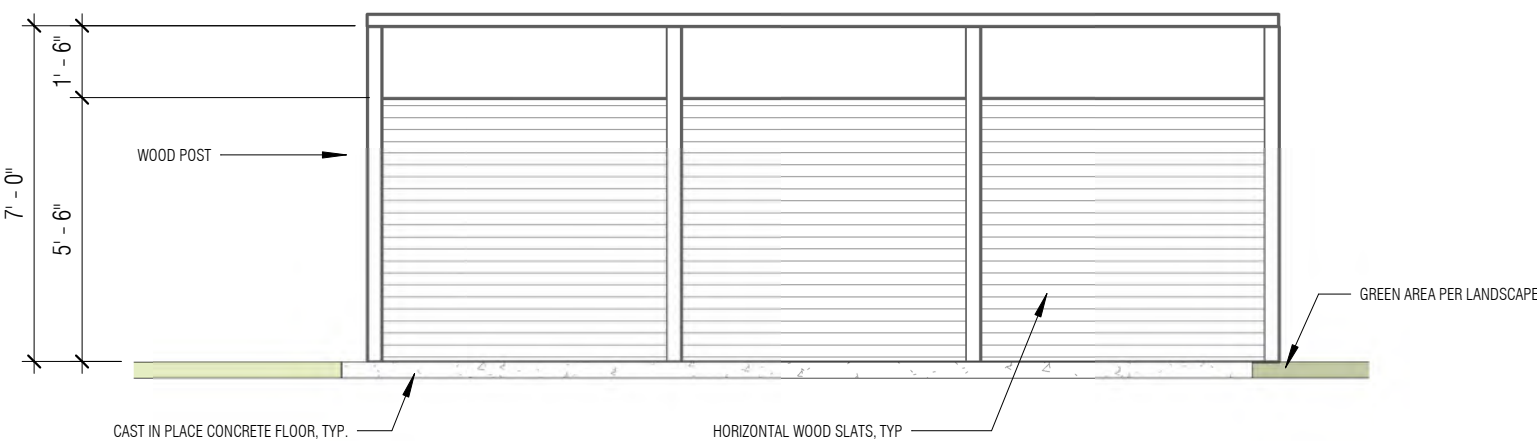



3 **CONSOLIDATED GARBAGE/RECYCLING ENCLOSURE #1 - E ELEVATION**
1/4" = 1'-0"

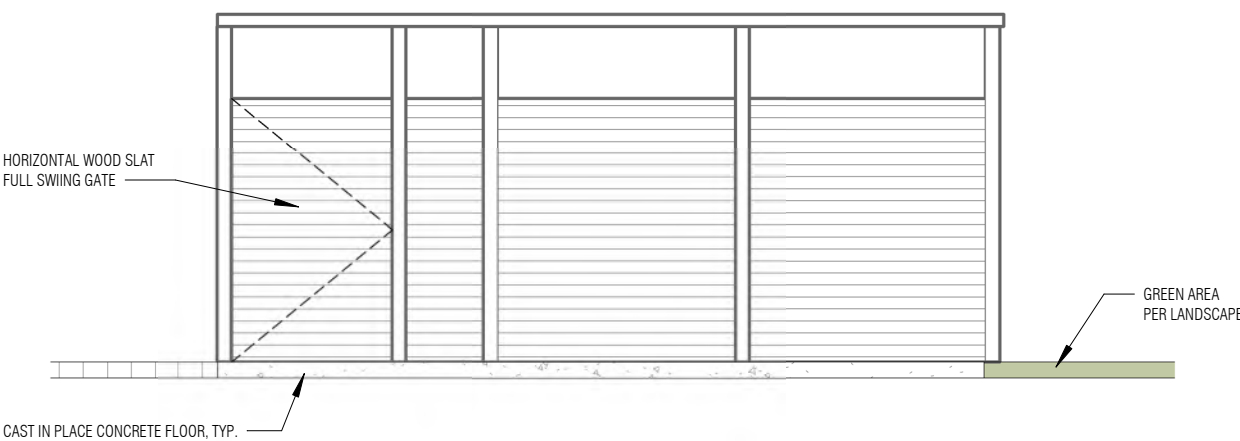

4 **CONSOLIDATED GARBAGE/RECYCLING ENCLOSURE #1 - S ELEVATION**
1/4" = 1'-0"

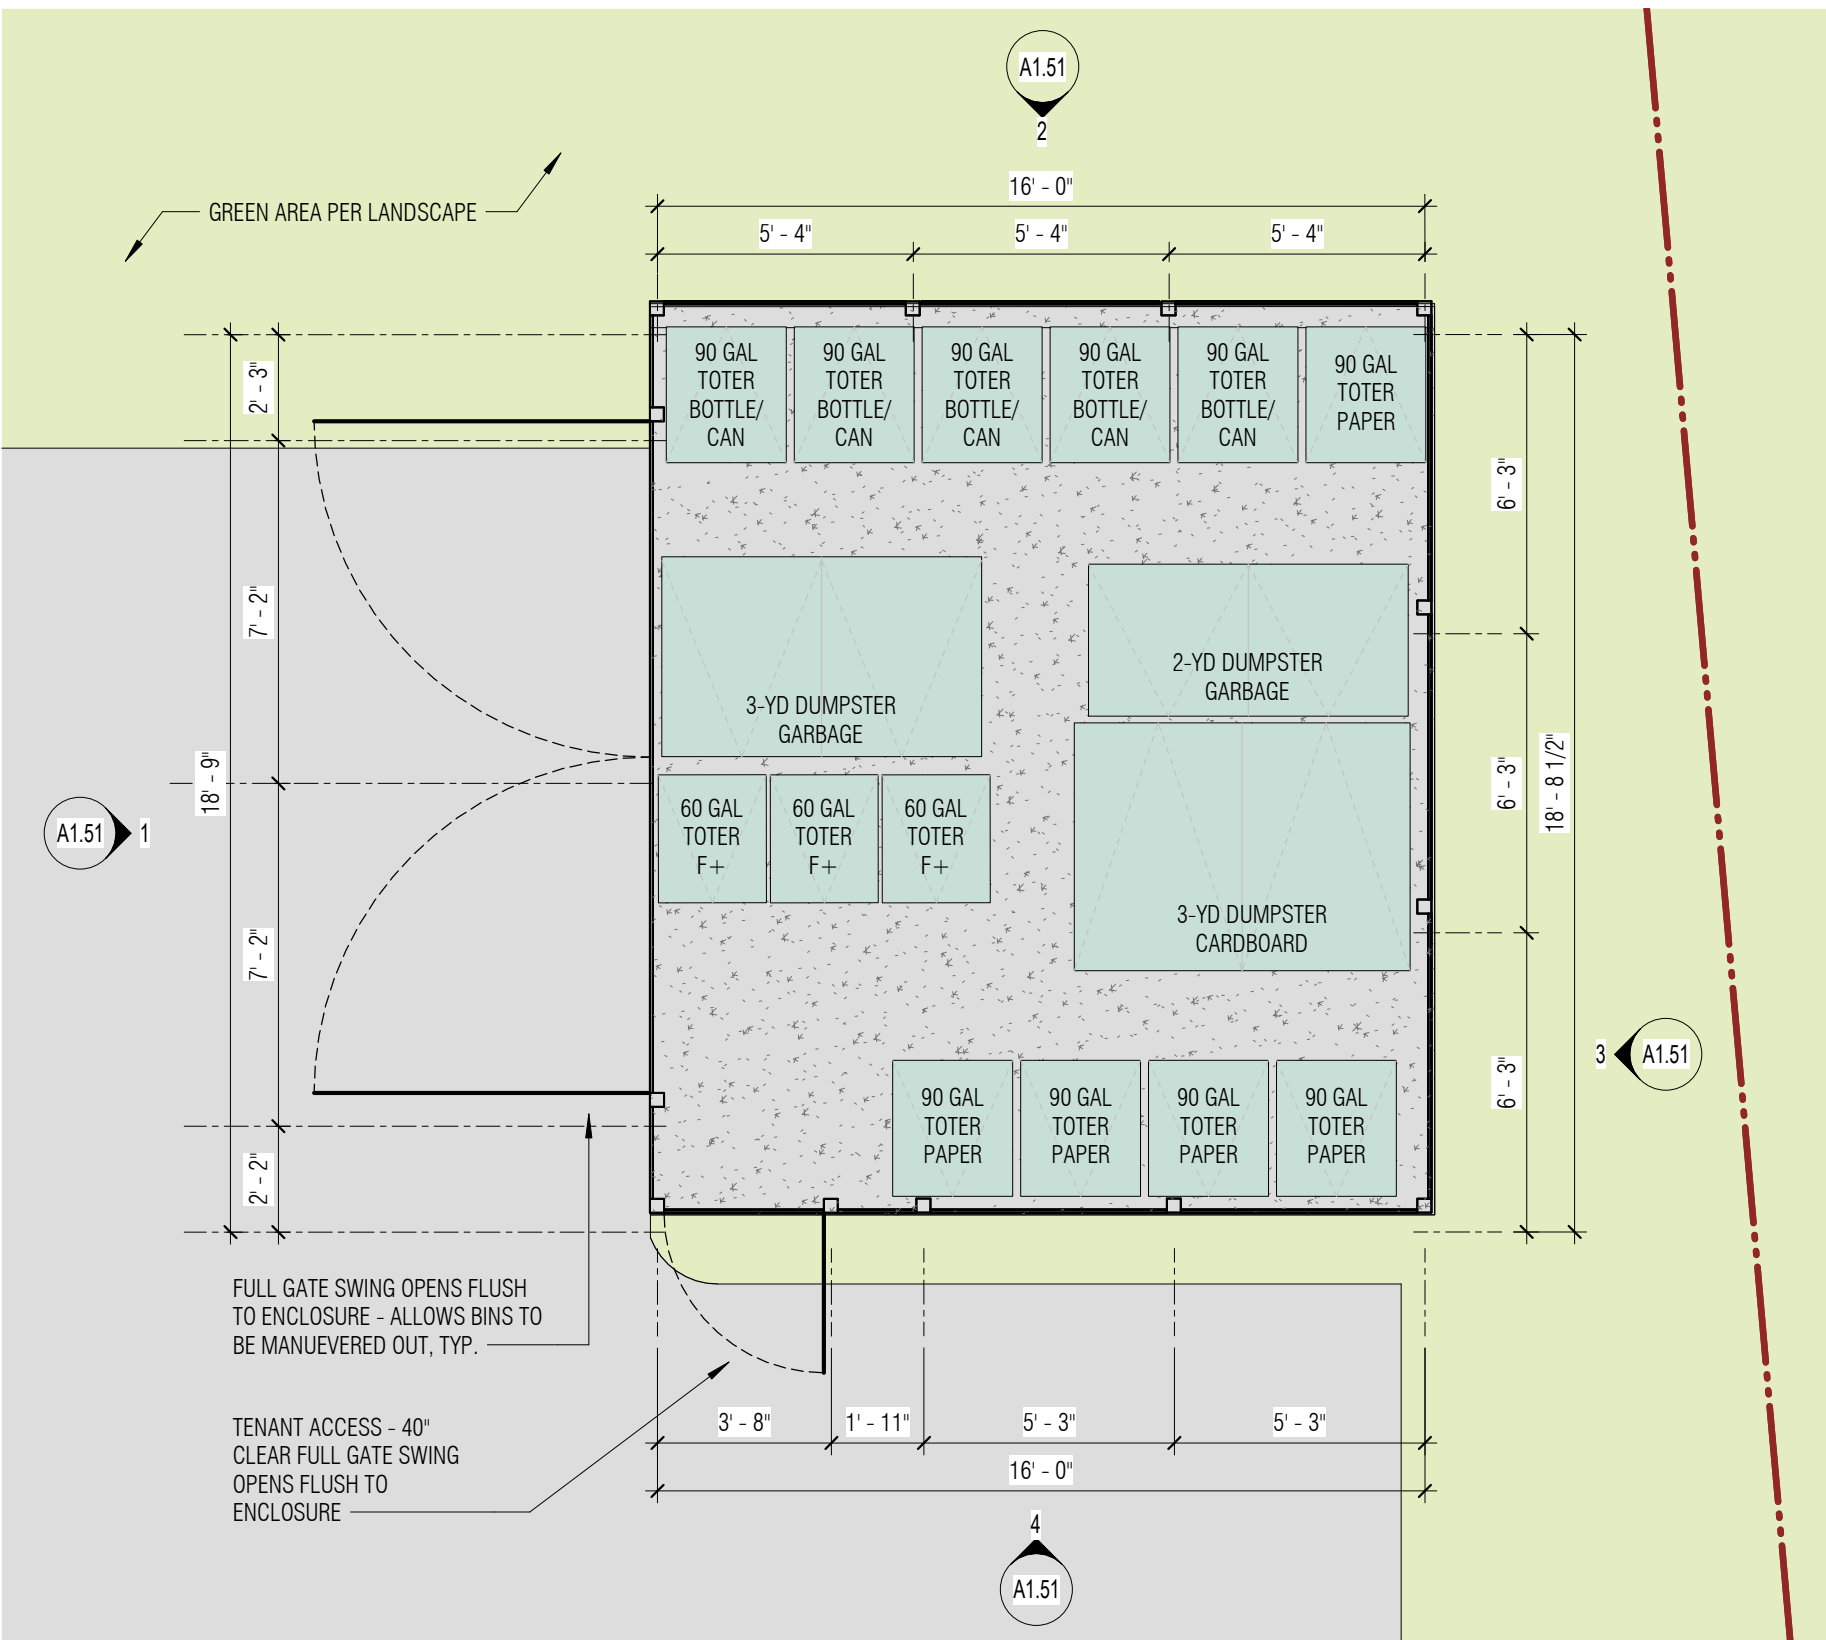


5 **CONSOLIDATED GARBAGE/RECYCLING ENCLOSURE #1**
1/4" = 1'-0"

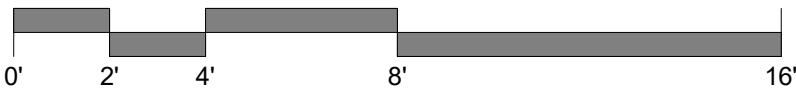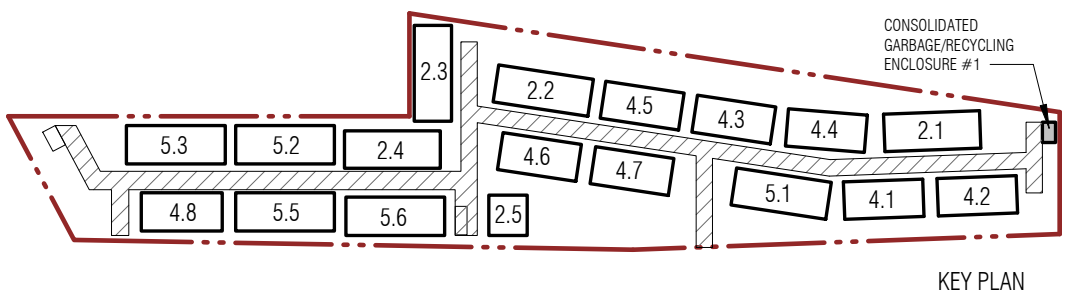


SOLID WASTE ENCLOSURE			
LOCATION	CAPACITY	BUILDING	NO. OF UNITS
CONSOLIDATED GARBAGE/RECYCLING ENCLOSURE #1	2-YD GARBAGE 3-YD GARBAGE 4-YD CARDBOARD 5 90 GAL PAPER 5 90 GAL BOTTLE / CAN 3 60 GAL F+	2.1, 4.1, 4.2, 4.3, 4.4, 5.1	23
CONSOLIDATED GARBAGE/RECYCLING ENCLOSURE #2	4-YD GARBAGE 4-YD CARDBOARD 4 90 GAL PAPER 4 90 GAL BOTTLE / CAN 3 60 GAL F+	2.2, 2.3, 2.5, 4.5, 4.6, 4.7	18
CONSOLIDATED GARBAGE/RECYCLING ENCLOSURE #3	3-YD GARBAGE 3-YD GARBAGE 3-YD CARDBOARD 6 90 GAL PAPER 6 90 GAL BOTTLE / CAN 4 60 GAL F+	2.4, 5.2, 5.3, 5.4, 5.5, 5.6	27
			68 (TOTAL)


NOTE:
REFER TO SITE PLAN A1.11 FOR BUILDING NUMBER DESIGNATION.

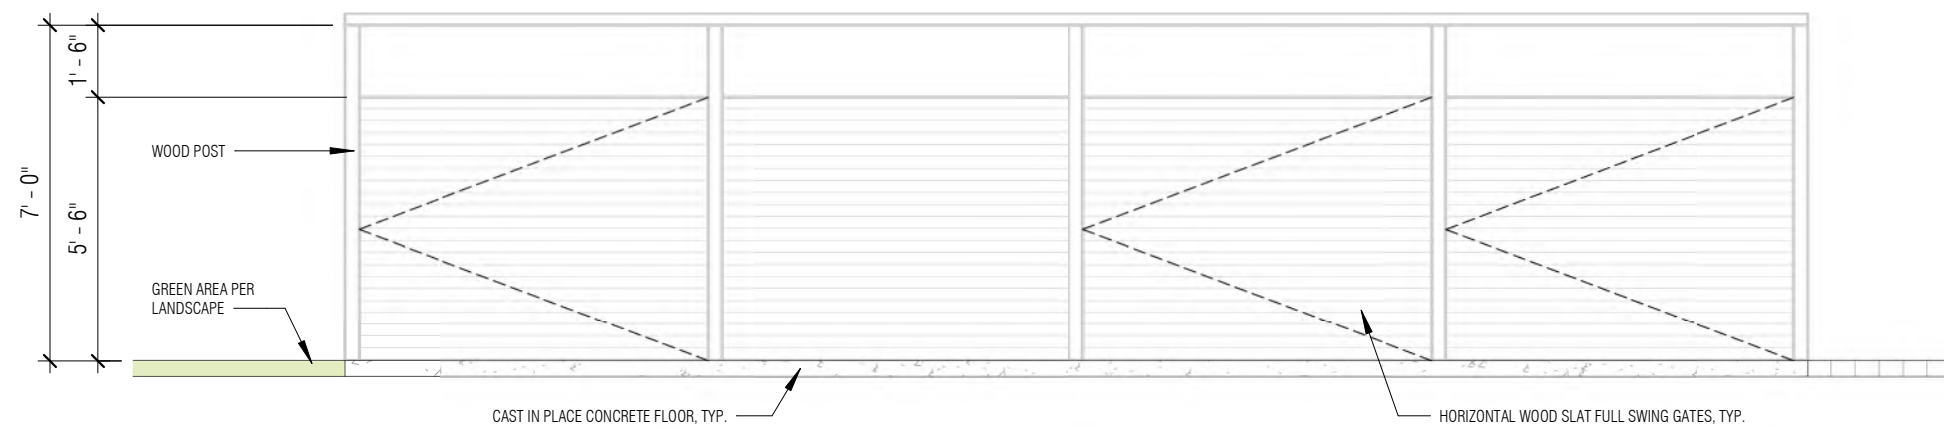


1 **CONSOLIDATED GARBAGE/RECYCLING ENCLOSURE #2 - E ELEVATION**
1/4" = 1'-0"

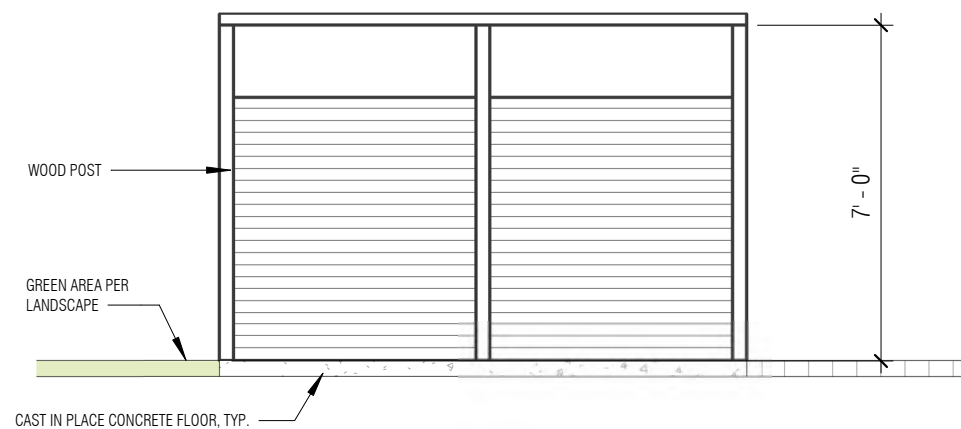


2 **CONSOLIDATED GARBAGE/RECYCLING ENCLOSURE #2 - S ELEVATION**
1/4" = 1'-0"

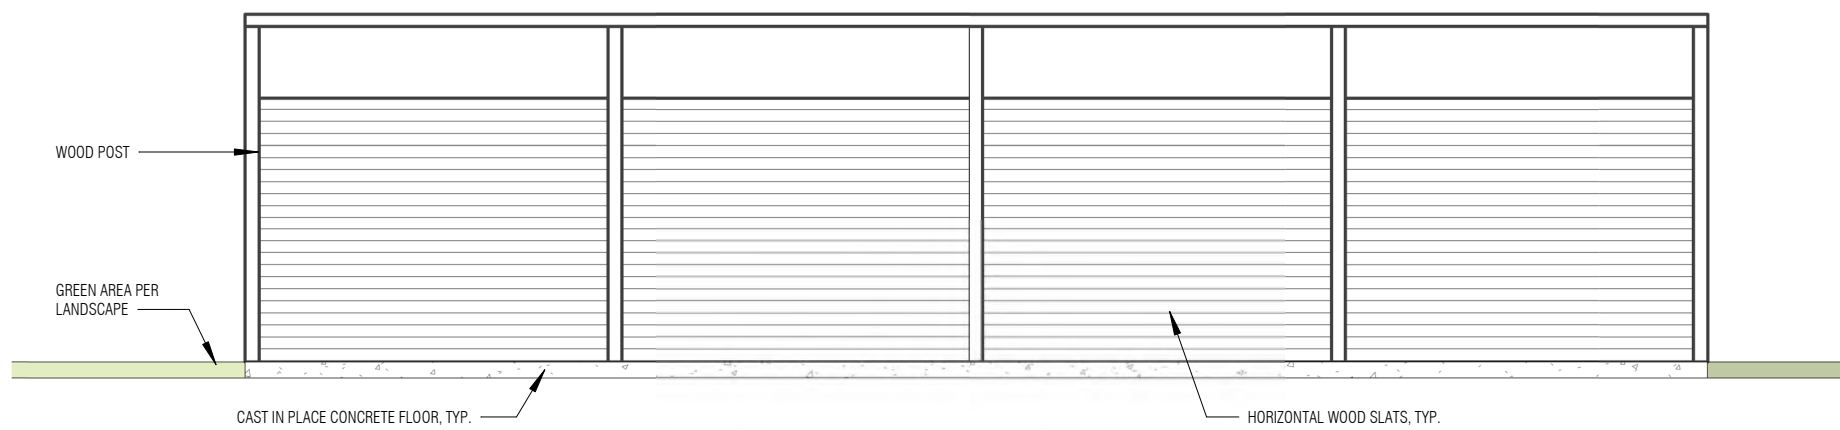


3 **CONSOLIDATED GARBAGE/RECYCLING ENCLOSURE #2 - W ELEVATION**
1/4" = 1'-0"

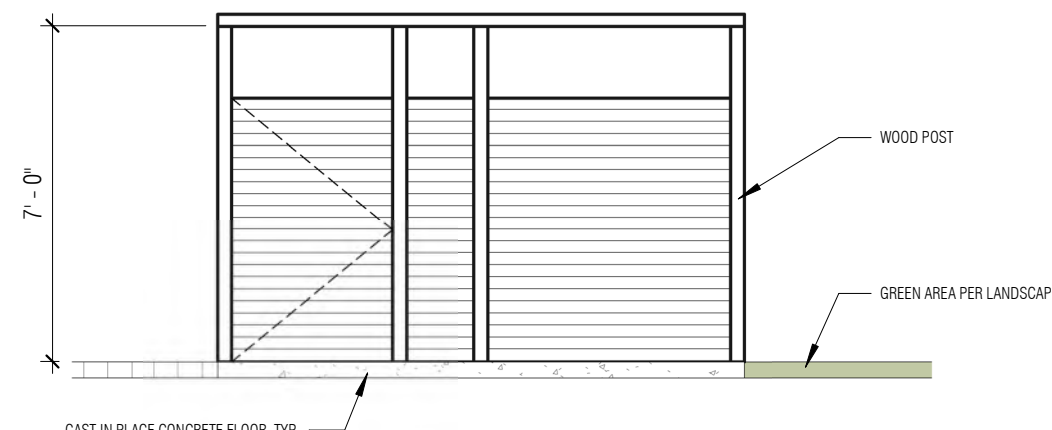

4 **CONSOLIDATED GARBAGE/RECYCLING ENCLOSURE #2 - N ELEVATION**
1/4" = 1'-0"

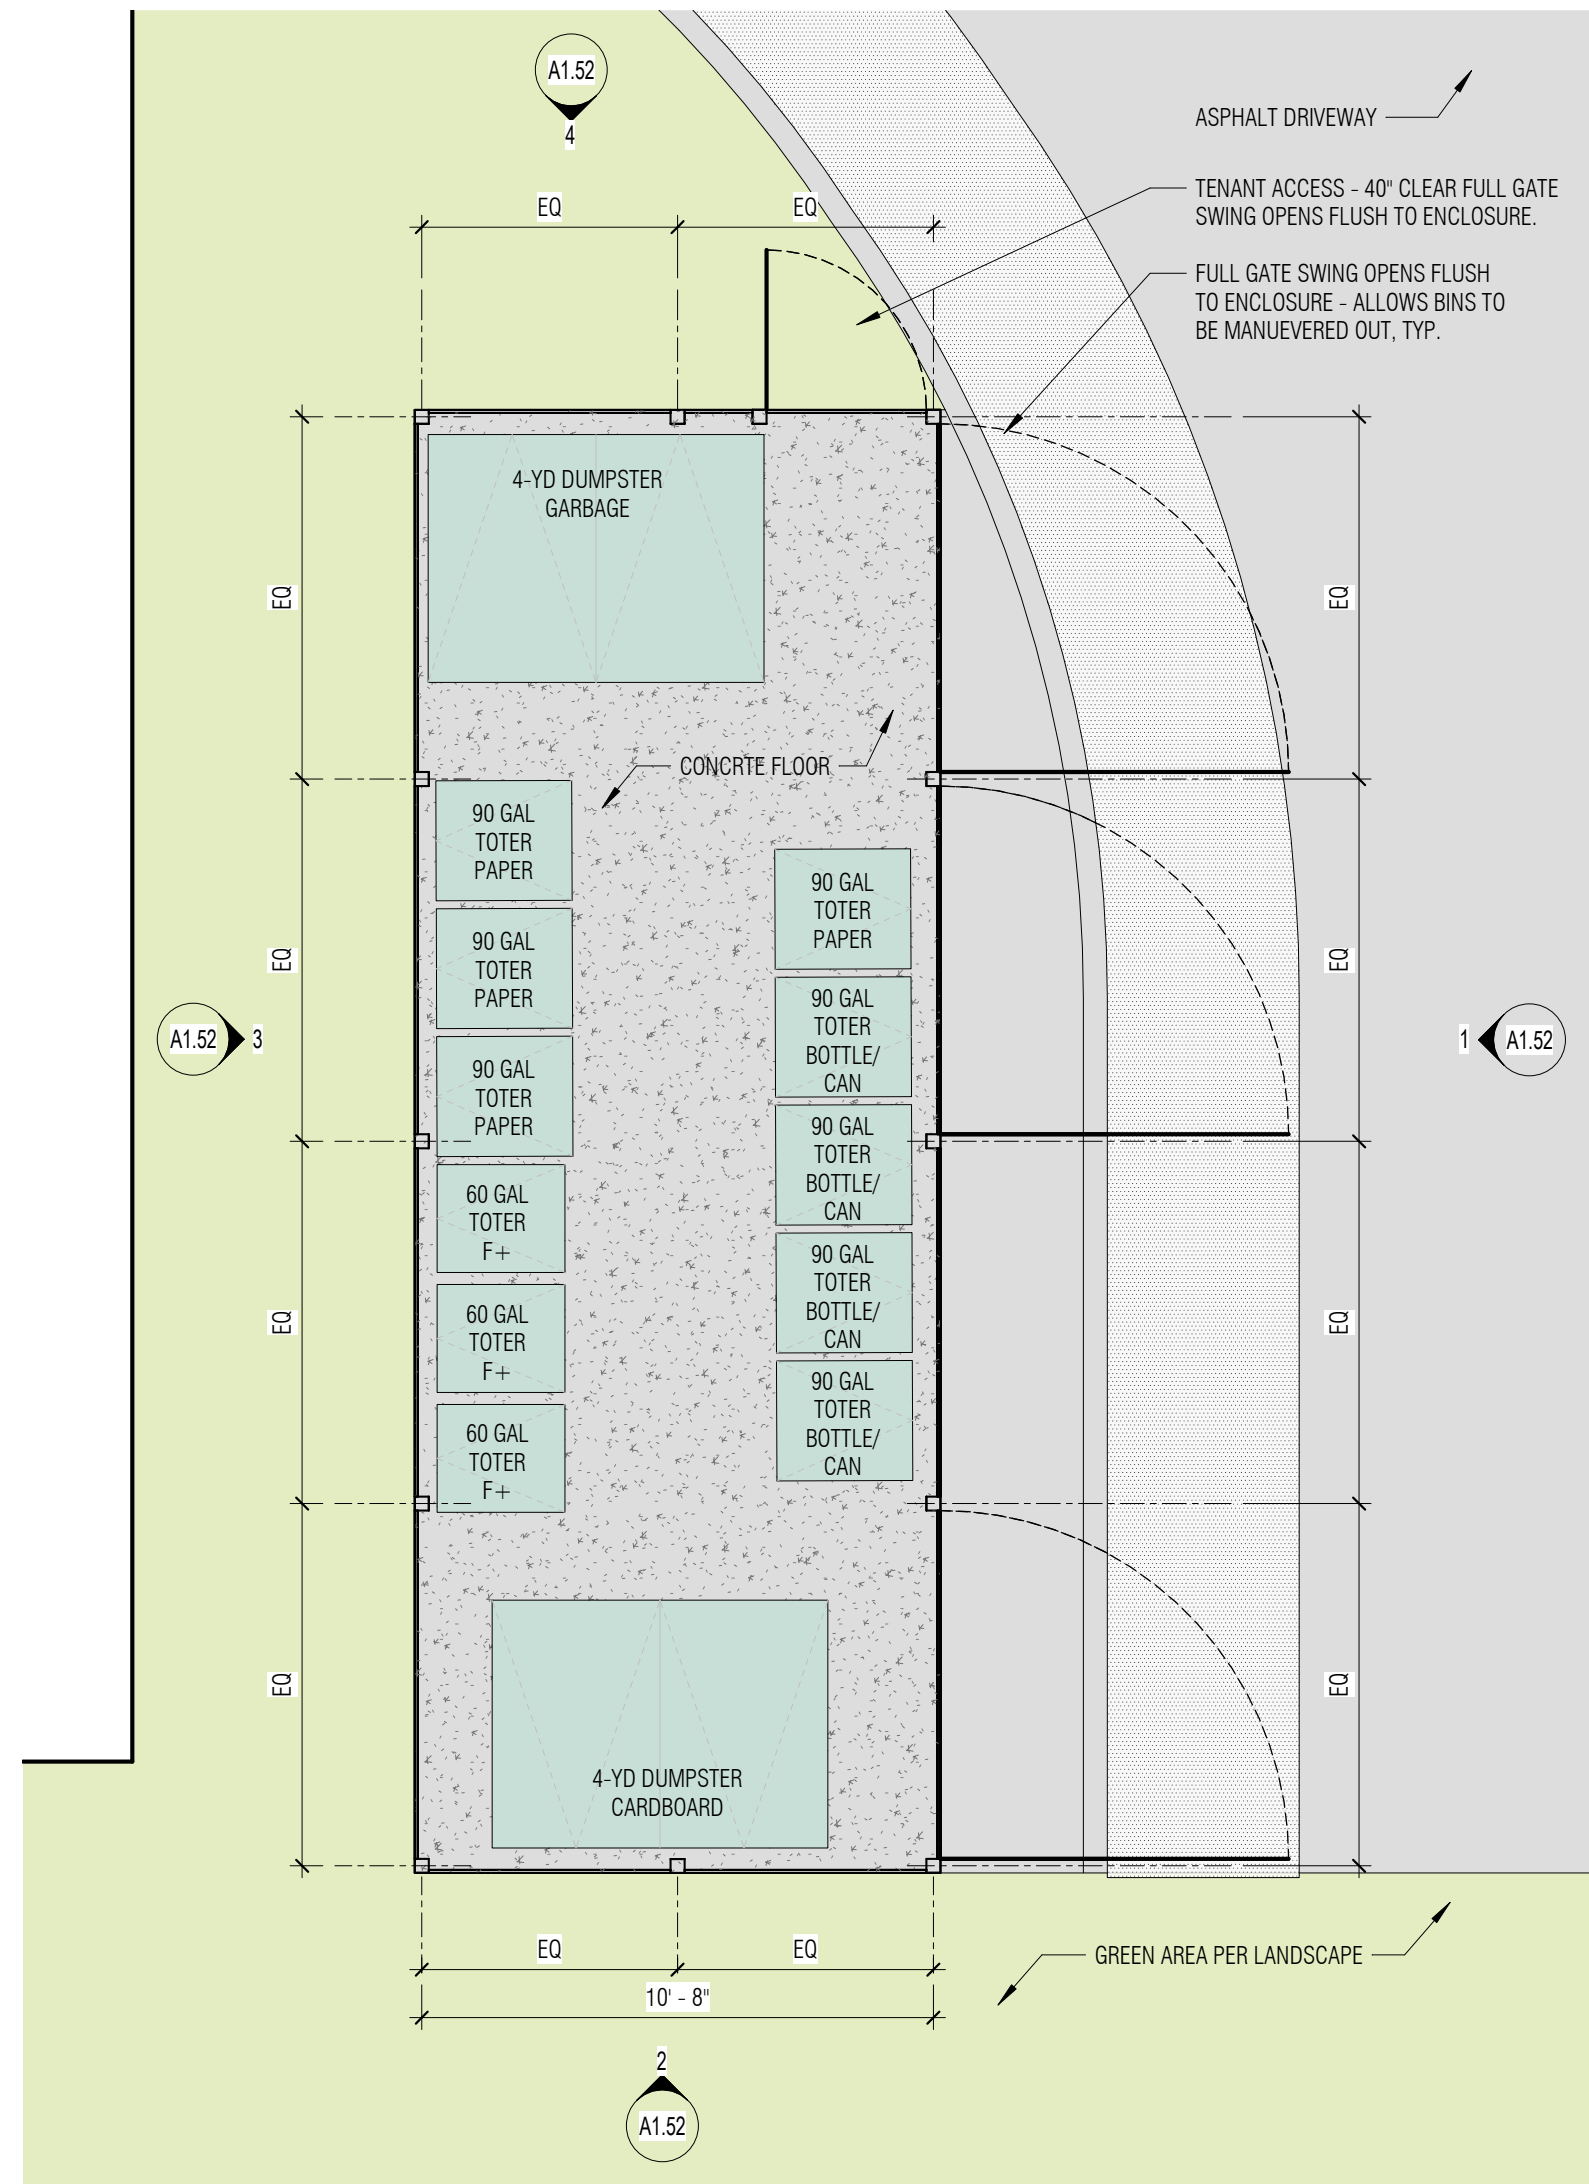


5 **CONSOLIDATED GARBAGE/RECYCLING ENCLOSURE #2**
1/4" = 1'-0"

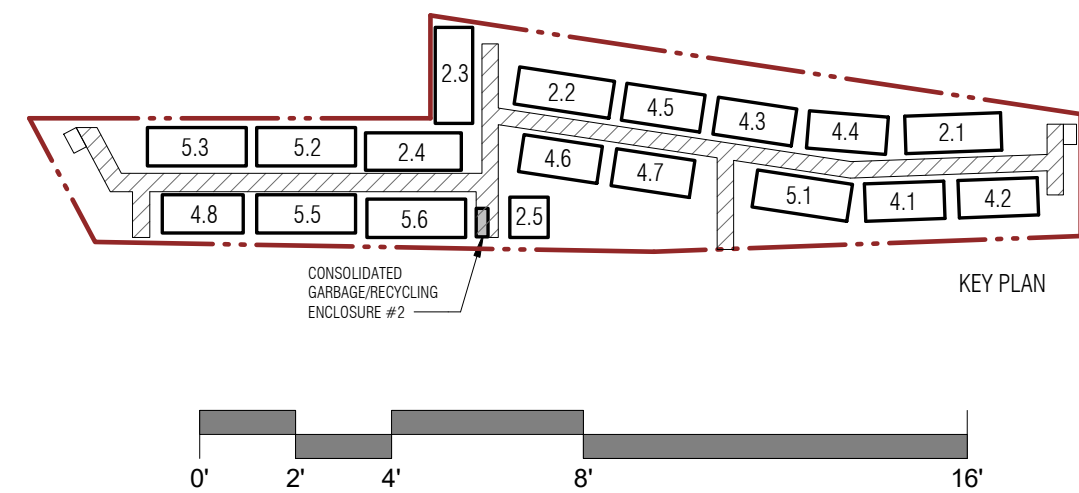


SOLID WASTE ENCLOSURE			
LOCATION	CAPACITY	BUILDING	NO. OF UNITS
CONSOLIDATED GARBAGE/RECYCLING ENCLOSURE #1	2-YD GARBAGE	2.1, 4.1, 4.2, 4.3, 4.4, 5.1	23
	3-YD GARBAGE		
	4-YD CARDBOARD		
	5 90 GAL PAPER		
	5 90 GAL BOTTLE / CAN		
	3 60 GAL F+		
CONSOLIDATED GARBAGE/RECYCLING ENCLOSURE #2	4-YD GARBAGE	2.2, 2.3, 2.5, 4.5, 4.6, 4.7	18
	4-YD CARDBOARD		
	4 90 GAL PAPER		
	4 90 GAL BOTTLE / CAN		
	3 60 GAL F+		
CONSOLIDATED GARBAGE/RECYCLING ENCLOSURE #3	3-YD GARBAGE	2.4, 5.2, 5.3, 5.4, 5.5, 5.6	27
	3-YD GARBAGE		
	3-YD CARDBOARD		
	6 90 GAL PAPER		
	6 90 GAL BOTTLE / CAN		
	4 60 GAL F+		


NOTE:
REFER TO SITE PLAN A1.11 FOR BUILDING NUMBER DESIGNATION.

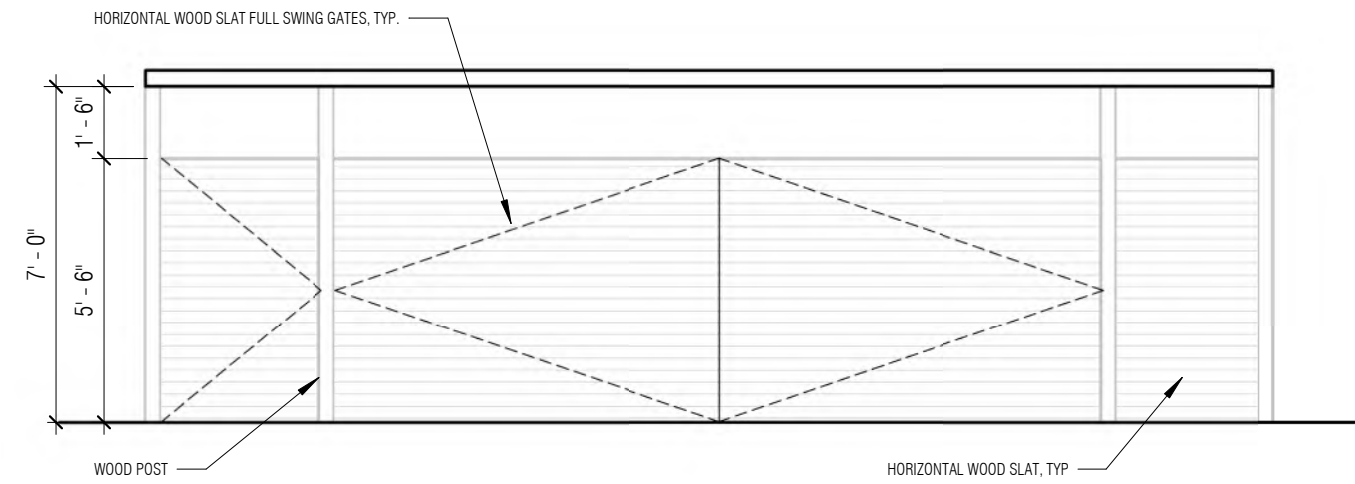


1 CONSOLIDATED GARBAGE/RECYCLING ENCLOSURE #3 - NE ELEVATION
1/4" = 1'-0"

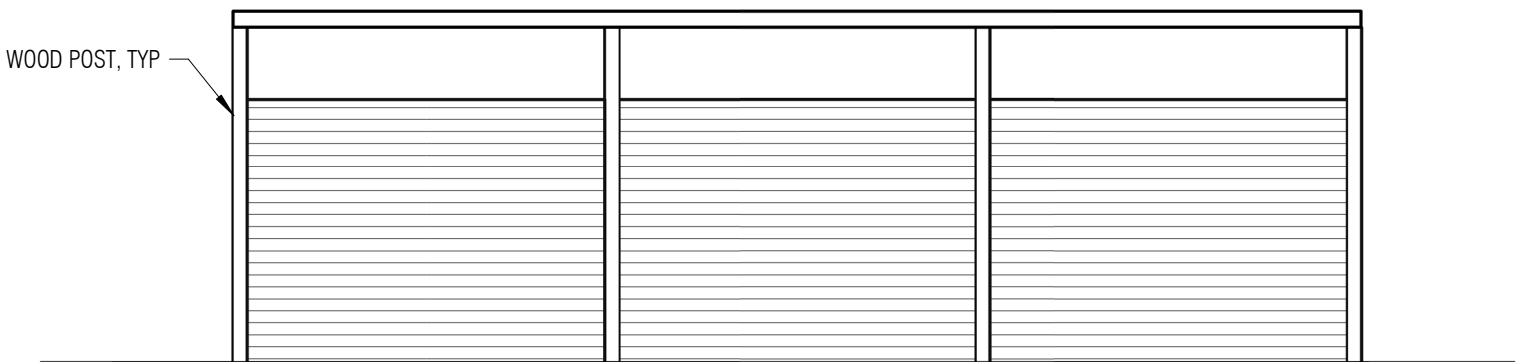

3 CONSOLIDATED GARBAGE/RECYCLING ENCLOSURE #3 - W ELEVATION
1/4" = 1'-0"

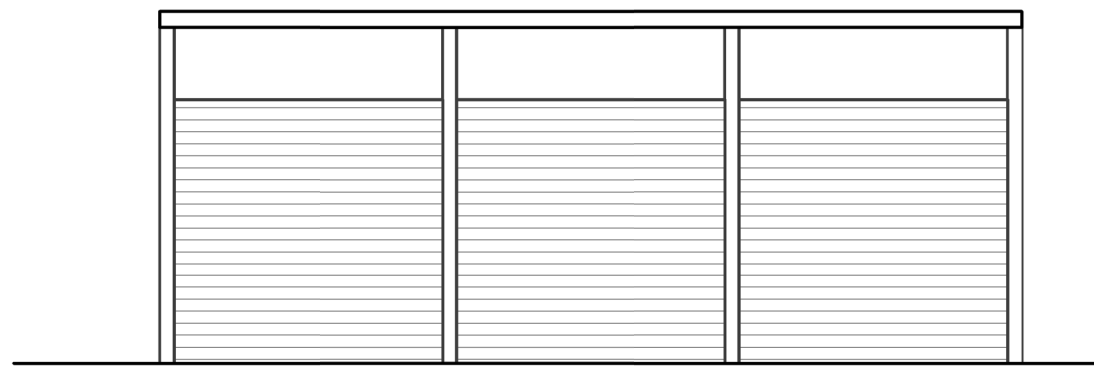

2 CONSOLIDATED GARBAGE/RECYCLING ENCLOSURE #3 - E ELEVATION
1/4" = 1'-0"

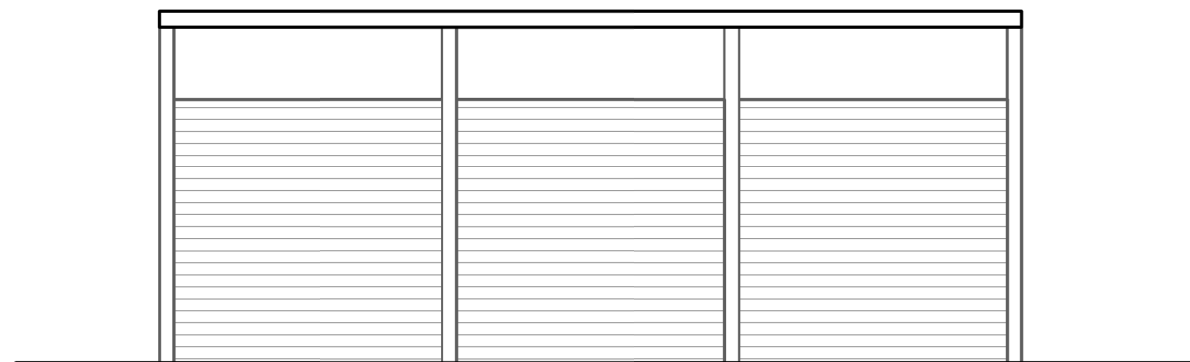


4 CONSOLIDATED GARBAGE/RECYCLING ENCLOSURE #3- N ELEVATION
1/4" = 1'-0"



SOLID WASTE ENCLOSURE			
LOCATION	CAPACITY	BUILDING	NO. OF UNITS
CONSOLIDATED GARBAGE/RECYCLING ENCLOSURE #1	2-YD GARBAGE 3-YD GARBAGE 4-YD CARDBOARD 5 90 GAL PAPER 5 90 GAL BOTTLE / CAN 3 60 GAL F+	2.1, 4.1, 4.2, 4.3, 4.4, 5.1	23
CONSOLIDATED GARBAGE/RECYCLING ENCLOSURE #2	4-YD GARBAGE 4-YD CARDBOARD 4 90 GAL PAPER 4 90 GAL BOTTLE / CAN 3 60 GAL F+	2.2, 2.3, 2.5, 4.5, 4.6, 4.7	18
CONSOLIDATED GARBAGE/RECYCLING ENCLOSURE #3	3-YD GARBAGE 3-YD GARBAGE 3-YD CARDBOARD 6 90 GAL PAPER 6 90 GAL BOTTLE / CAN 4 60 GAL F+	2.4, 5.2, 5.3, 5.4, 5.5, 5.6	27

68 (TOTAL)

NOTE:
REFER TO SITE PLAN A1.11 FOR BUILDING NUMBER DESIGNATION.

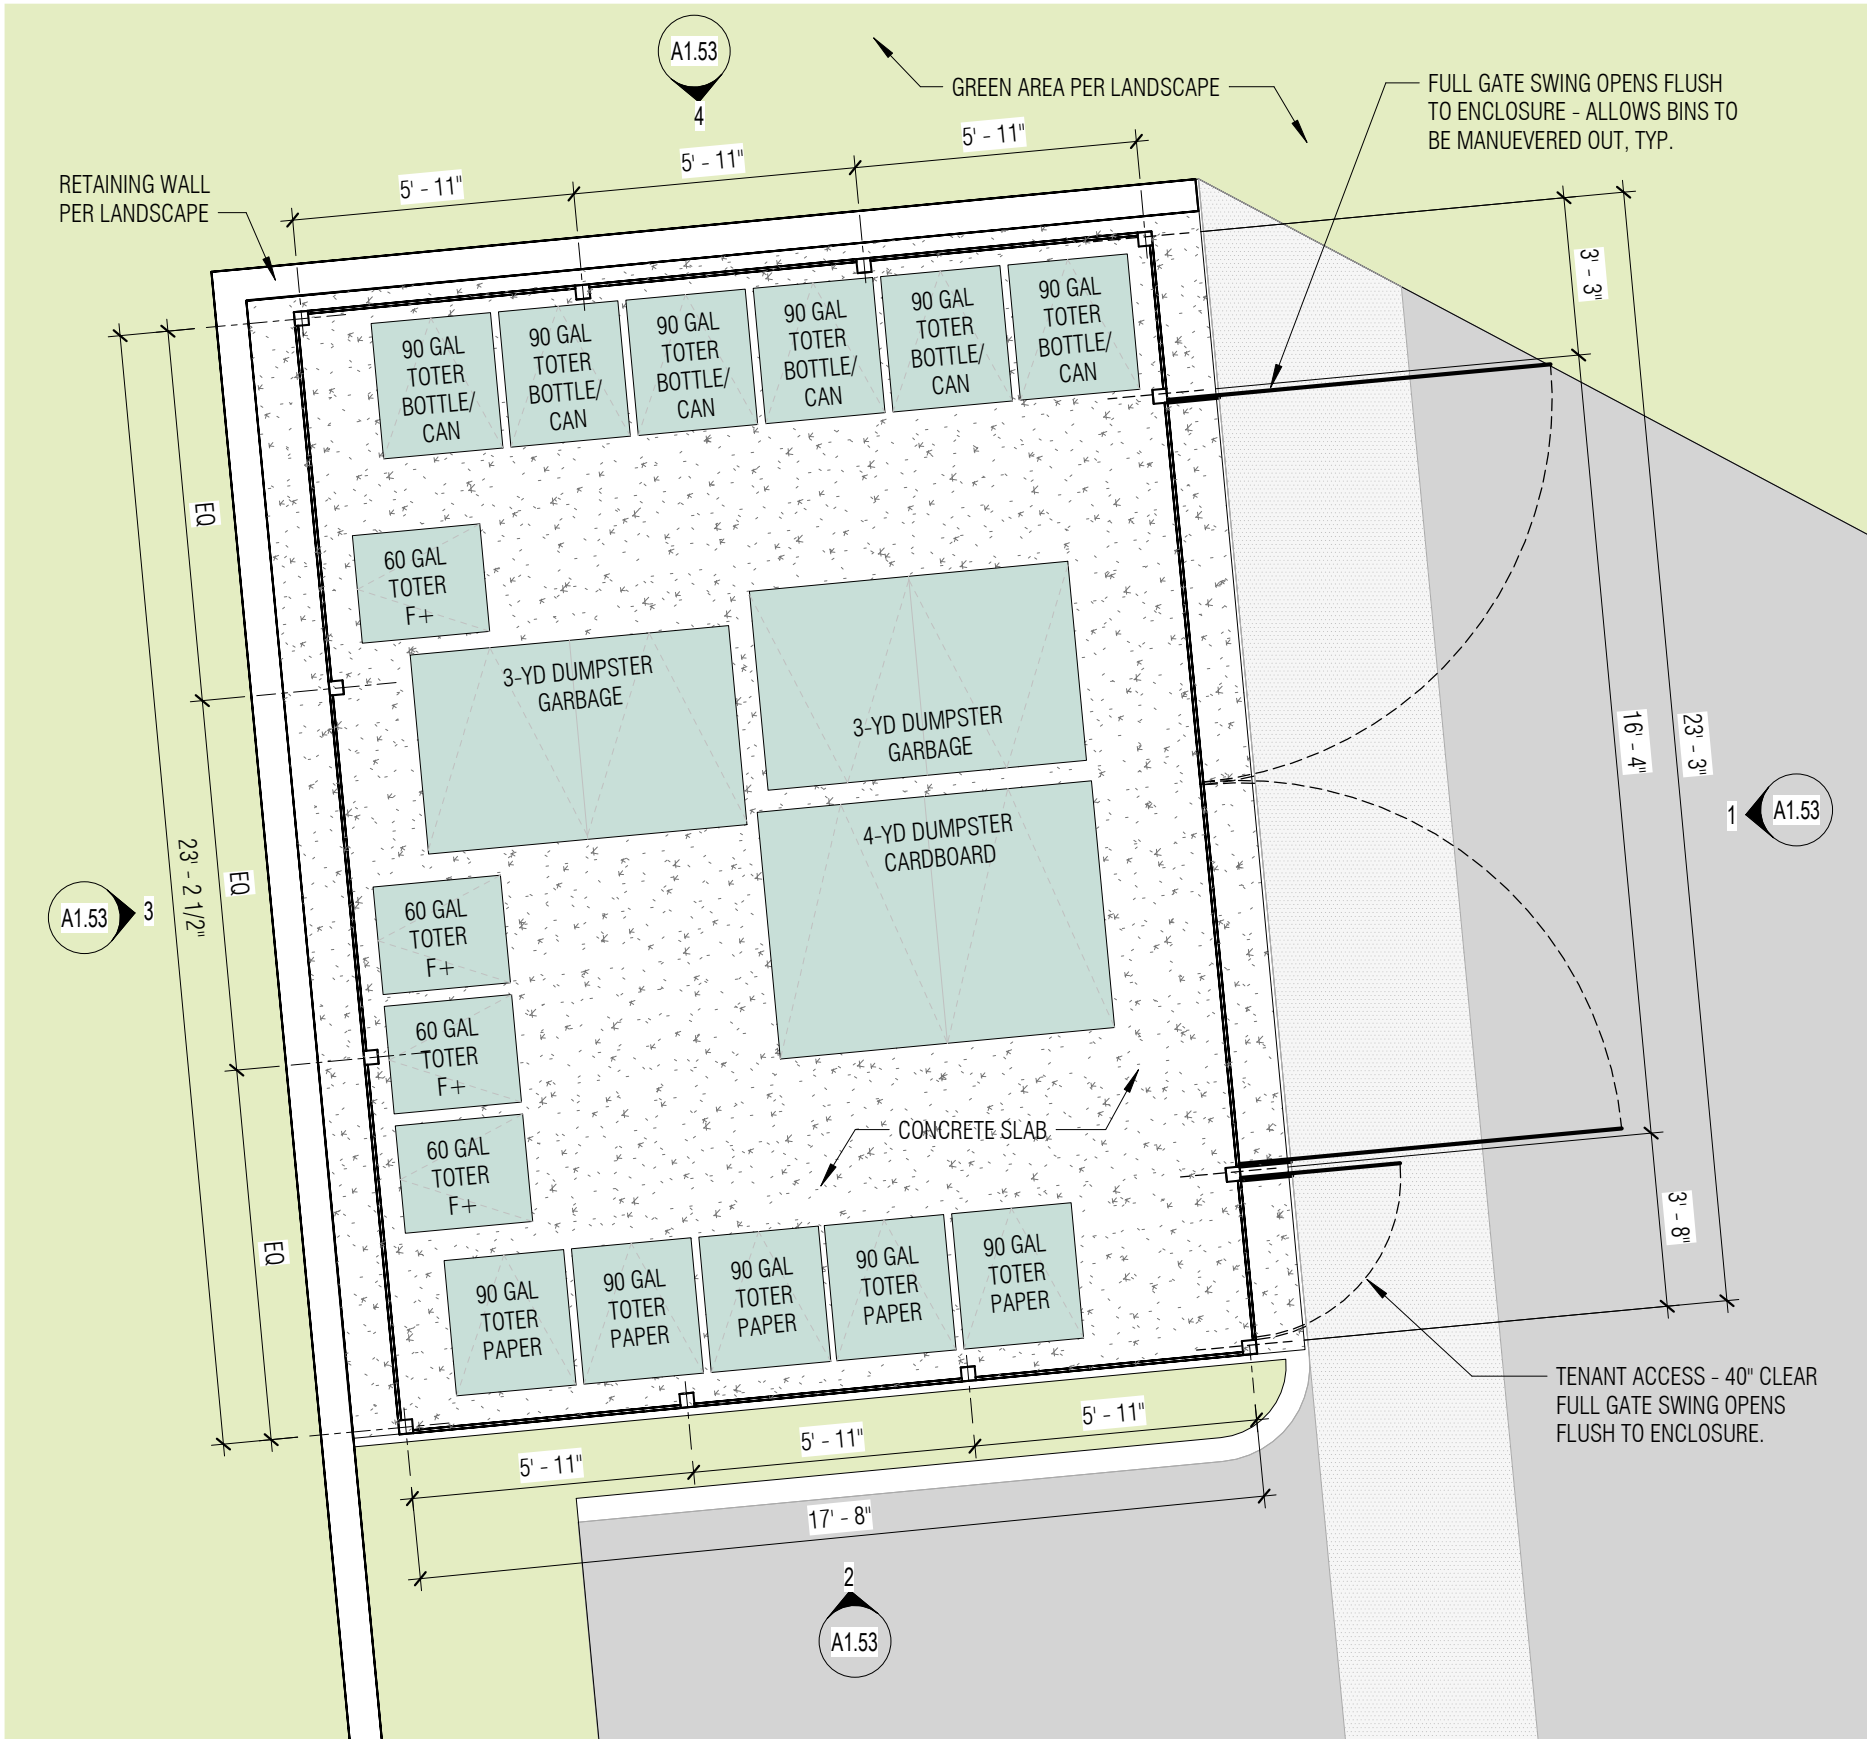

5 CONSOLIDATED GARBAGE/RECYCLING ENCLOSURE #3
1/4" = 1'-0"

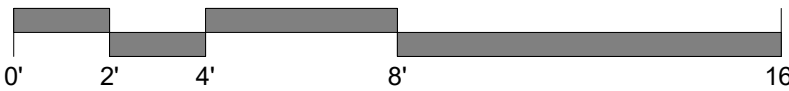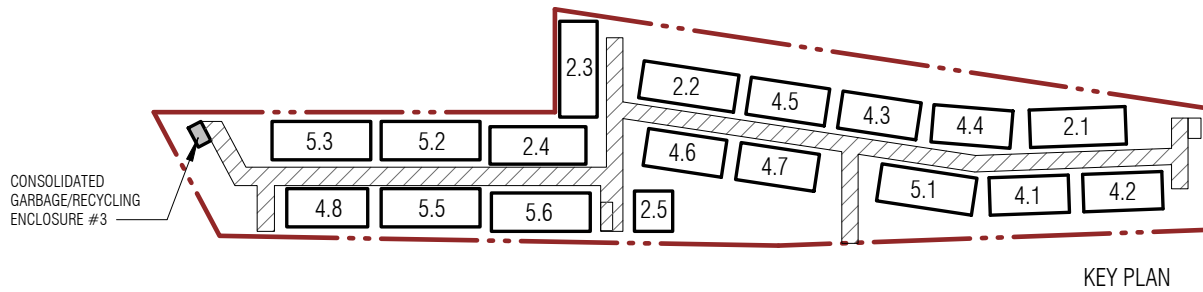



1. ALL INTERIOR WALLS ARE 10 UNO. PROVIDE 3'-1/2" SOUND INSULATION IN COMMON PARTY WALLS.
2. ALL EXTERIOR WALLS ARE E 1 UNO.
3. ALL EXTERIOR DIMENSIONS ARE MEASURED FROM GRID LINE TO GRID LINE OR FACE OF FRAMING. ALL INTERIOR DIMENSIONS ARE FROM FACE OF STUD.
4. GRIDS ARE ALIGNED WITH THE EXTERIOR FACE OF FRAMING AT EXTERIOR WALLS AND ALIGNED WITH THE CENTER OF THE PARTY-WALLS.
5. DIMENSIONS AT POSTS ARE TO CENTERLINES UNO - VERIFY ALL STRUCTURAL LOCATIONS WITH FRAMING PLANS
6. WINDOW DIMENSIONS ARE GIVEN AS NOMINAL MEASUREMENTS.
7. DOOR HINGED OPENING ARE 4" OFF STUD FACE OF HINGED WALL TO (HINGED SIDE OF THE DOOR) UNO
8. ALL FINISH FLOOR MATERIALS TO ALIGN WITH ADJACENT FLOOR FINISH
9. SEE GENERAL SHEETS FOR CODE, DIMENSIONING AND GENERAL NOTES
10. SEE SHEETS A5.11 TO A5.14 FOR ENLARGED 1/4" = 1'-0" PLANS

WALL


CONC. WALL

1-HR RATED WALL

1-HR RATED FLOOR OR ROOF AREA

STRIP VENT

SOLAR READY ZONE

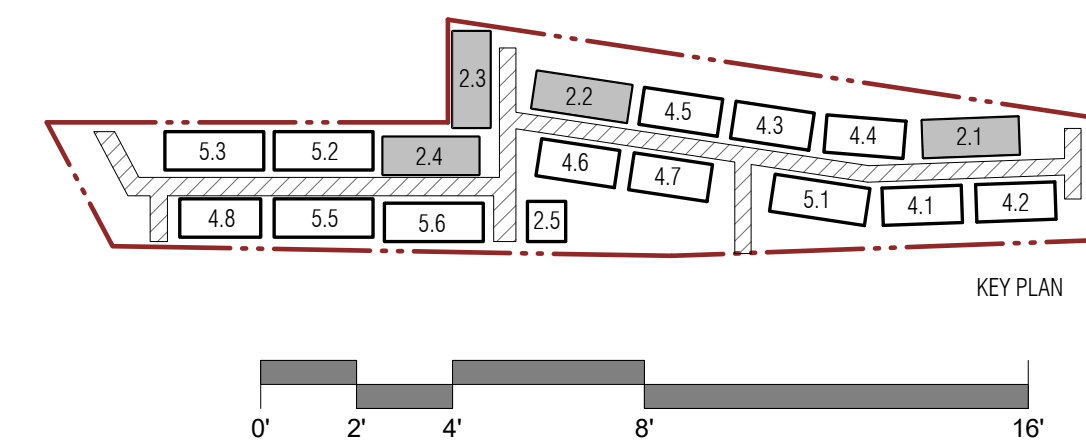

CITY OF BELLINGHAM STAMP AREA

PROJECT ADDRESS: 3509 MERIDIAN STREET, BELLINGHAM, WA 98225

OWNER:
STREAM REAL ESTATE

REVISION	DATE	DESCRIPTION
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ISSUANCES

DATE	DESCRIPTION
12/29/2022	LAND USE APPLICATION
1/13/2023	LAND USE APP RESUBMITTAL
1/14/2023	LAND USE APP RESUBMITTAL

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 ORIGINAL SHEET SIZE IS 24"x36"


DARD & VELLUM PROJECT #: 2021170.00
JOB PROJECT #: 2021-0105

LOT DATE: 04.12.2023


LOOR PLANS - FDN & FIRST
LOOR - 2-PACK TH "C-C"
UNITS

SHEET NO.:


A2.10

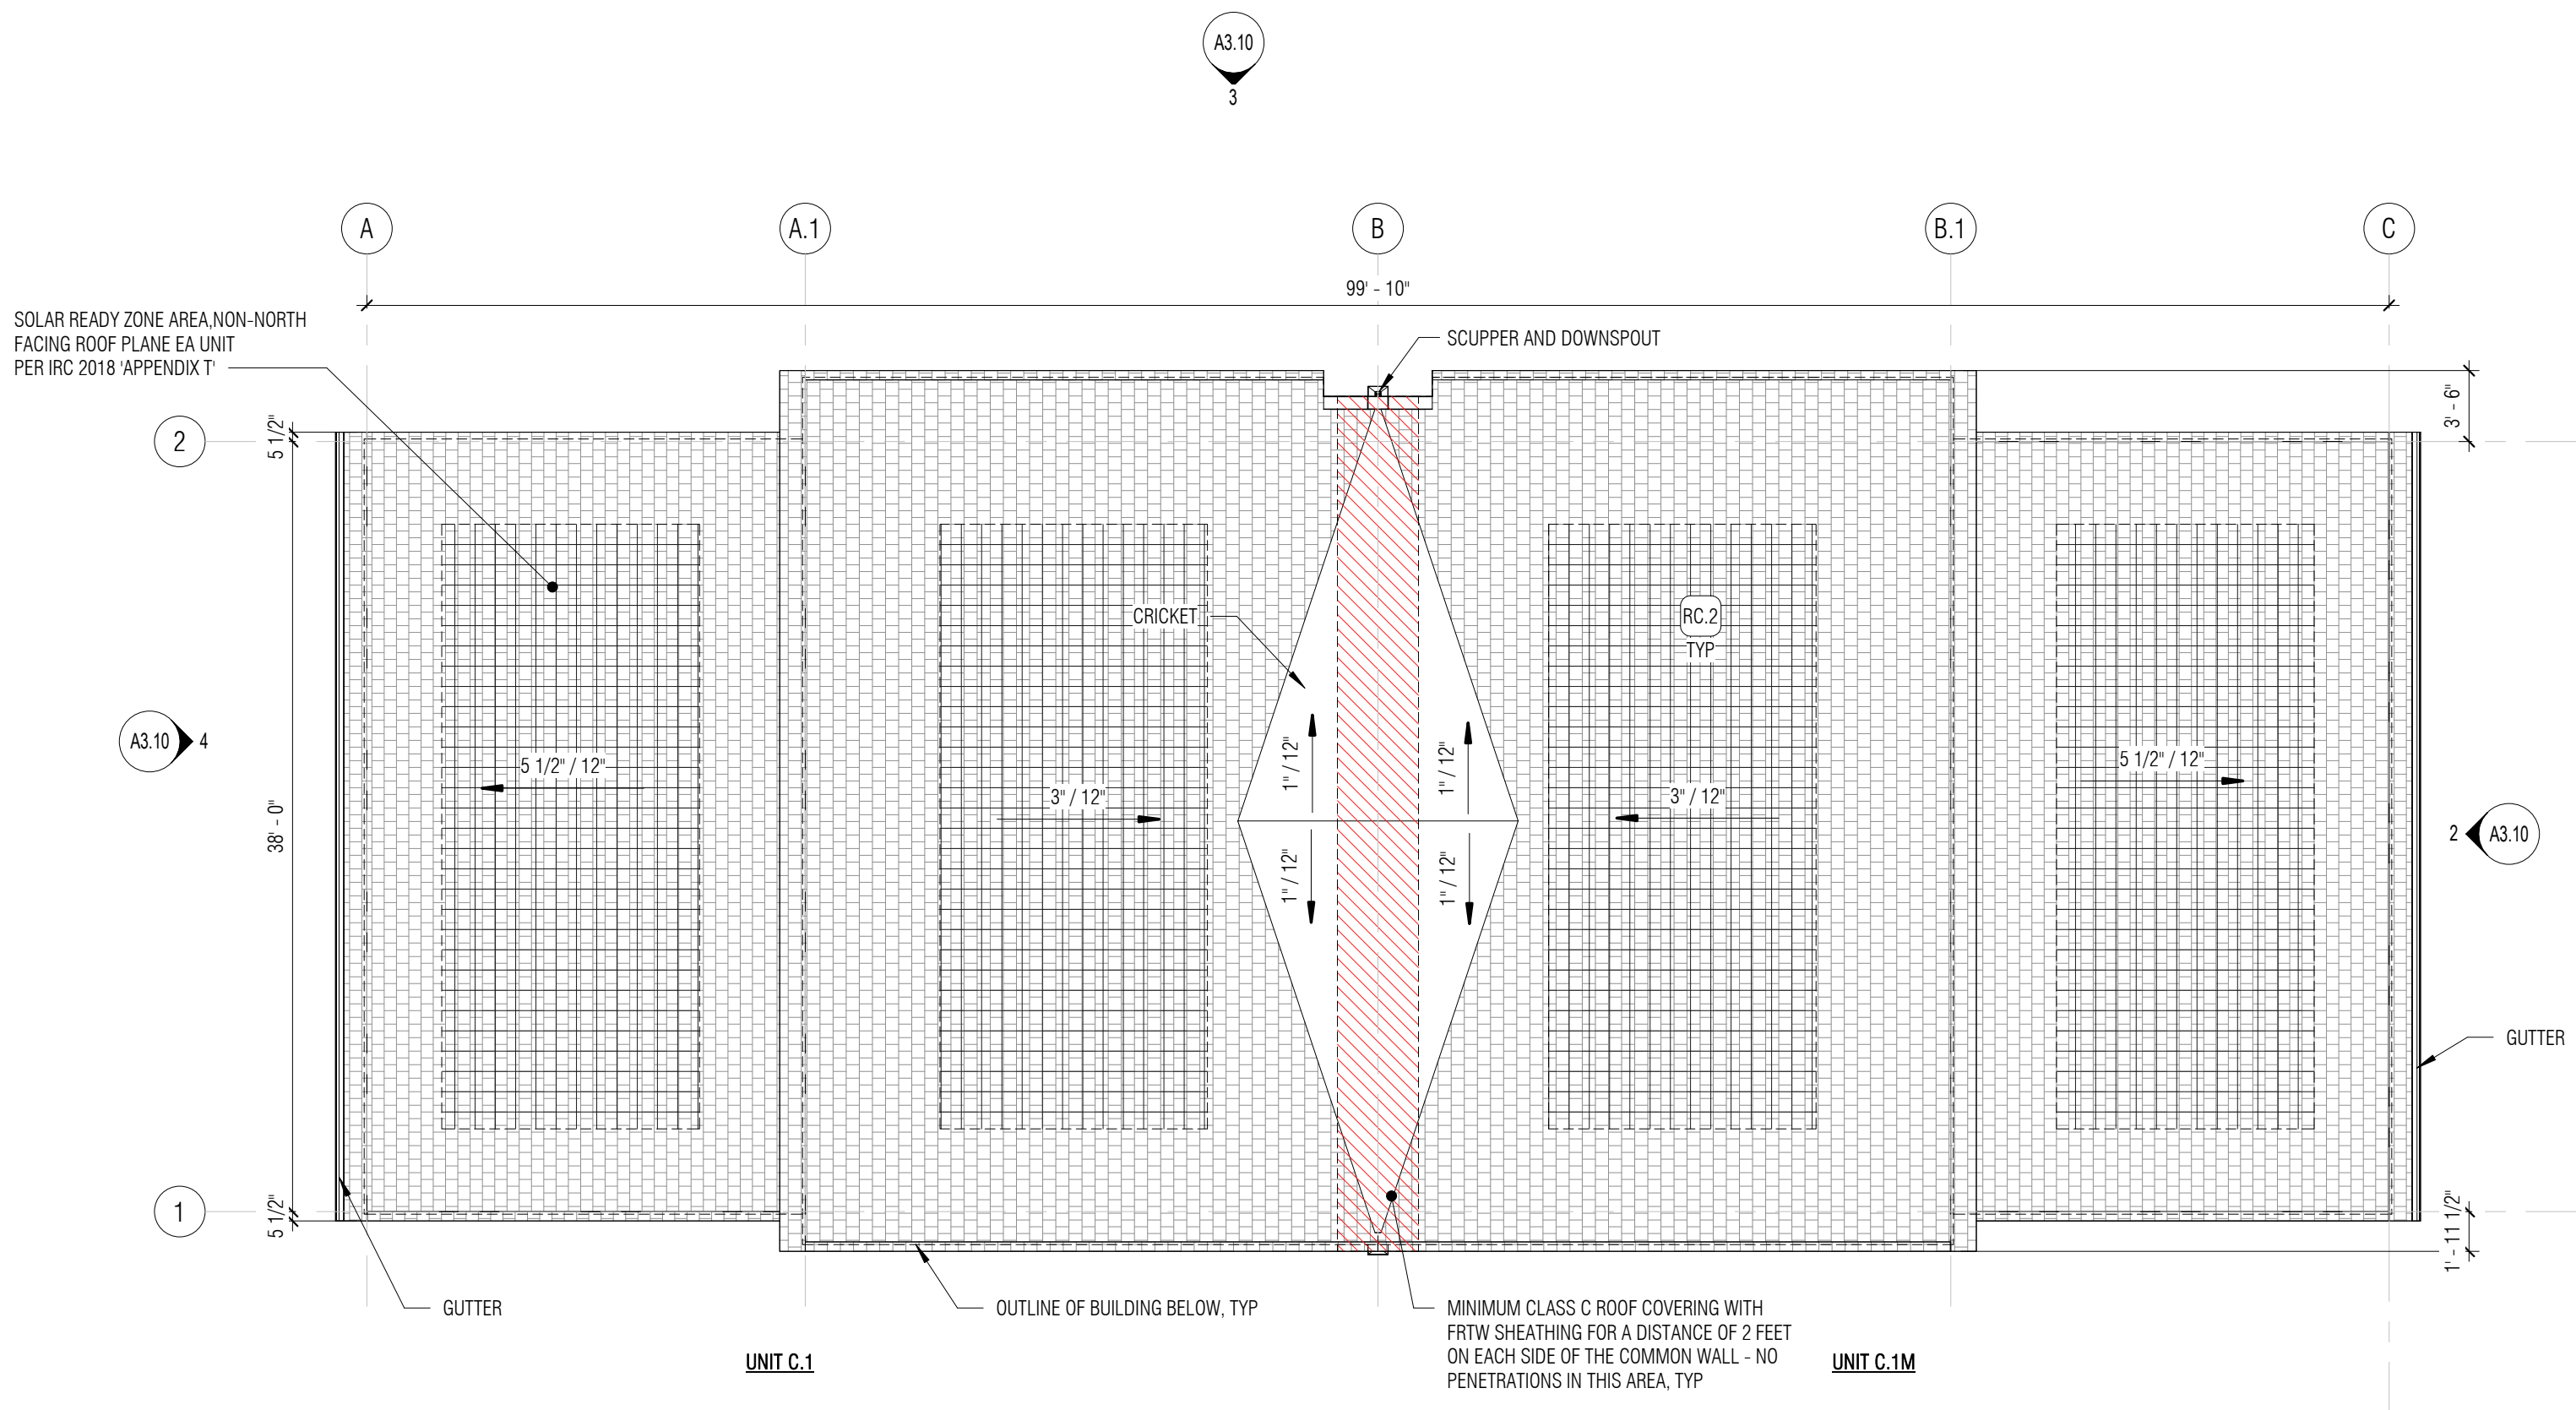


2 2-PACK TOWNHOUSE (C-C) ROOF PLAN
1/8" = 1'-0"

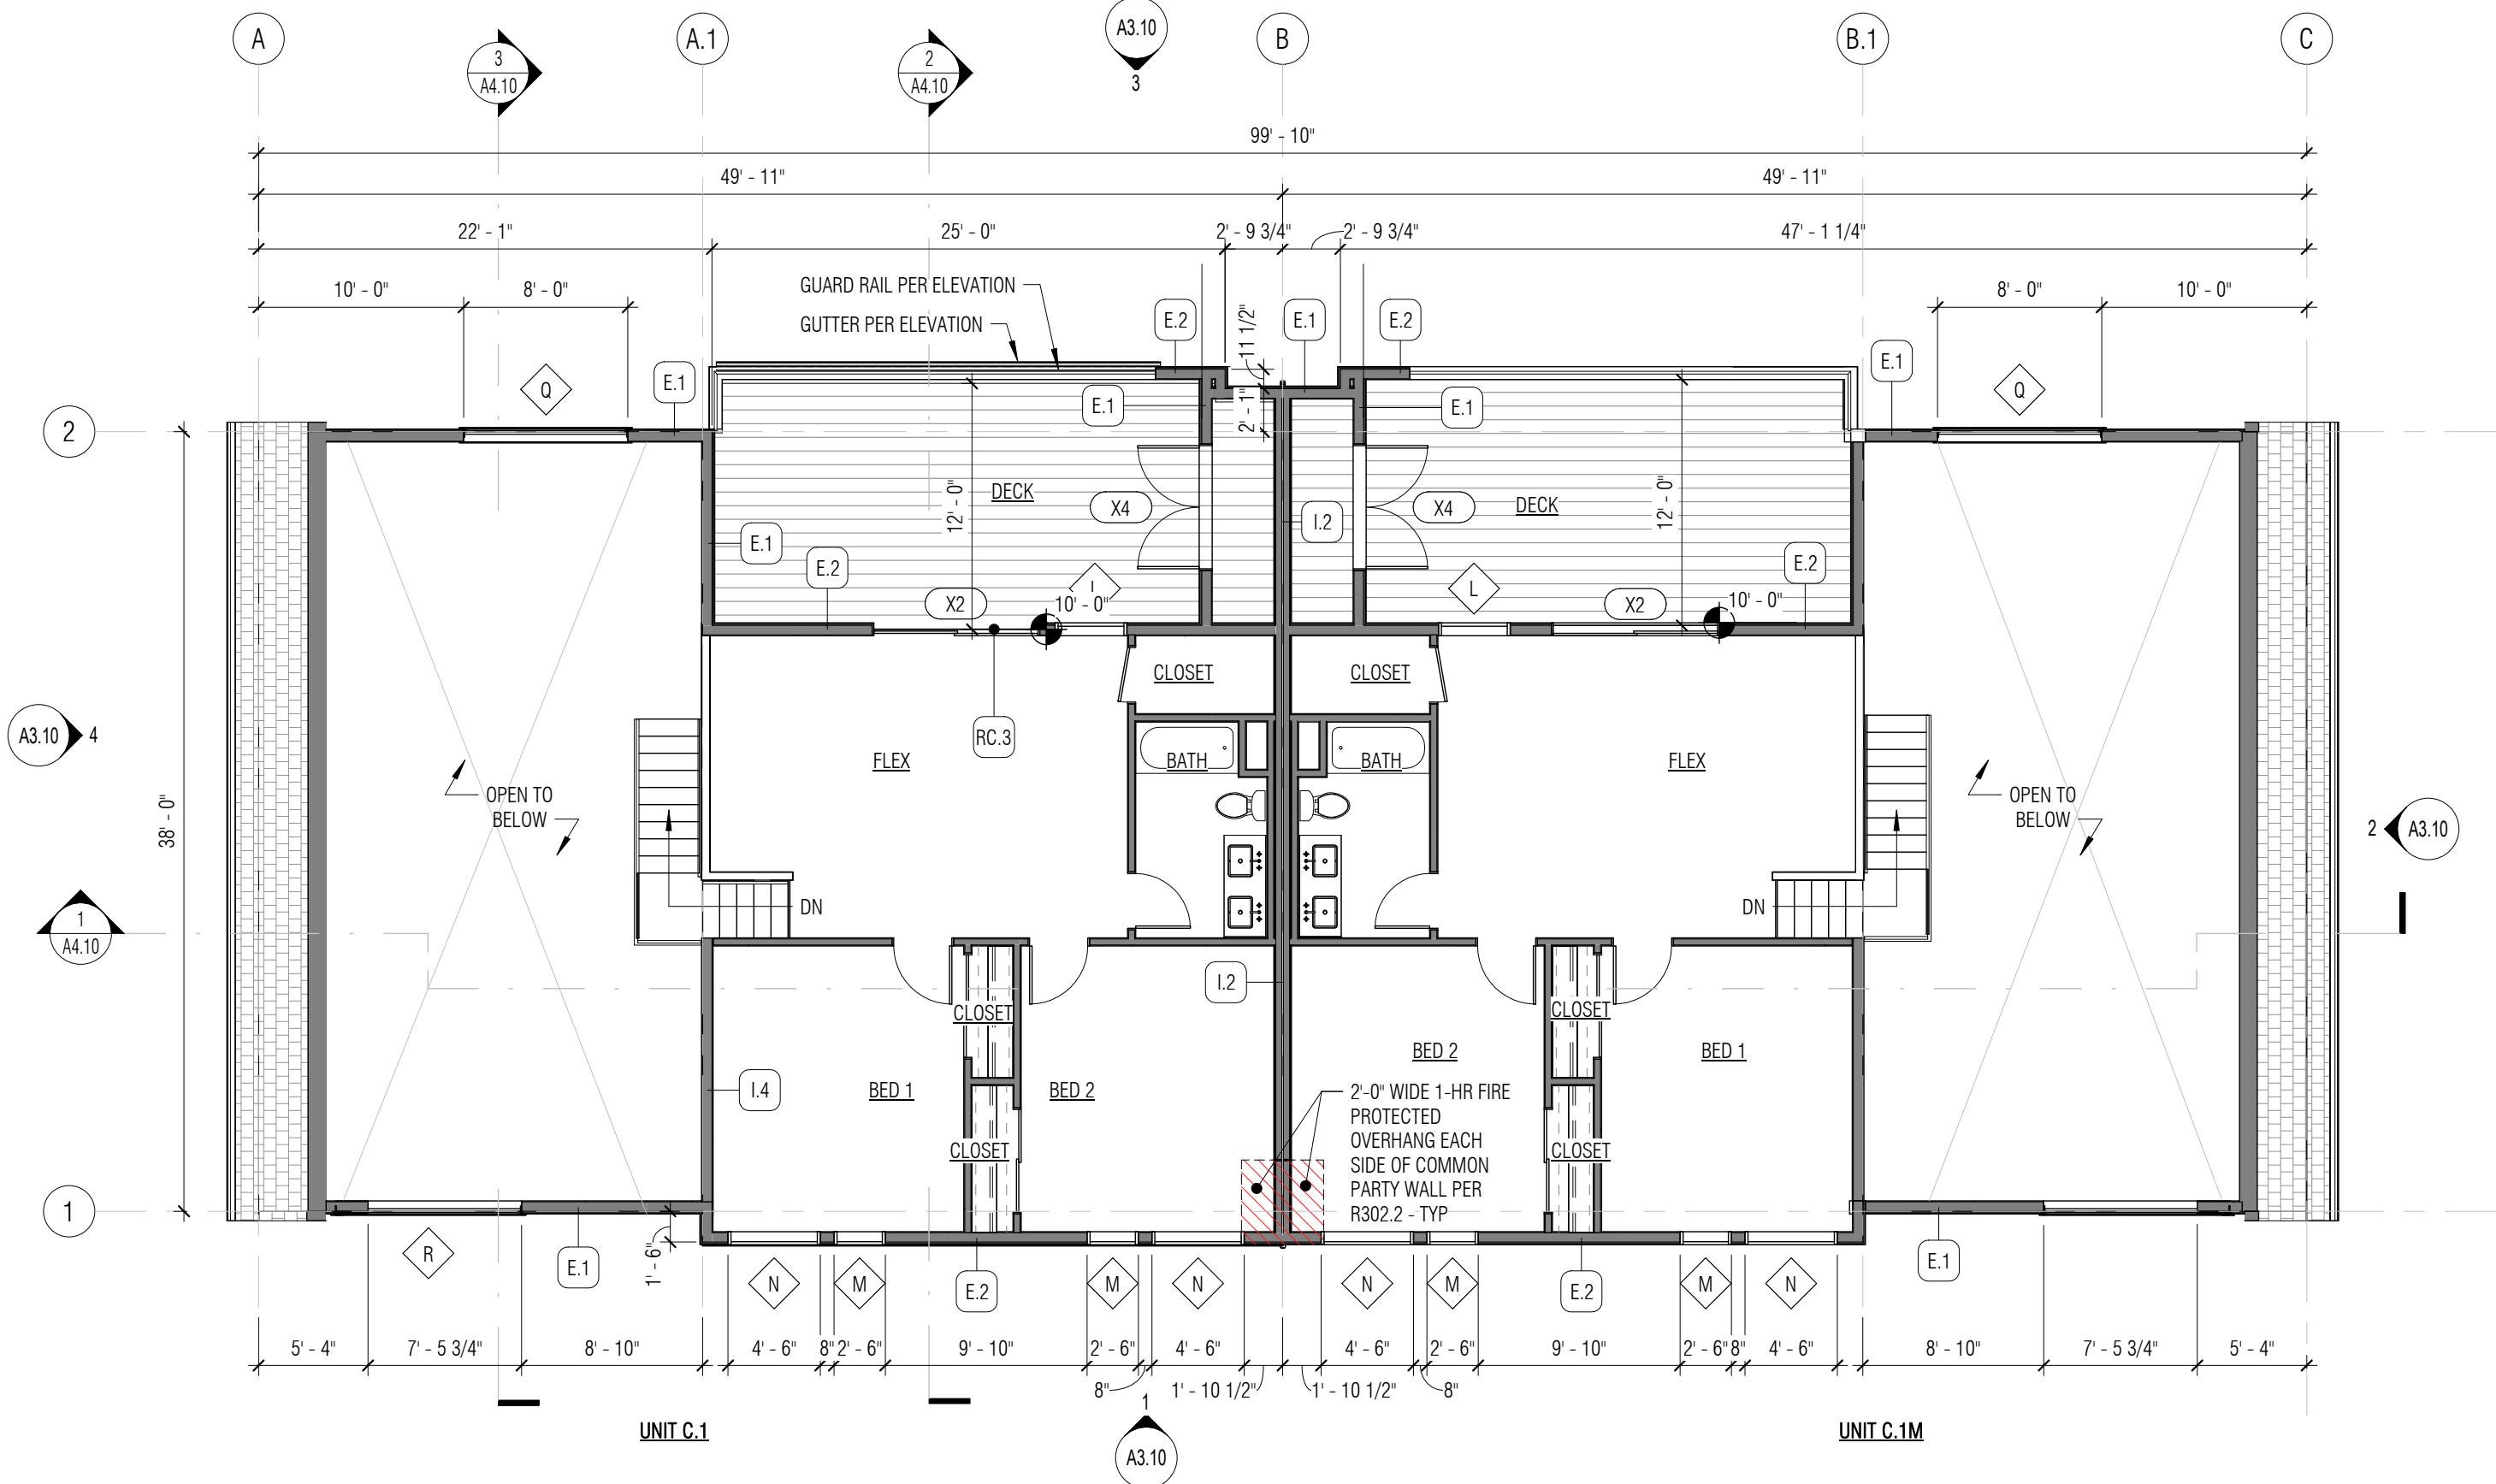

1 2-PACK TOWNHOUSE (C-C) FLOOR PLAN - LEVEL 2
1/8" = 1'-0"

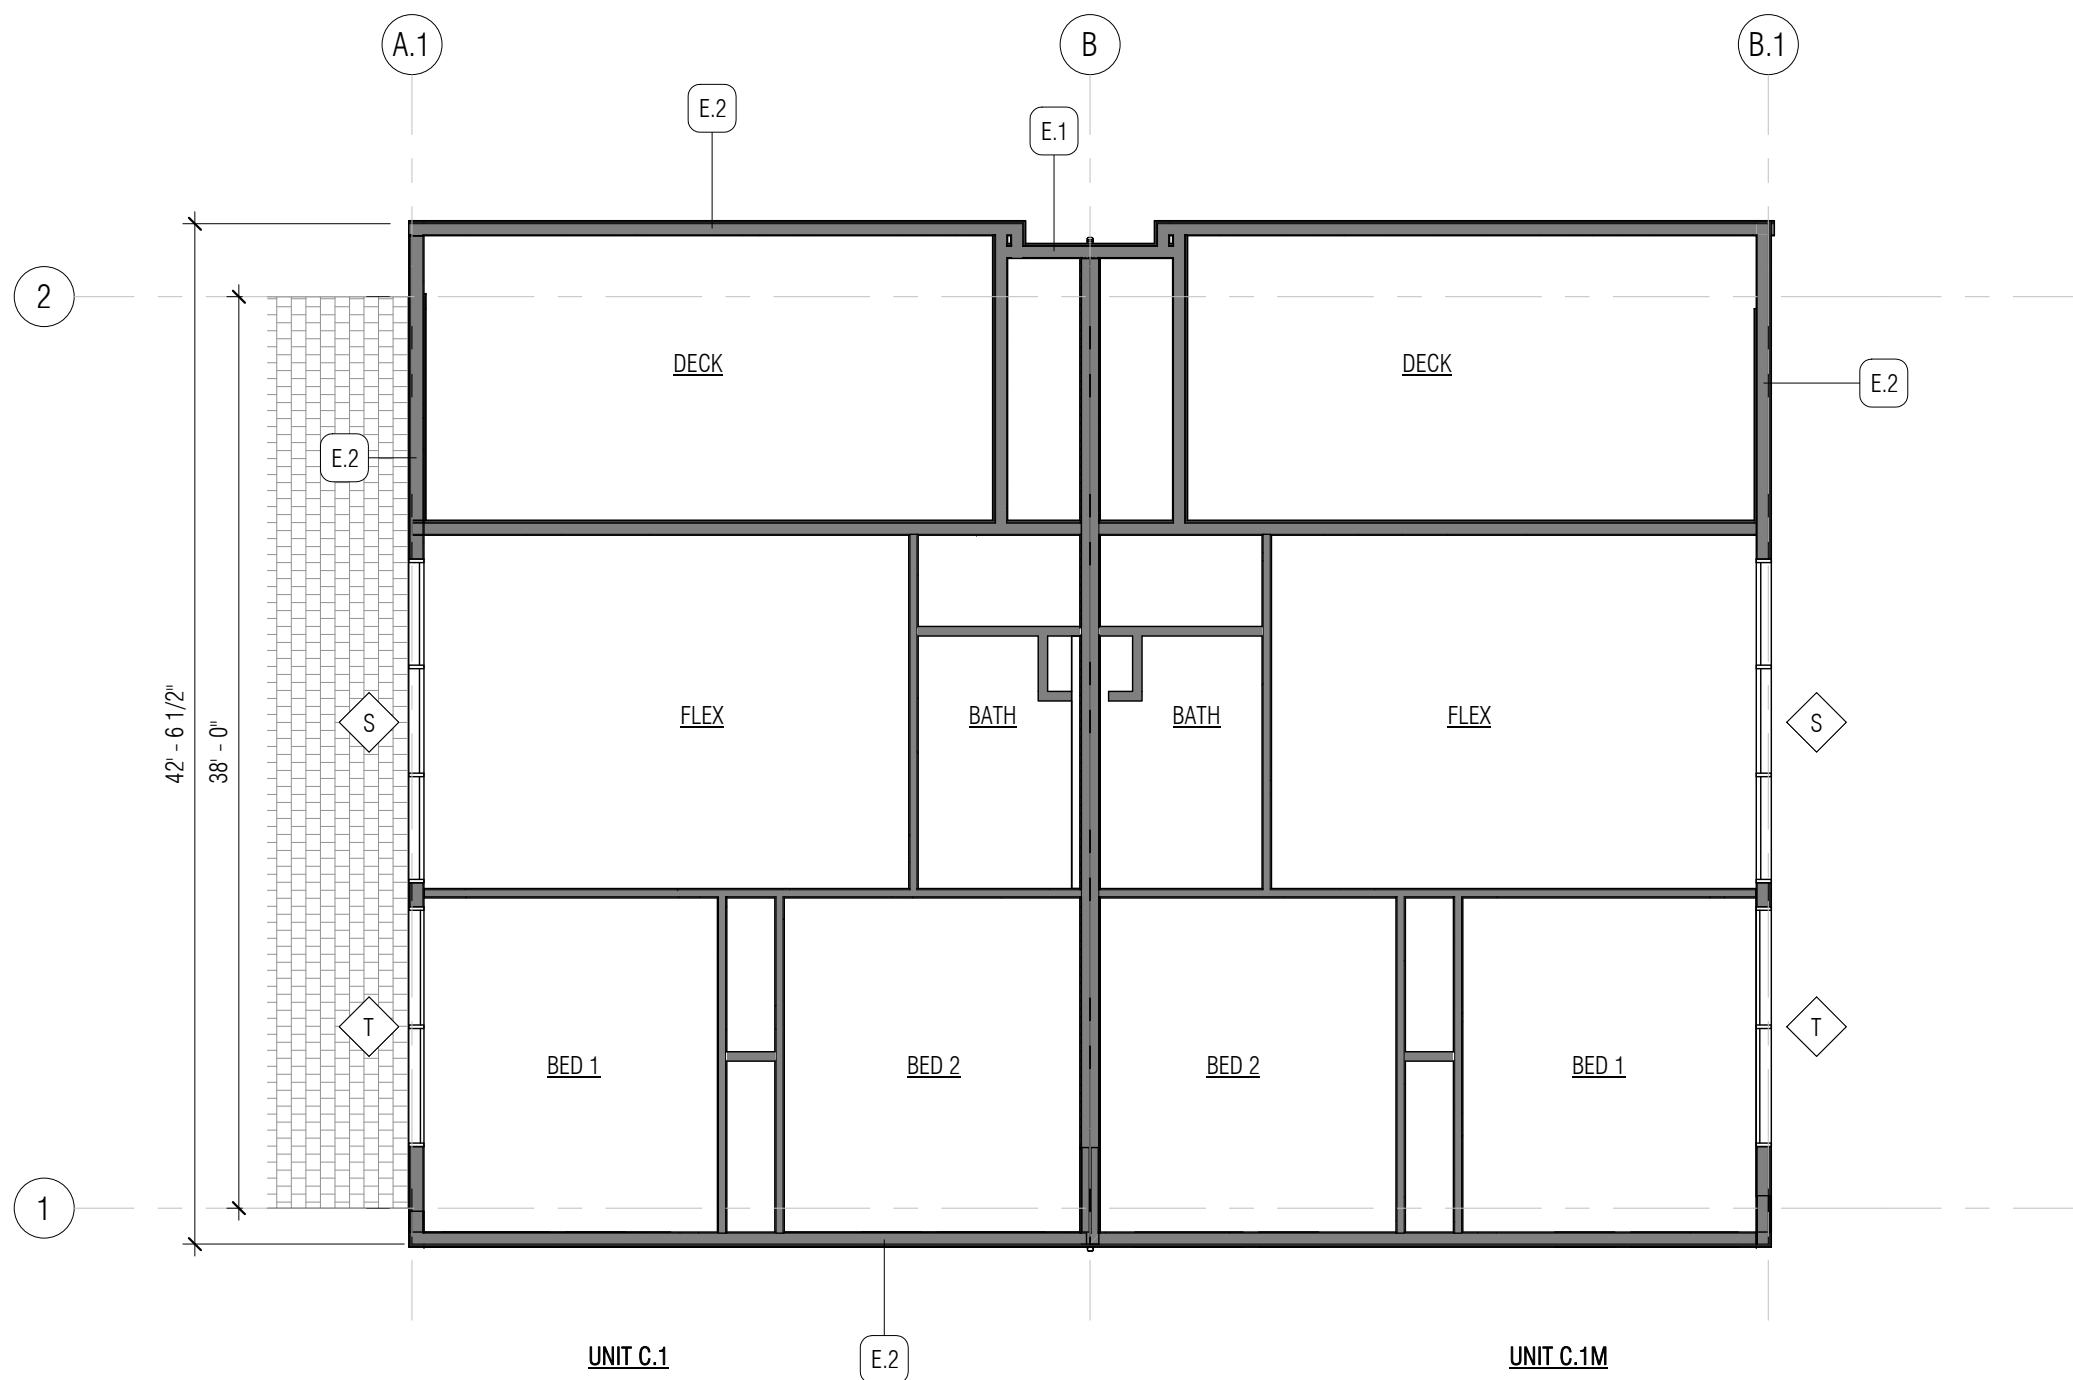

3 2-PACK TOWNHOUSE (C-C) PARTIAL LEVEL 2 PLAN
1/8" = 1'-0"

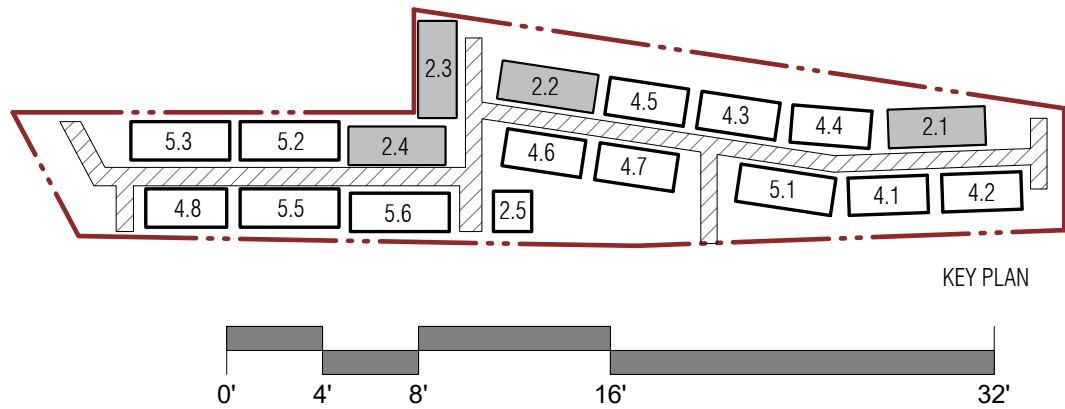

GENERAL NOTES - FLOOR PLANS

1. ALL INTERIOR WALLS ARE 1.0 UNO. PROVIDE 3-1/2" SOUND INSULATION IN COMMON PARTY WALLS.
2. ALL EXTERIOR WALLS ARE E.1 UNO.
3. ALL EXTERIOR DIMENSIONS ARE MEASURED FROM GRID LINE TO GRID LINE OR FACE OF FRAMING. ALL INTERIOR DIMENSIONS ARE FROM FACE OF STUD.
4. GRIDS ARE ALIGNED WITH THE EXTERIOR FACE OF FRAMING AT EXTERIOR WALLS AND ALIGNED WITH THE CENTER OF THE PARTY-WALLS.
5. DIMENSIONS AT POSTS ARE TO CENTERLINES UNO - VERIFY ALL STRUCTURAL LOCATIONS WITH FRAMING PLANS
6. WINDOW DIMENSIONS ARE GIVEN AS NOMINAL MEASUREMENTS.
7. DOOR ROUGH OPENINGS ARE 4" OFF STUD FACE OF PERP. WALL (TO HINGED SIDE OF THE DOOR) UNO
8. ALL FINISH FLOOR MATERIALS TO ALIGN WITH ADJACENT FLOOR FINISH
9. SEE GENERAL SHEETS FOR CODE, DIMENSIONING AND GENERAL NOTES
10. SEE SHEETS A5.11 TO A5.14 FOR ENLARGED 1/4" = 1'-0" PLANS

FLOOR PLAN KEY

- WALL
- CONC. WALL
- 1-HR RATED WALL
- 1-HR RATED FLOOR OR ROOF AREA
- STRIP VENT
- SOLAR READY ZONE

REVISION	DATE	DESCRIPTION
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ISSUANCES

DATE	DESCRIPTION
7/29/2022	LAND USE APPLICATION
1/13/2023	LAND USE APP RESUBMITTAL
4/14/2023	LAND USE APP RESUBMITTAL

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ORIGINAL SHEET SIZE IS 24"x36"

BOARD & VELLUM PROJECT #: 2021170.00
COB PROJECT #: 2021-0105

PLOT DATE: 04.12.2023

FLOOR PLANS - SECOND
FLOOR & ROOF - 2-PACK TH
"C-C" UNITS


SHEET NO.:

GENERAL NOTES - FLOOR PLANS



- ALL INTERIOR WALLS ARE 1.0 UNO. PROVIDE 3-1/2" SOUND INSULATION IN COMMON PARTY WALLS.
- ALL EXTERIOR WALLS ARE E.1 UNO.
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- GRIDS ARE ALIGNED WITH THE EXTERIOR FACE OF FRAMING AT EXTERIOR WALLS AND ALIGNED WITH THE CENTER OF THE PARTY-WALLS.
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- WINDOW DIMENSIONS ARE GIVEN AS NOMINAL MEASUREMENTS.
- DOOR ROUGH OPENINGS ARE 4" OFF STUD FACE OF PERP. WALL (TO HINGED SIDE OF THE DOOR) UNO
- ALL FINISH FLOOR MATERIALS TO ALIGN WITH ADJACENT FLOOR FINISH
- SEE GENERAL SHEETS FOR CODE, DIMENSIONING AND GENERAL NOTES
- SEE SHEETS A5.11 TO A5.14 FOR ENLARGED 1/4" = 1'-0" PLANS

FLOOR PLAN KEY

- WALL
- CONC. WALL
- 1-HR RATED WALL
- 1-HR RATED FLOOR OR ROOF AREA
- STRIP VENT
- SOLAR READY ZONE

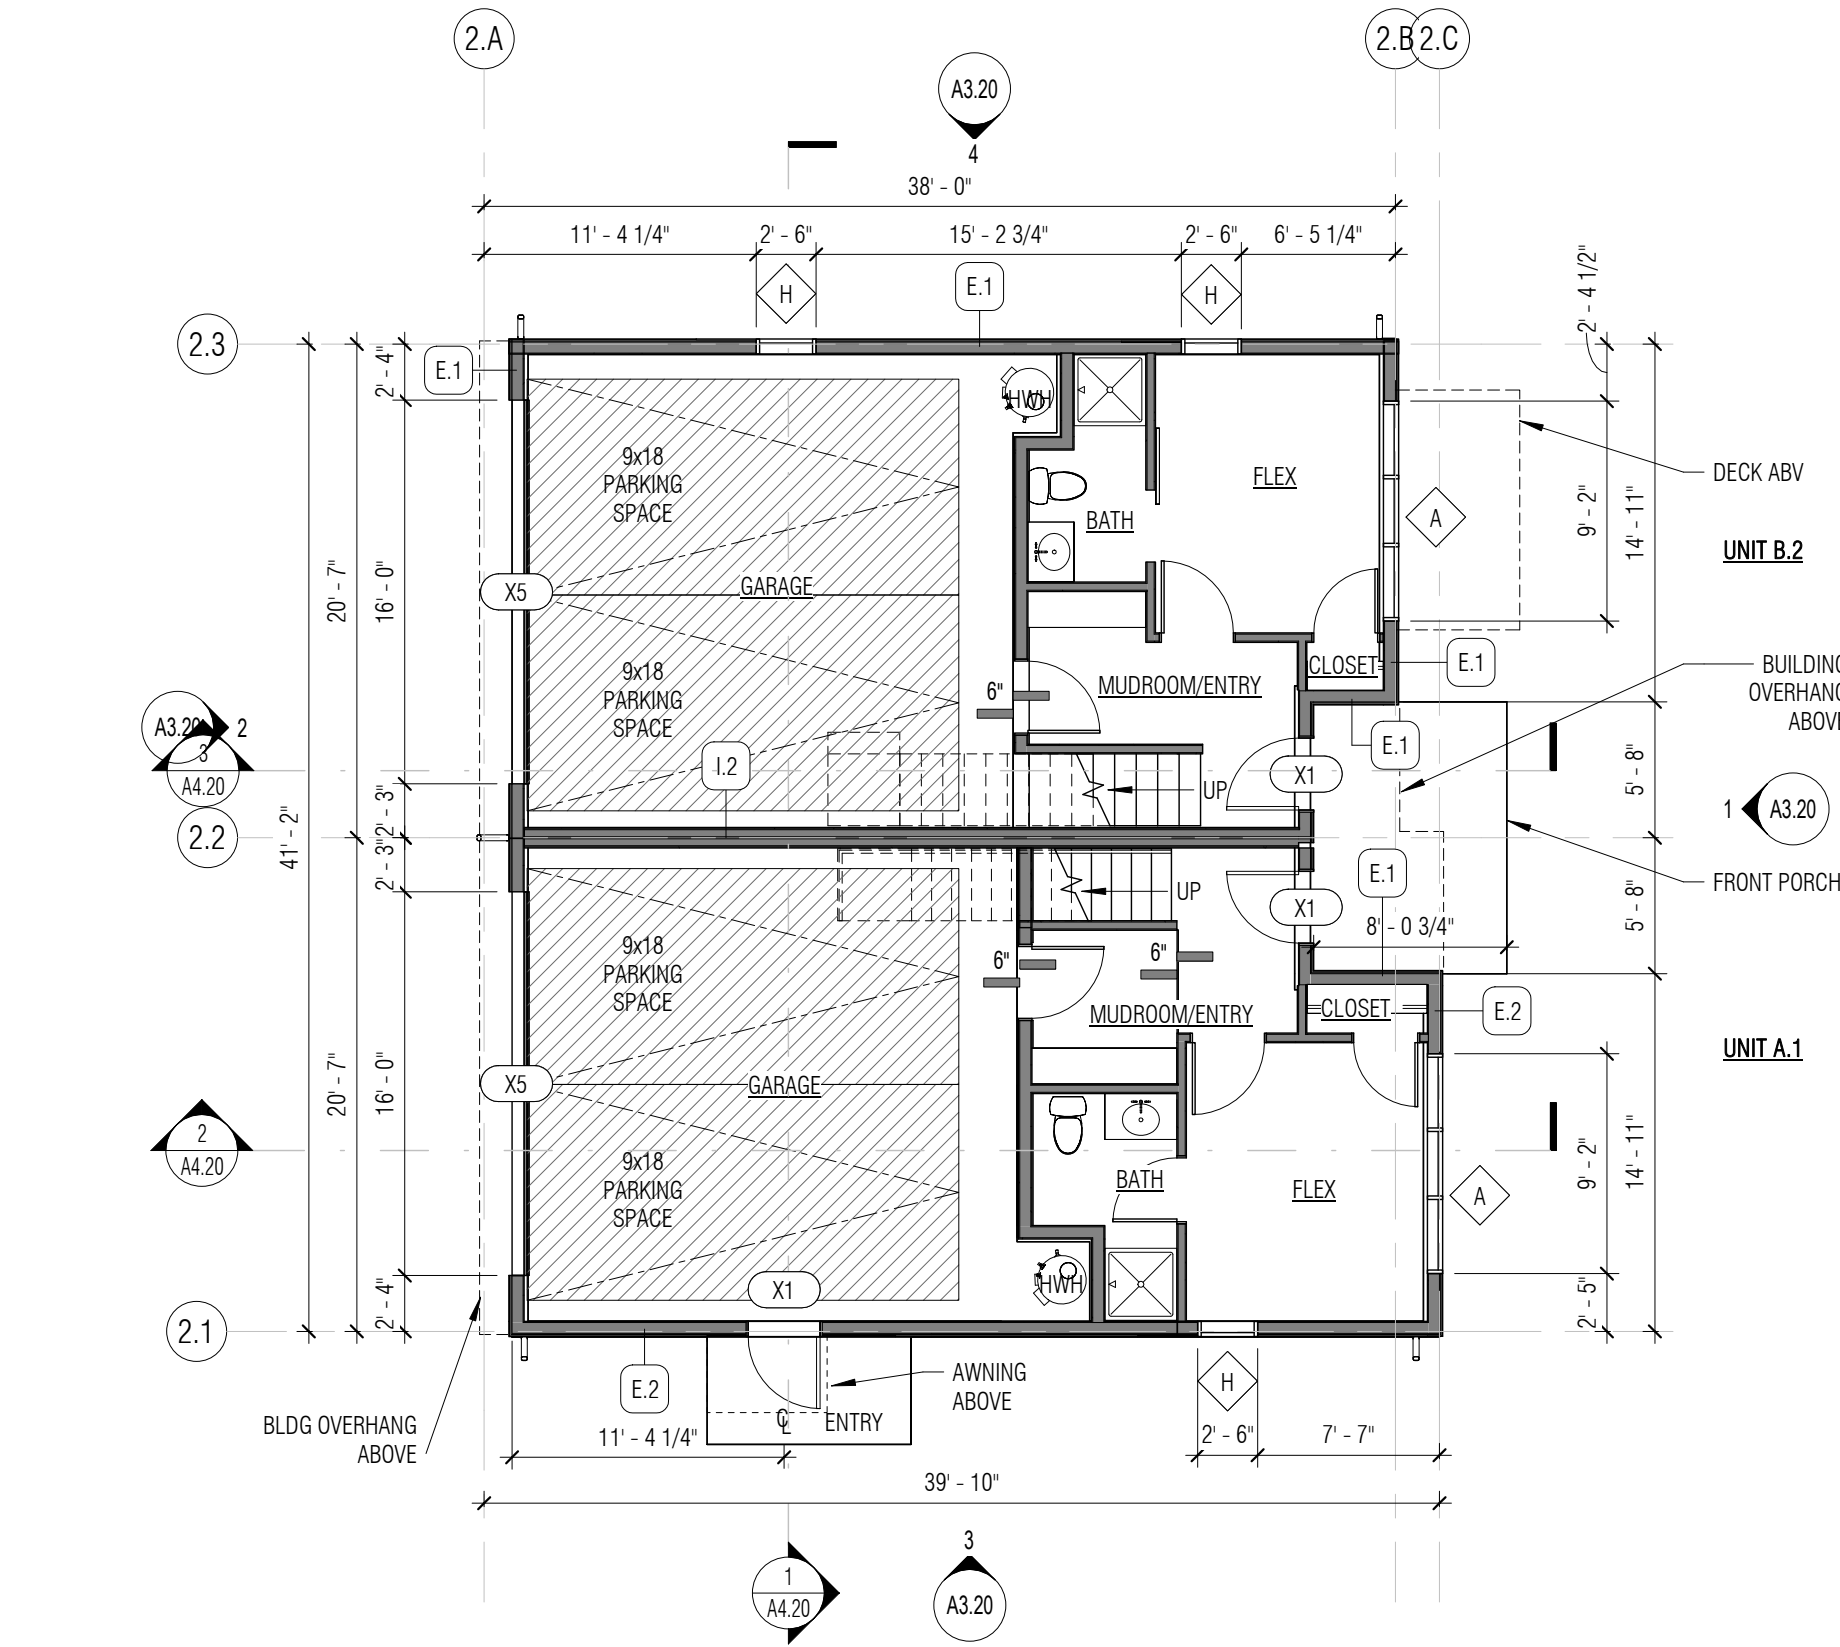

2 2-PACK TOWNHOUSE (A-B) FLOOR PLAN - LEVEL 1
1/8" = 1'-0"

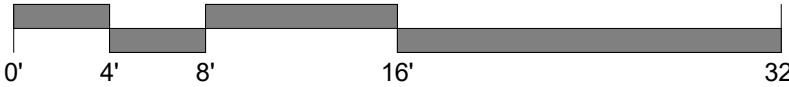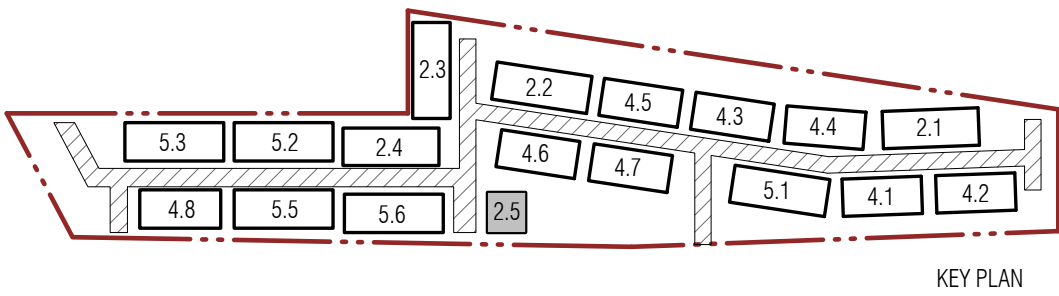

REVISION	DATE	DESCRIPTION
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ISSUANCES

DATE	DESCRIPTION
7/29/2022	LAND USE APPLICATION
1/13/2023	LAND USE APP RESUBMITTAL
4/14/2023	LAND USE APP RESUBMITTAL

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ORIGINAL SHEET SIZE IS 24"x36"

BOARD & VELLUM PROJECT #: 2021170.00
COB PROJECT #: 2021-0105

PLOT DATE: 04.12.2023

FLOOR PLANS - FDN & FIRST
FLOOR - 2-PACK TH "A-B"
UNITS

SHEET NO.:

A2.20

ROOF VENTILATION CALCULATIONS

REFERENCE: 2018 INTERNATIONAL RESIDENTIAL CODE SECTION R806

1. ENCLOSED ATTICS AND ENCLOSED RAFTER SPACES FORMED WHERE CEILINGS ARE APPLIED DIRECTLY TO THE UNDERSIDE OF ROOF RAFTERS SHALL HAVE CROSS VENTILATION FOR EACH SEPARATE SPACE BY VENTILATING OPENINGS PROTECTED AGAINST THE ENTRANCE OF RAIN OR SNOW.
2. VENTILATING OPENINGS SHALL BE PROVIDED WITH CORROSION-RESISTANT WIRE MESH WITH 1/8 INCH MINIMUM TO 1/4 INCH MAXIMUM OPENINGS.
3. THE TOTAL NET FREE VENTILATING AREA SHALL NOT BE LESS THAN 1/150 OF THE AREA OF THE SPACE VENTILATED, BUT MAY BE REDUCED TO 1/300, PROVIDED THAT AT LEAST 40 PERCENT AND NOT MORE THAN 50 PERCENT OF THE REQUIRED VENTILATING AREA IS PROVIDED BY VENTILATORS LOCATED IN THE UPPER PORTION OF THE SPACE TO BE VENTILATED NO MORE THAN 3 FEET BELOW THE RIDGE OR HIGHEST POINT OF THE SPACE, MEASURED VERTICALLY, WITH THE BALANCE OF THE REQUIRED VENTILATION PROVIDED BY EAVE OR CORNICE VENTS.
4. WHERE THE LOCATION OF WALL OR ROOF FRAMING MEMBERS CONFLICTS WITH THE INSTALLATION OF UPPER VENTILATORS, INSTALLATION MORE THAN 3 FEET BELOW THE RIDGE OR HIGHEST POINT OF THE SPACE SHALL BE PERMITTED. AS AN ALTERNATIVE, THE NET FREE CROSS-VENTILATION AREA MAY BE REDUCED TO 1/300 WHEN A VAPOR BARRIER HAVING A TRANSMISSION RATE NOT EXCEEDING 1 PERM IS INSTALLED ON THE WARM-IN-THE-WINTER SIDE OF THE CEILING.
5. WHERE EAVE OR CORNICE VENTS ARE INSTALLED, INSULATION SHALL NOT BLOCK THE FREE FLOW OF AIR. A MINIMUM OF A 1-INCH SPACE SHALL BE PROVIDED BETWEEN THE INSULATION AND THE ROOF SHEATHING AND AT THE LOCATION OF THE VENT.

UNIT	AREA OF VENTED ATTIC (SF)	TOTAL REQ. VENT AREA = 1/300 OF AREA	VENTS PROVIDED	NET FREE OPENING AREA PER LINEAL FOOT (SI)	AREA PROVIDED (SI)	% OF REQ'D
A.1 / A.1M / A.2	767	368 SI	RIDGE VENT: (1) 20' LONG STRIP VENT: (1) 20' LONG	10 10	200 200	50% 50%
MIN. REQ'D NET FREE AREA		368 SI	PROVIDED NET FREE AREA		400 SI	



UNIT	AREA OF VENTED ATTIC (SF)	TOTAL REQ. VENT AREA = 1/300 OF AREA	VENTS PROVIDED	NET FREE OPENING AREA PER LINEAL FOOT (SI)	AREA PROVIDED (SI)	% OF REQ'D
B.1 / B.1M / B.2	730	351 SI	RIDGE VENT: (1) 20' LONG STRIP VENT: (1) 20' LONG	10 10	200 200	50% 50%
MIN. REQ'D NET FREE AREA		351 SI	PROVIDED NET FREE AREA		400 SI	

UNIT NUMBER	AREA OF VENTED ATTIC SPACE (SF)	REQUIRED 1/300 (SI)
UNIT A.1 / A.1M	767 SF	368 SI
UNIT A.2	764 SF	367 SI
UNIT B.1 / B.1M	728 SF	350 SI
UNIT B.2	730 SF	351 SI


GENERAL NOTES - FLOOR PLANS

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3. ALL EXTERIOR DIMENSIONS ARE MEASURED FROM GRID LINE TO GRID LINE OR FACE OF FRAMING. ALL INTERIOR DIMENSIONS ARE FROM FACE OF STUD.
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10. SEE SHEETS A5.11 TO A5.14 FOR ENLARGED 1/4" = 1'-0" PLANS


FLOOR PLAN KEY

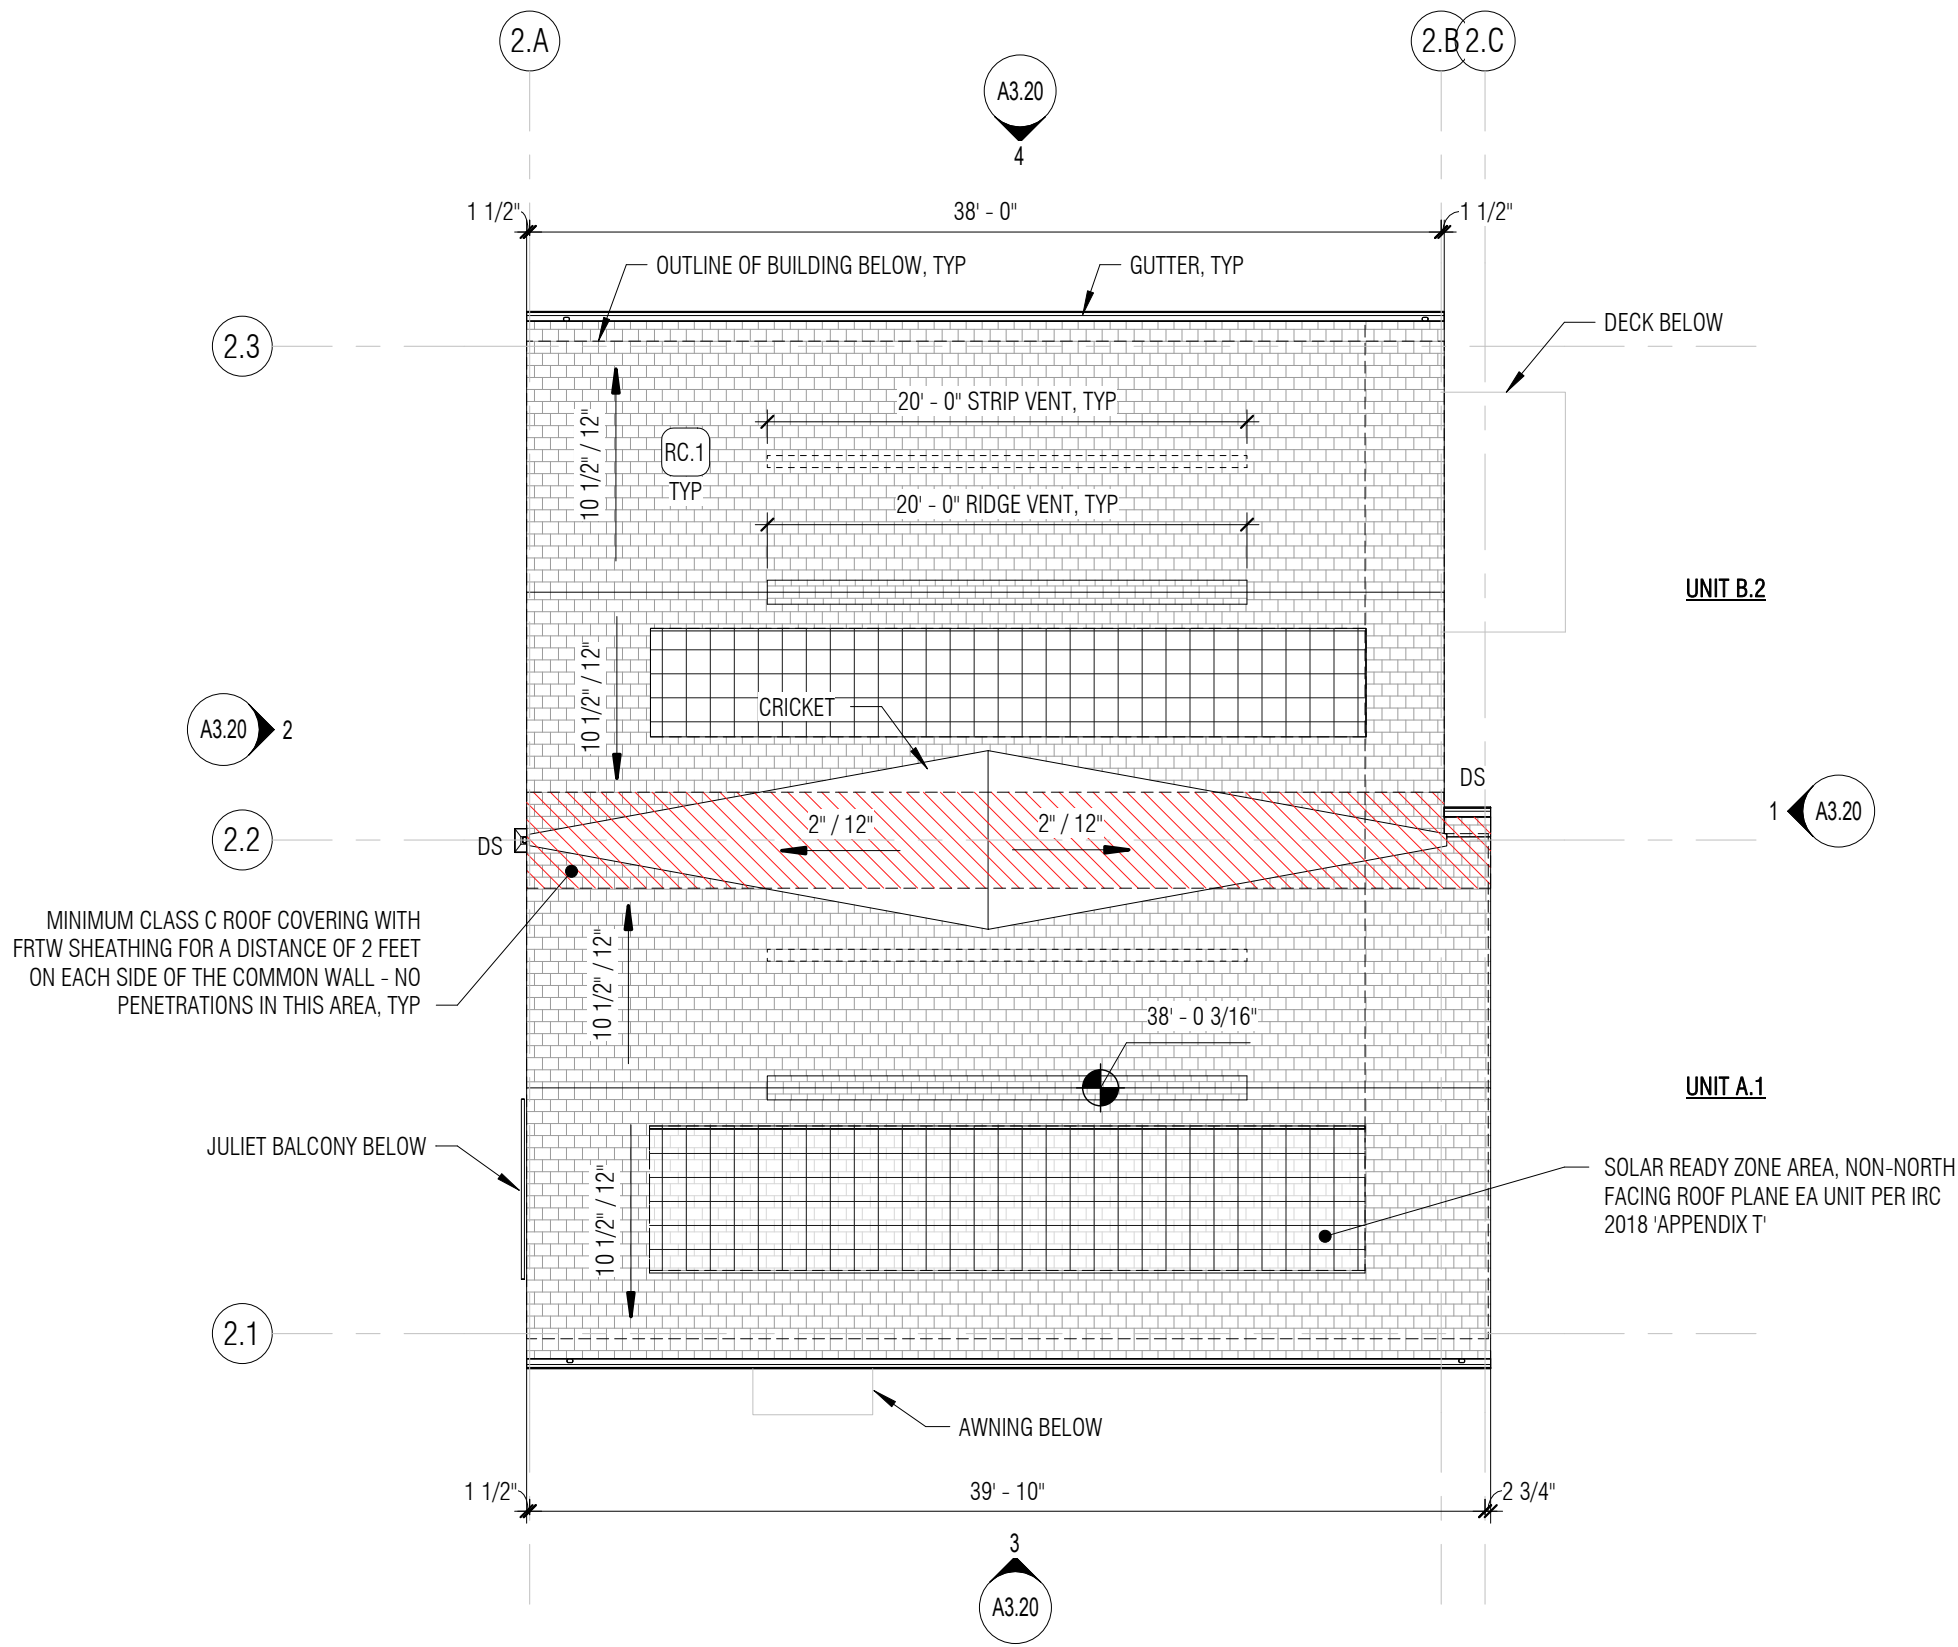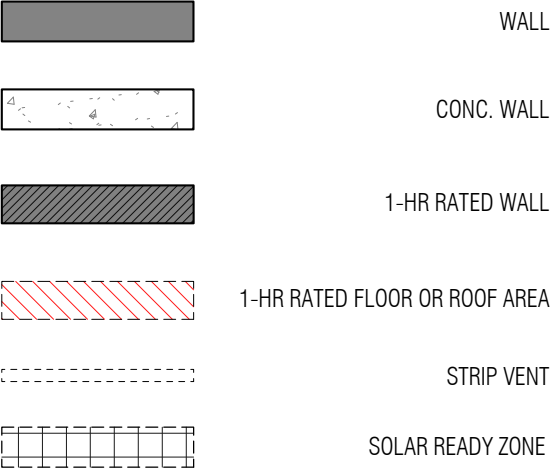



3 2-PACK TOWNHOUSE (A-B) ROOF PLAN
1/8" = 1'-0"

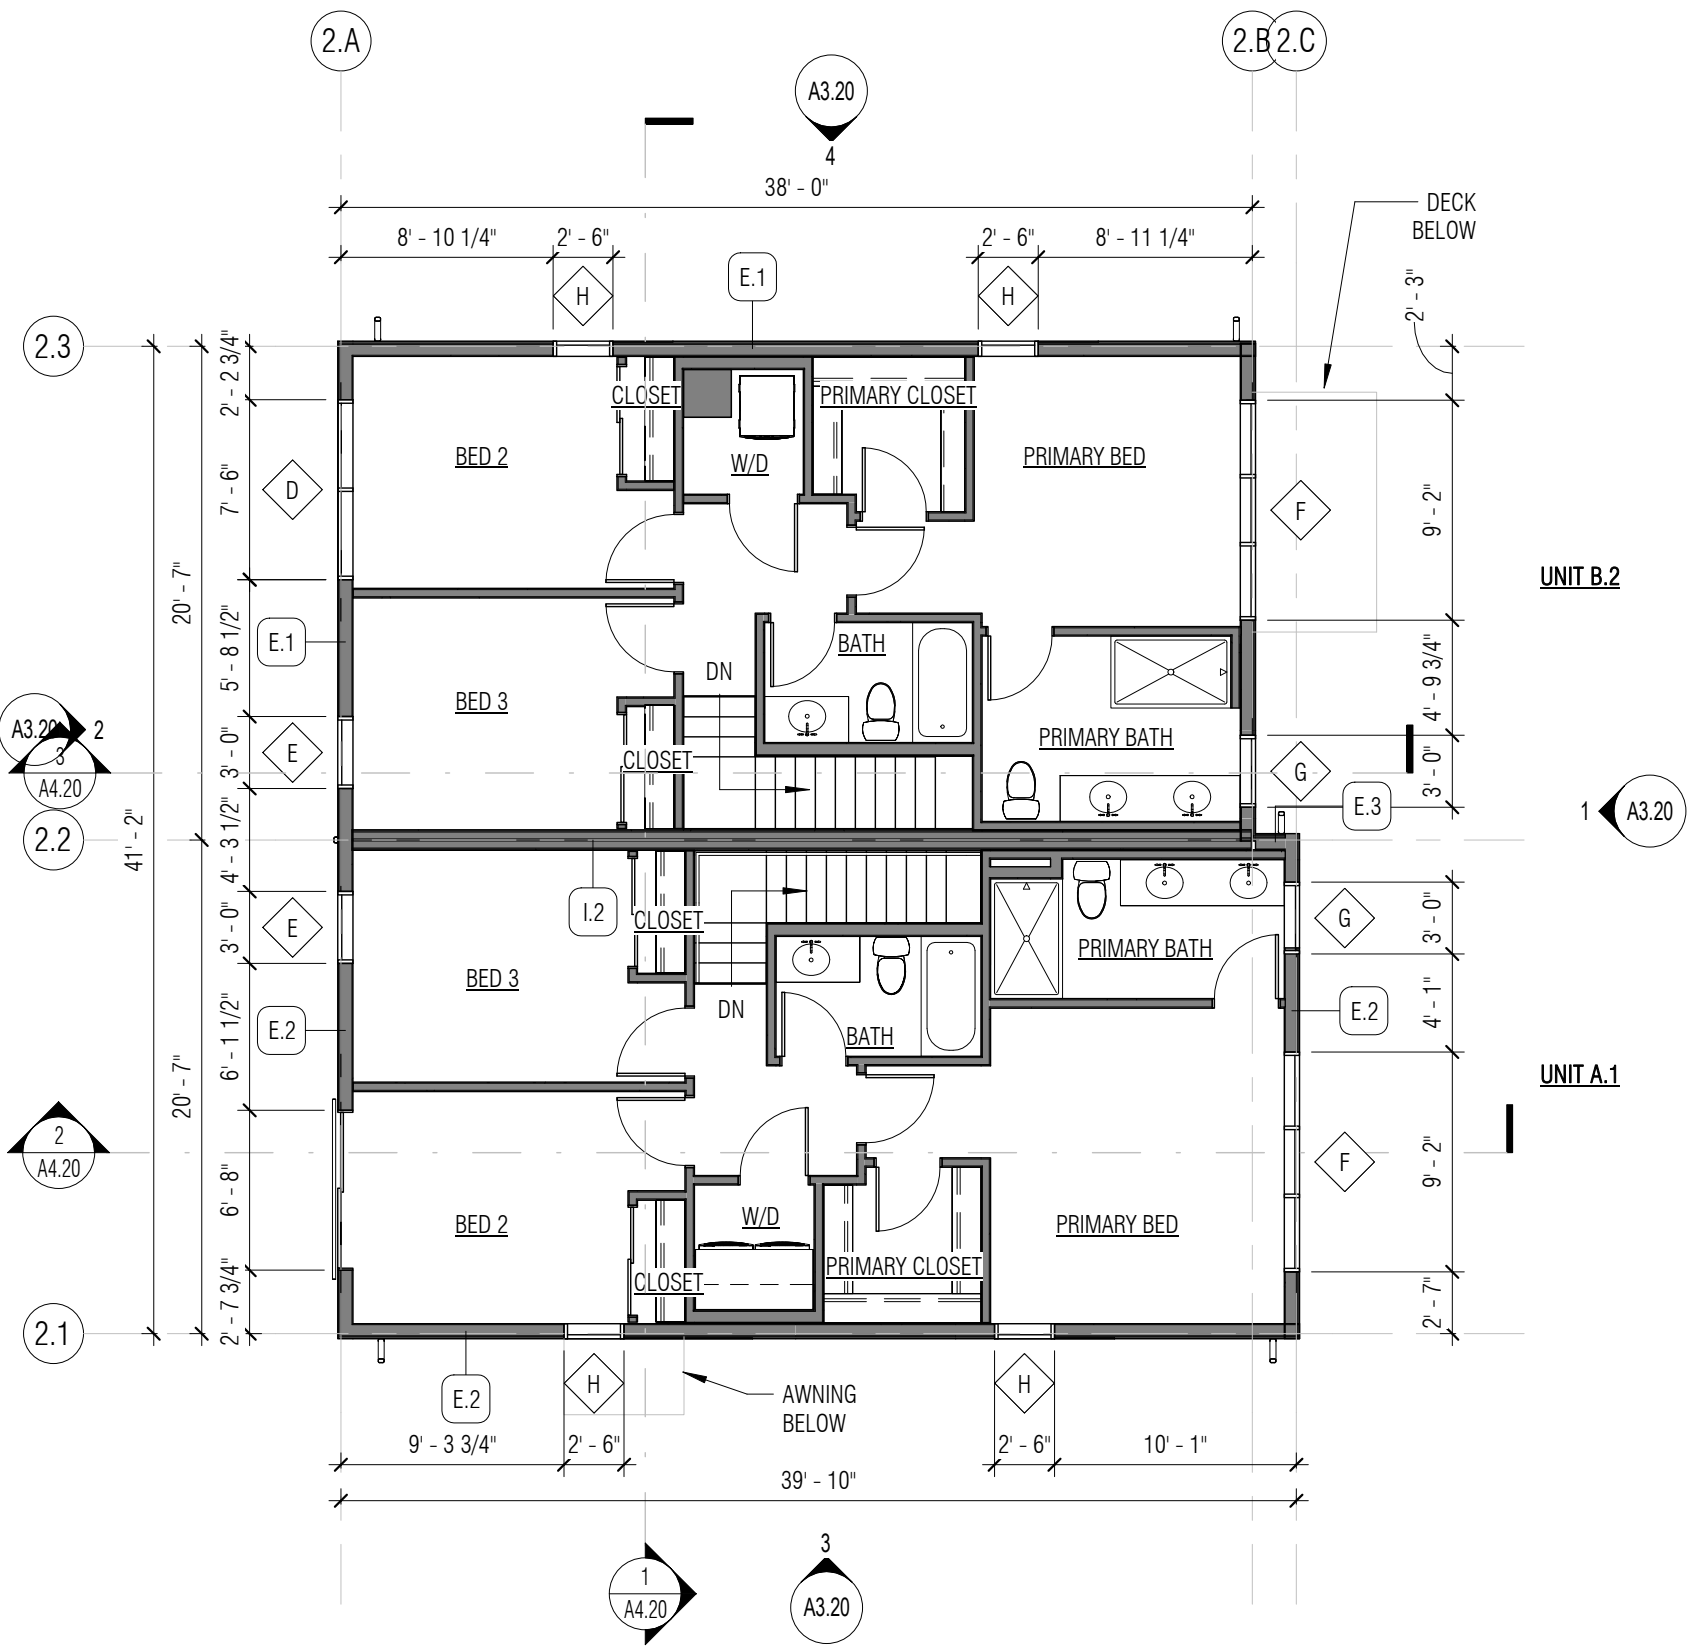

2 2-PACK TOWNHOUSE (A-B) FLOOR PLAN - LEVEL 2
1/8" = 1'-0"

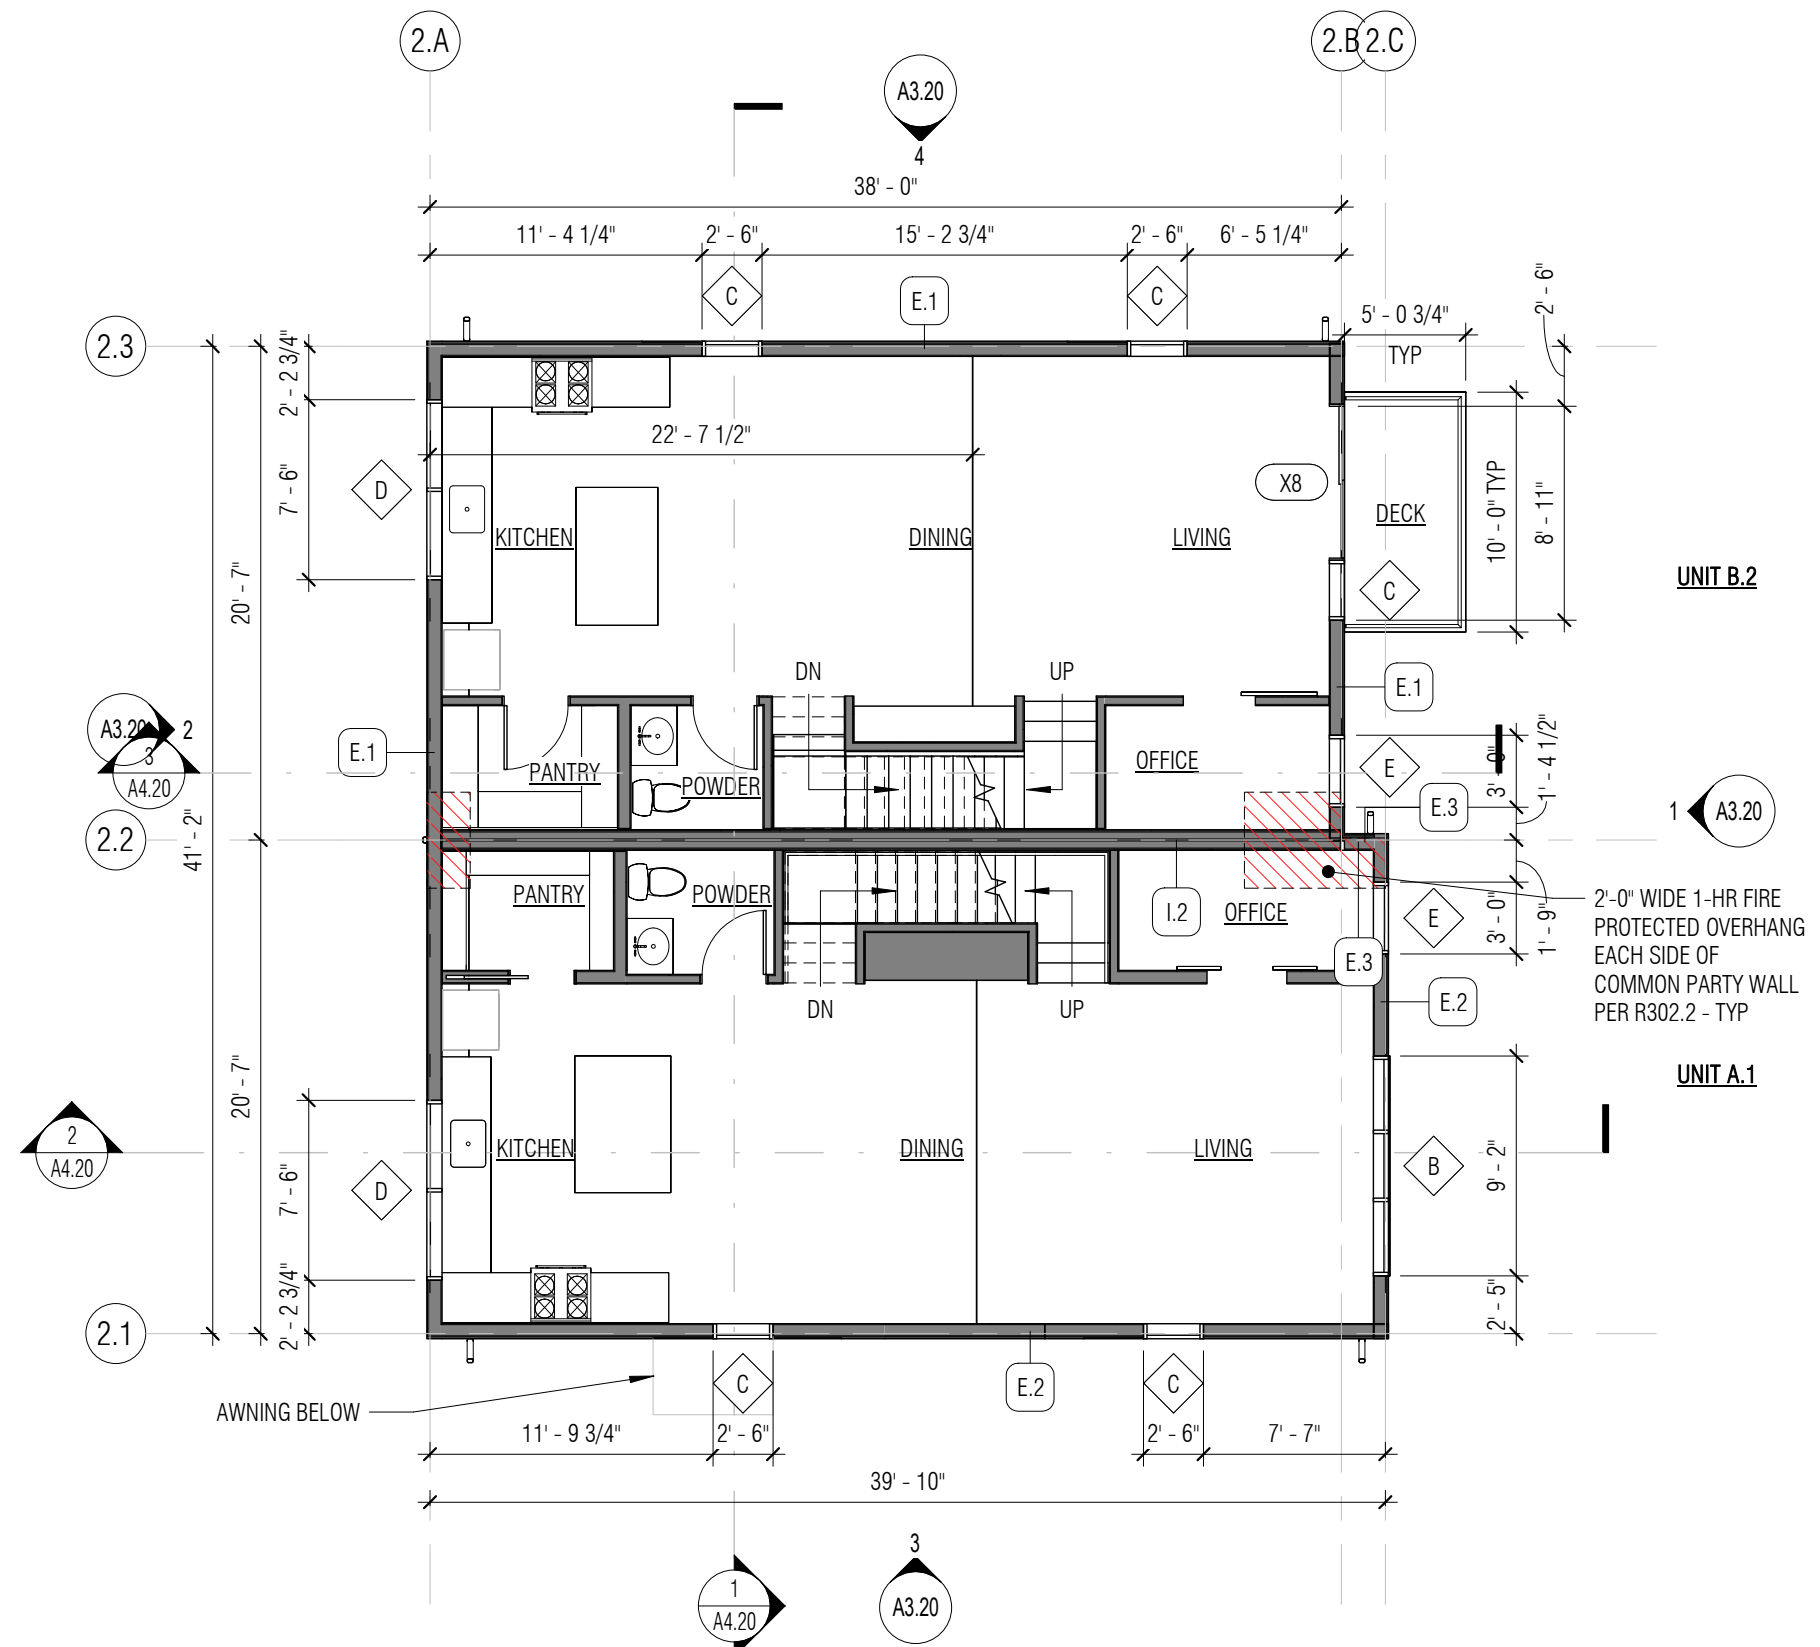

1 2-PACK TOWNHOUSE (A-B) FLOOR PLAN - LEVEL 2
1/8" = 1'-0"

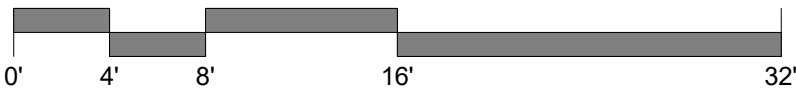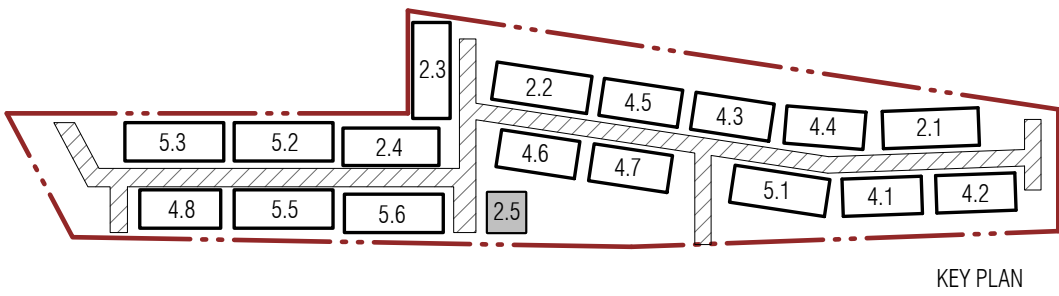


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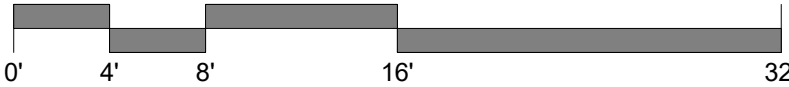
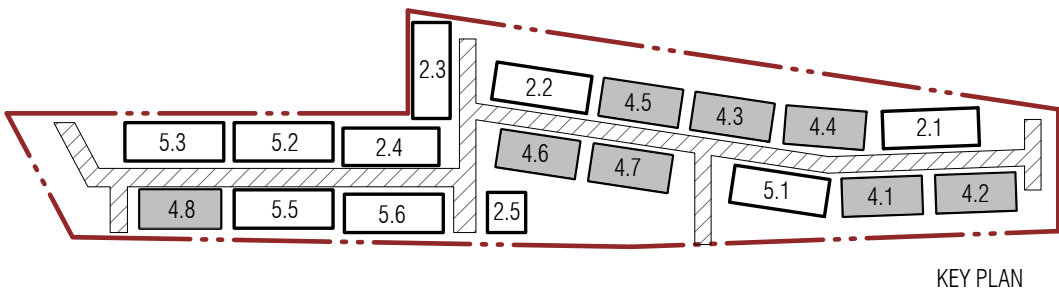
FLOOR PLAN KEY

- WALL
- CONC. WALL
- 1-HR RATED WALL
- 1-HR RATED FLOOR OR ROOF AREA
- STRIP VENT
- SOLAR READY ZONE



2 4-PACK TOWNHOUSE "A-B-A-B" FLOOR PLAN - LEVEL 1

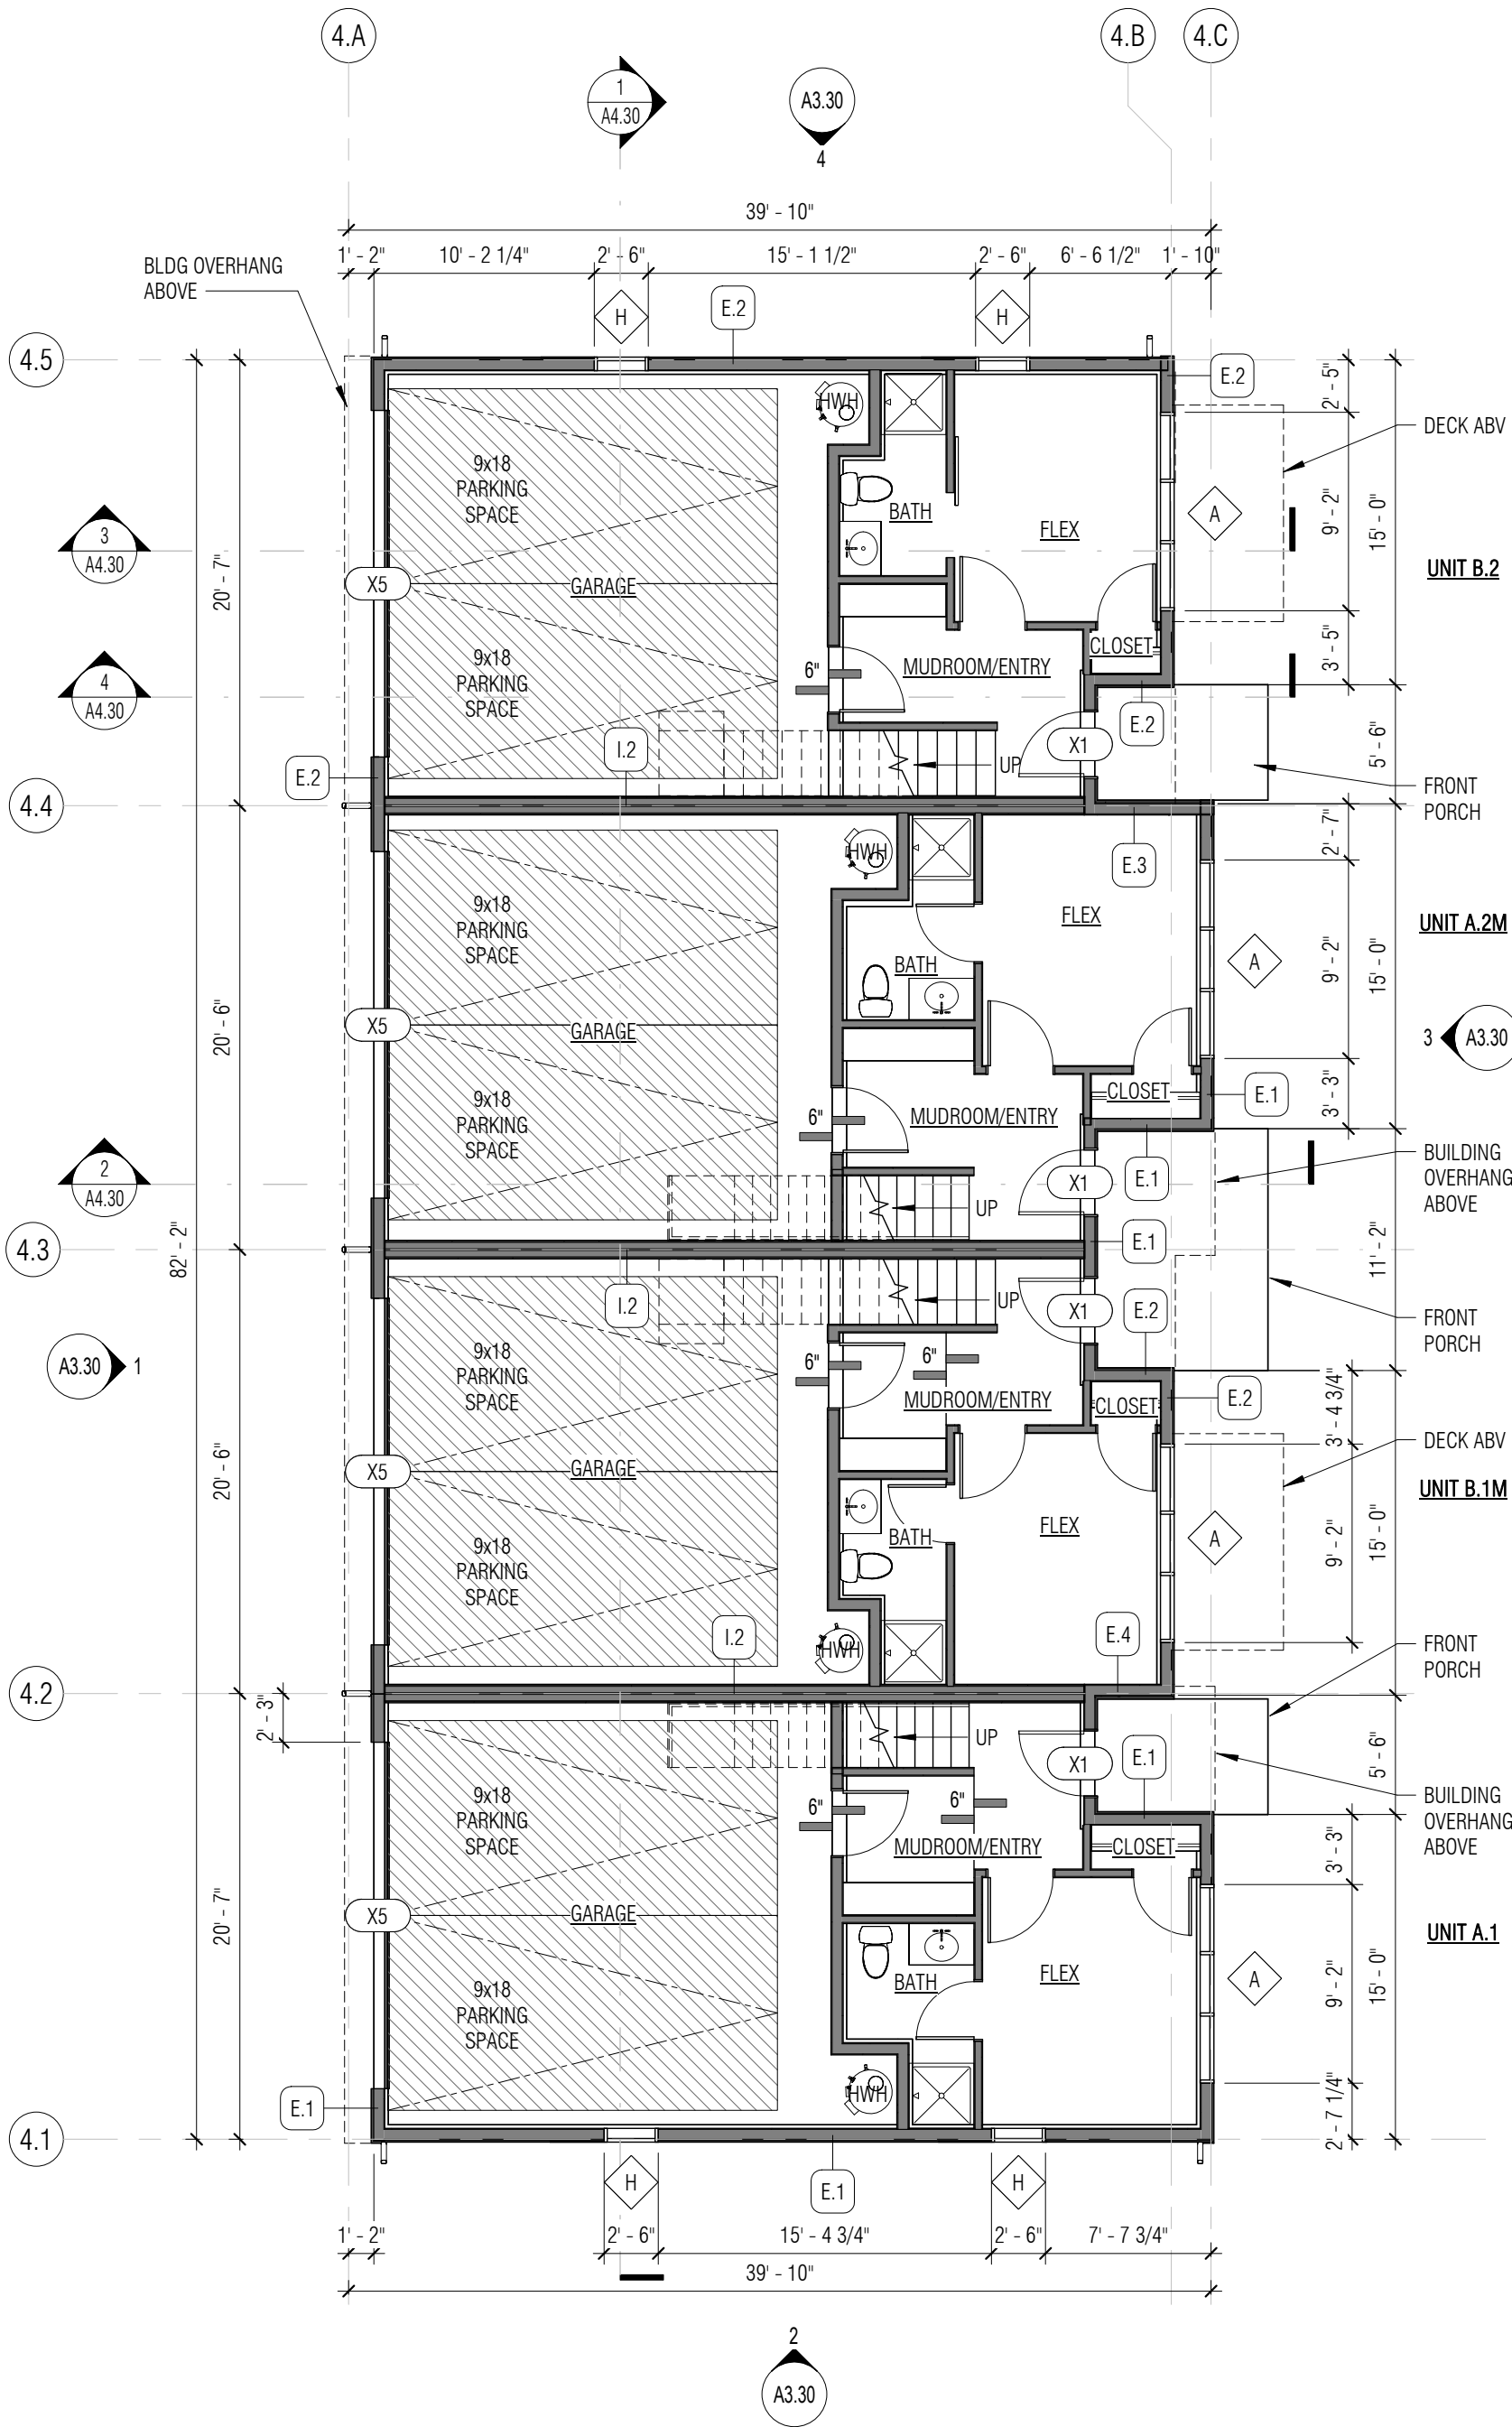1/8" = 1'-0"
FLOOR PLAN - LEVEL 1 FOR BLDGS 4.2, 4.7; SEE A2.31
FLOOR PLAN - LEVEL 1 FOR BLDG 4.5; SEE A2.32



REVISION	DATE	DESCRIPTION
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ISSUANCES	
DATE	DESCRIPTION
7/29/2022	LAND USE APPLICATION
1/13/2023	LAND USE APP RESUBMITTAL
4/14/2023	LAND USE APP RESUBMITTAL

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ORIGINAL SHEET SIZE IS 24"x36"

BOARD & VELLUM PROJECT #: 2021170.00
COB PROJECT #: 2021-0105

PLOT DATE: 04.12.2023
FLOOR PLANS - FDN & FIRST
FLR - 4-PACK TH "A-B-A-B"
UNITS (4.1, 4.3, 4.4, 4.6)

SHEET NO.:

ROOF VENTILATION CALCULATIONS

REFERENCE: 2018 INTERNATIONAL RESIDENTIAL CODE SECTION R806

1. ENCLOSED ATTICS AND ENCLOSED RAFTER SPACES FORMED WHERE CEILINGS ARE APPLIED DIRECTLY TO THE UNDERSIDE OF ROOF RAFTERS SHALL HAVE CROSS VENTILATION FOR EACH SEPARATE SPACE BY VENTILATING OPENINGS PROTECTED AGAINST THE ENTRANCE OF RAIN OR SNOW.
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UNIT	AREA OF VENTED ATTIC (SF)	TOTAL REQ. VENT AREA = 1/300 OF AREA	VENTS PROVIDED	NET FREE OPENING AREA PER LINEAL FOOT (SI)	AREA PROVIDED (SI)	% OF REQ'D
A.1 / A.1M / A.2	767	368 SI	RIDGE VENT: (1) 20' LONG STRIP VENT: (1) 20' LONG	10 10	200 200	50% UPPER 50% LOWER
MIN. REQ'D NET FREE AREA			PROVIDED NET FREE AREA			
			400 SI			

UNIT	AREA OF VENTED ATTIC (SF)	TOTAL REQ. VENT AREA = 1/300 OF AREA	VENTS PROVIDED	NET FREE OPENING AREA PER LINEAL FOOT (SI)	AREA PROVIDED (SI)	% OF REQ'D
B.1 / B.1M / B.2	730	351 SI	RIDGE VENT: (1) 20' LONG STRIP VENT: (1) 20' LONG	10 10	200 200	50% UPPER 50% LOWER
MIN. REQ'D NET FREE AREA			PROVIDED NET FREE AREA			
			400 SI			


UNIT NUMBER	AREA OF VENTED ATTIC SPACE (SF)	REQUIRED 1/300 (SI)
UNIT A.1 / A.1M UNIT A.2	767 SF 764 SF	368 SI 367 SI
UNIT B.1 / B.1M UNIT B.2	728 SF 730 SF	350 SI 351 SI

GENERAL NOTES - FLOOR PLANS


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9. SEE GENERAL SHEETS FOR CODE, DIMENSIONING AND GENERAL NOTES
10. SEE SHEETS A5.11 TO A5.14 FOR ENLARGED 1/4" = 1'-0" PLANS

FLOOR PLAN KEY


- WALL
- CONC. WALL
- 1-HR RATED WALL
- 1-HR RATED FLOOR OR ROOF AREA
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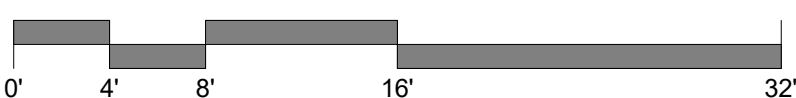
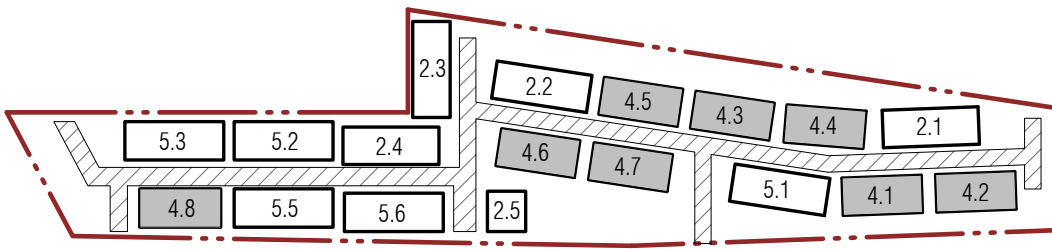
4-PACK TOWNHOUSE "A-B-A-B" ROOF PLAN
1/8" = 1'-0"

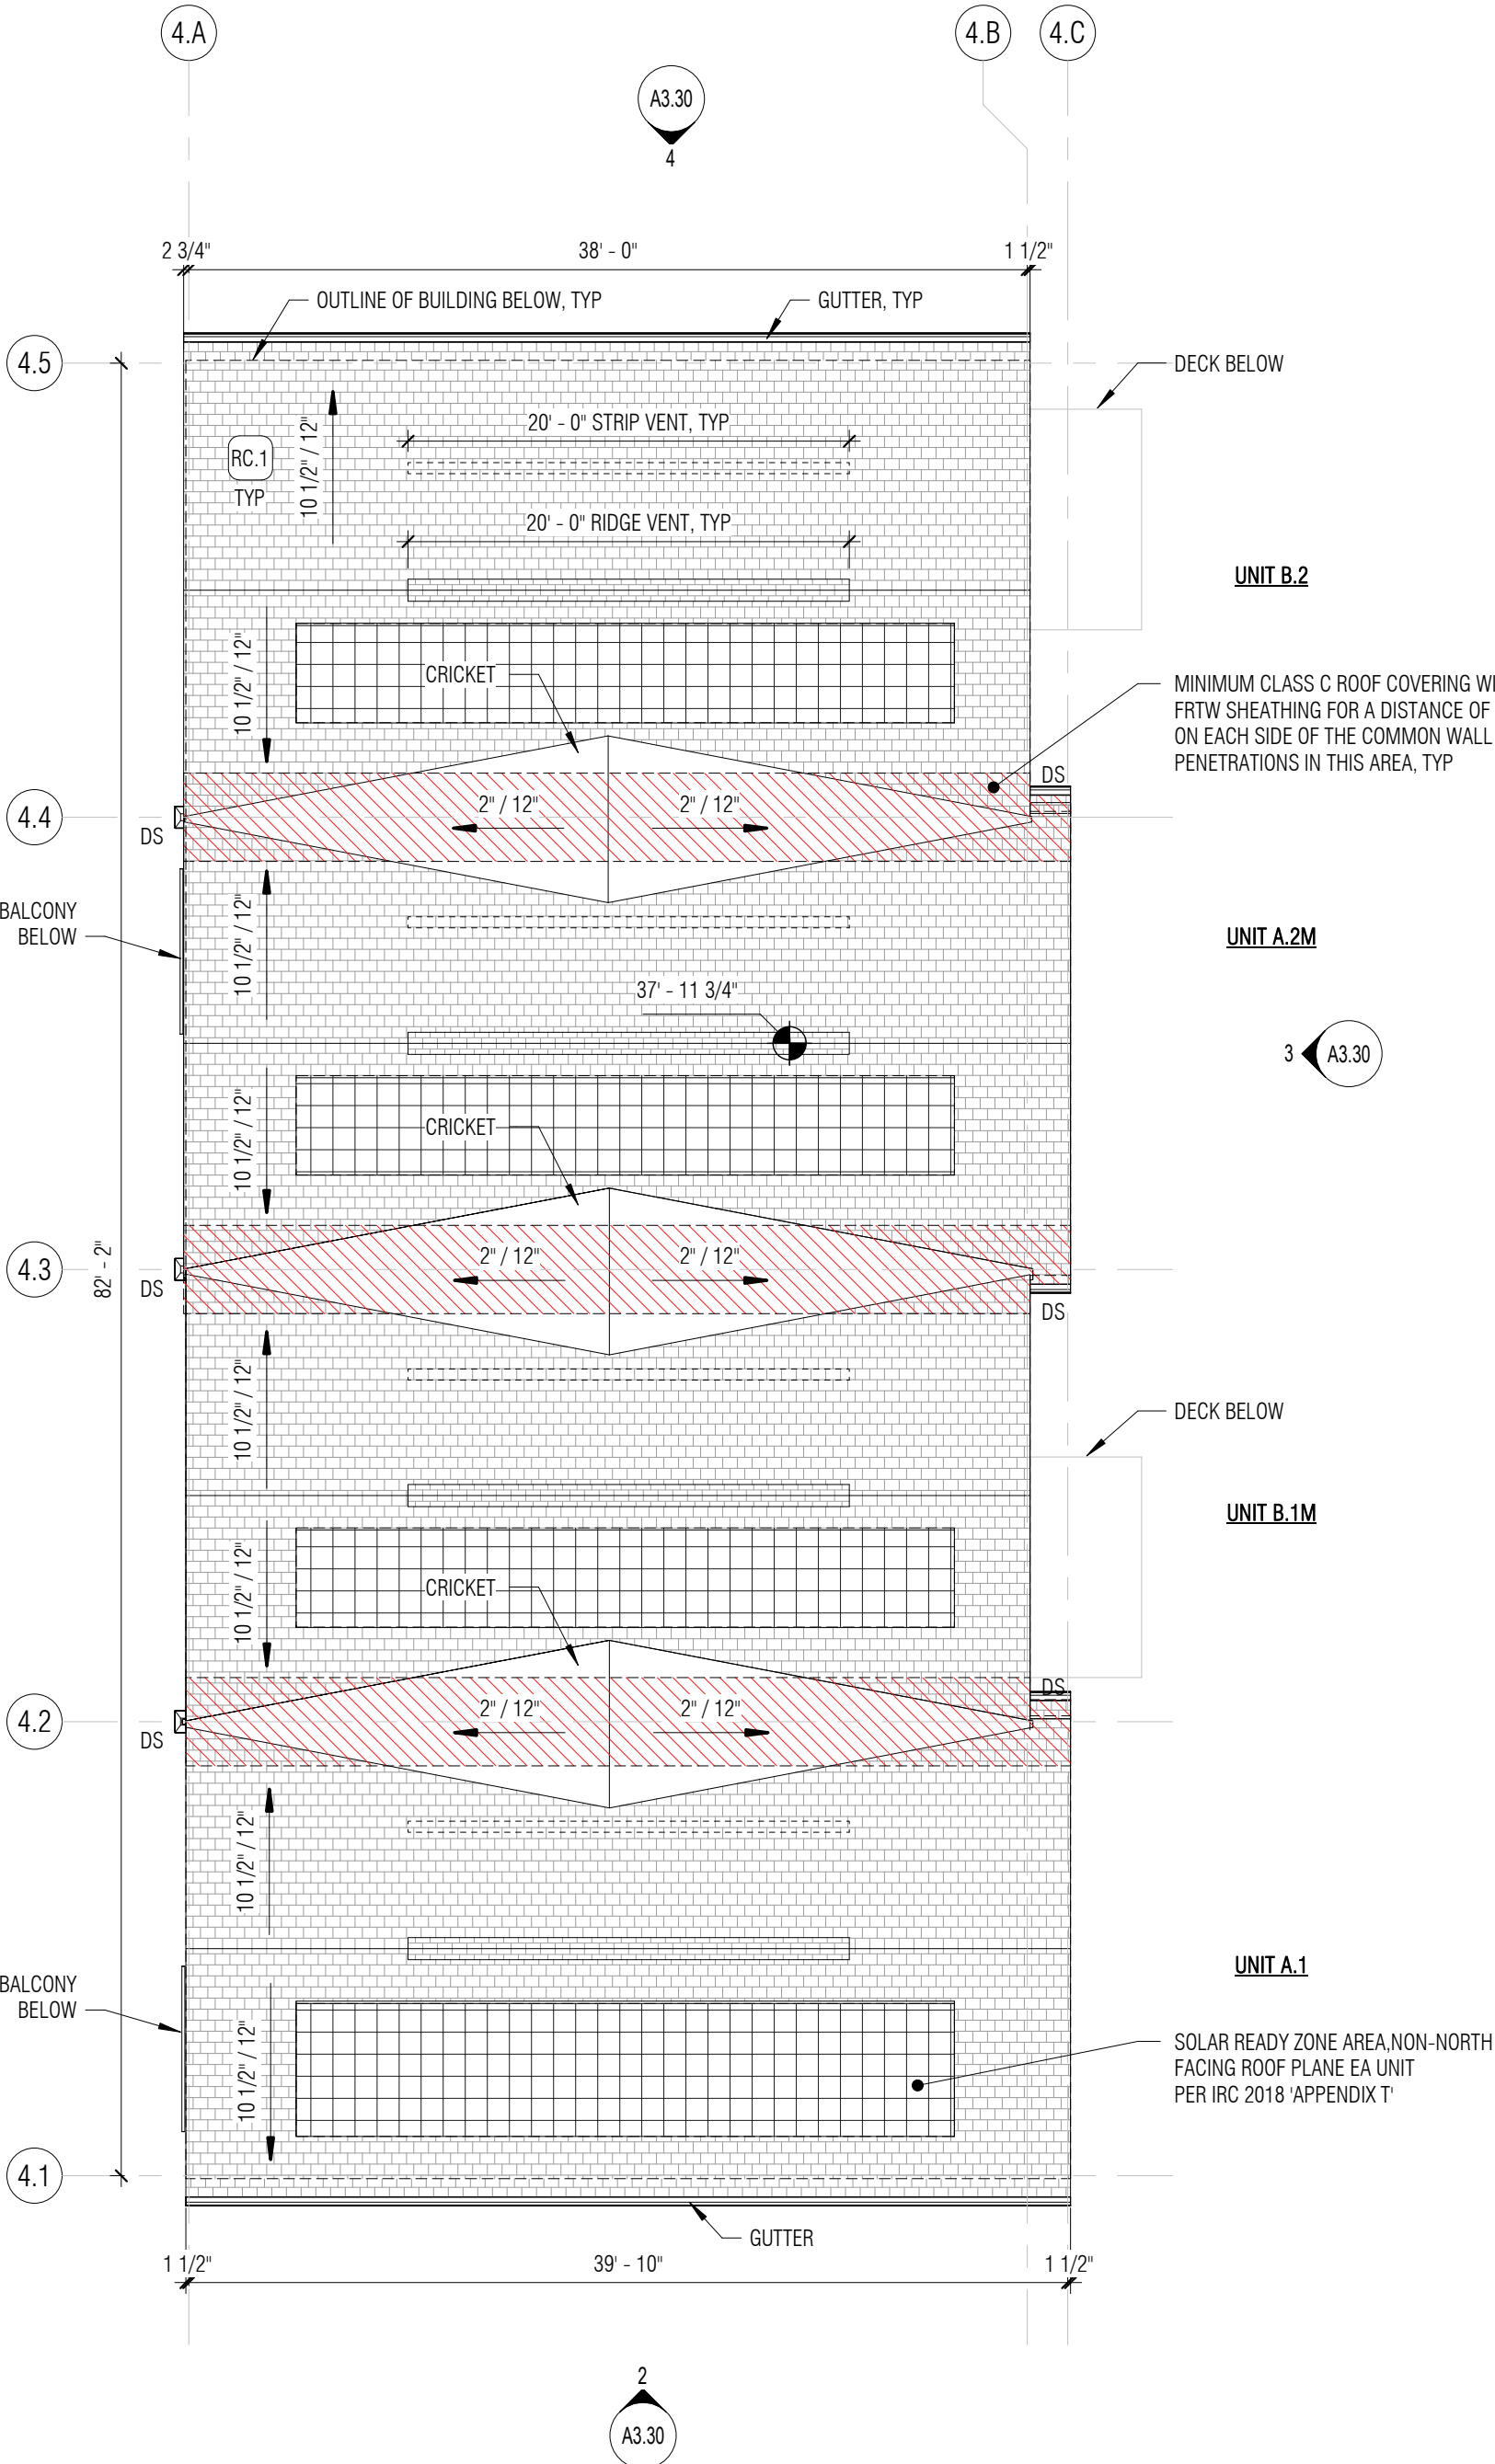

4-PACK TOWNHOUSE "A-B-A-B" FLOOR PLAN - LEVEL 3
1/8" = 1'-0"

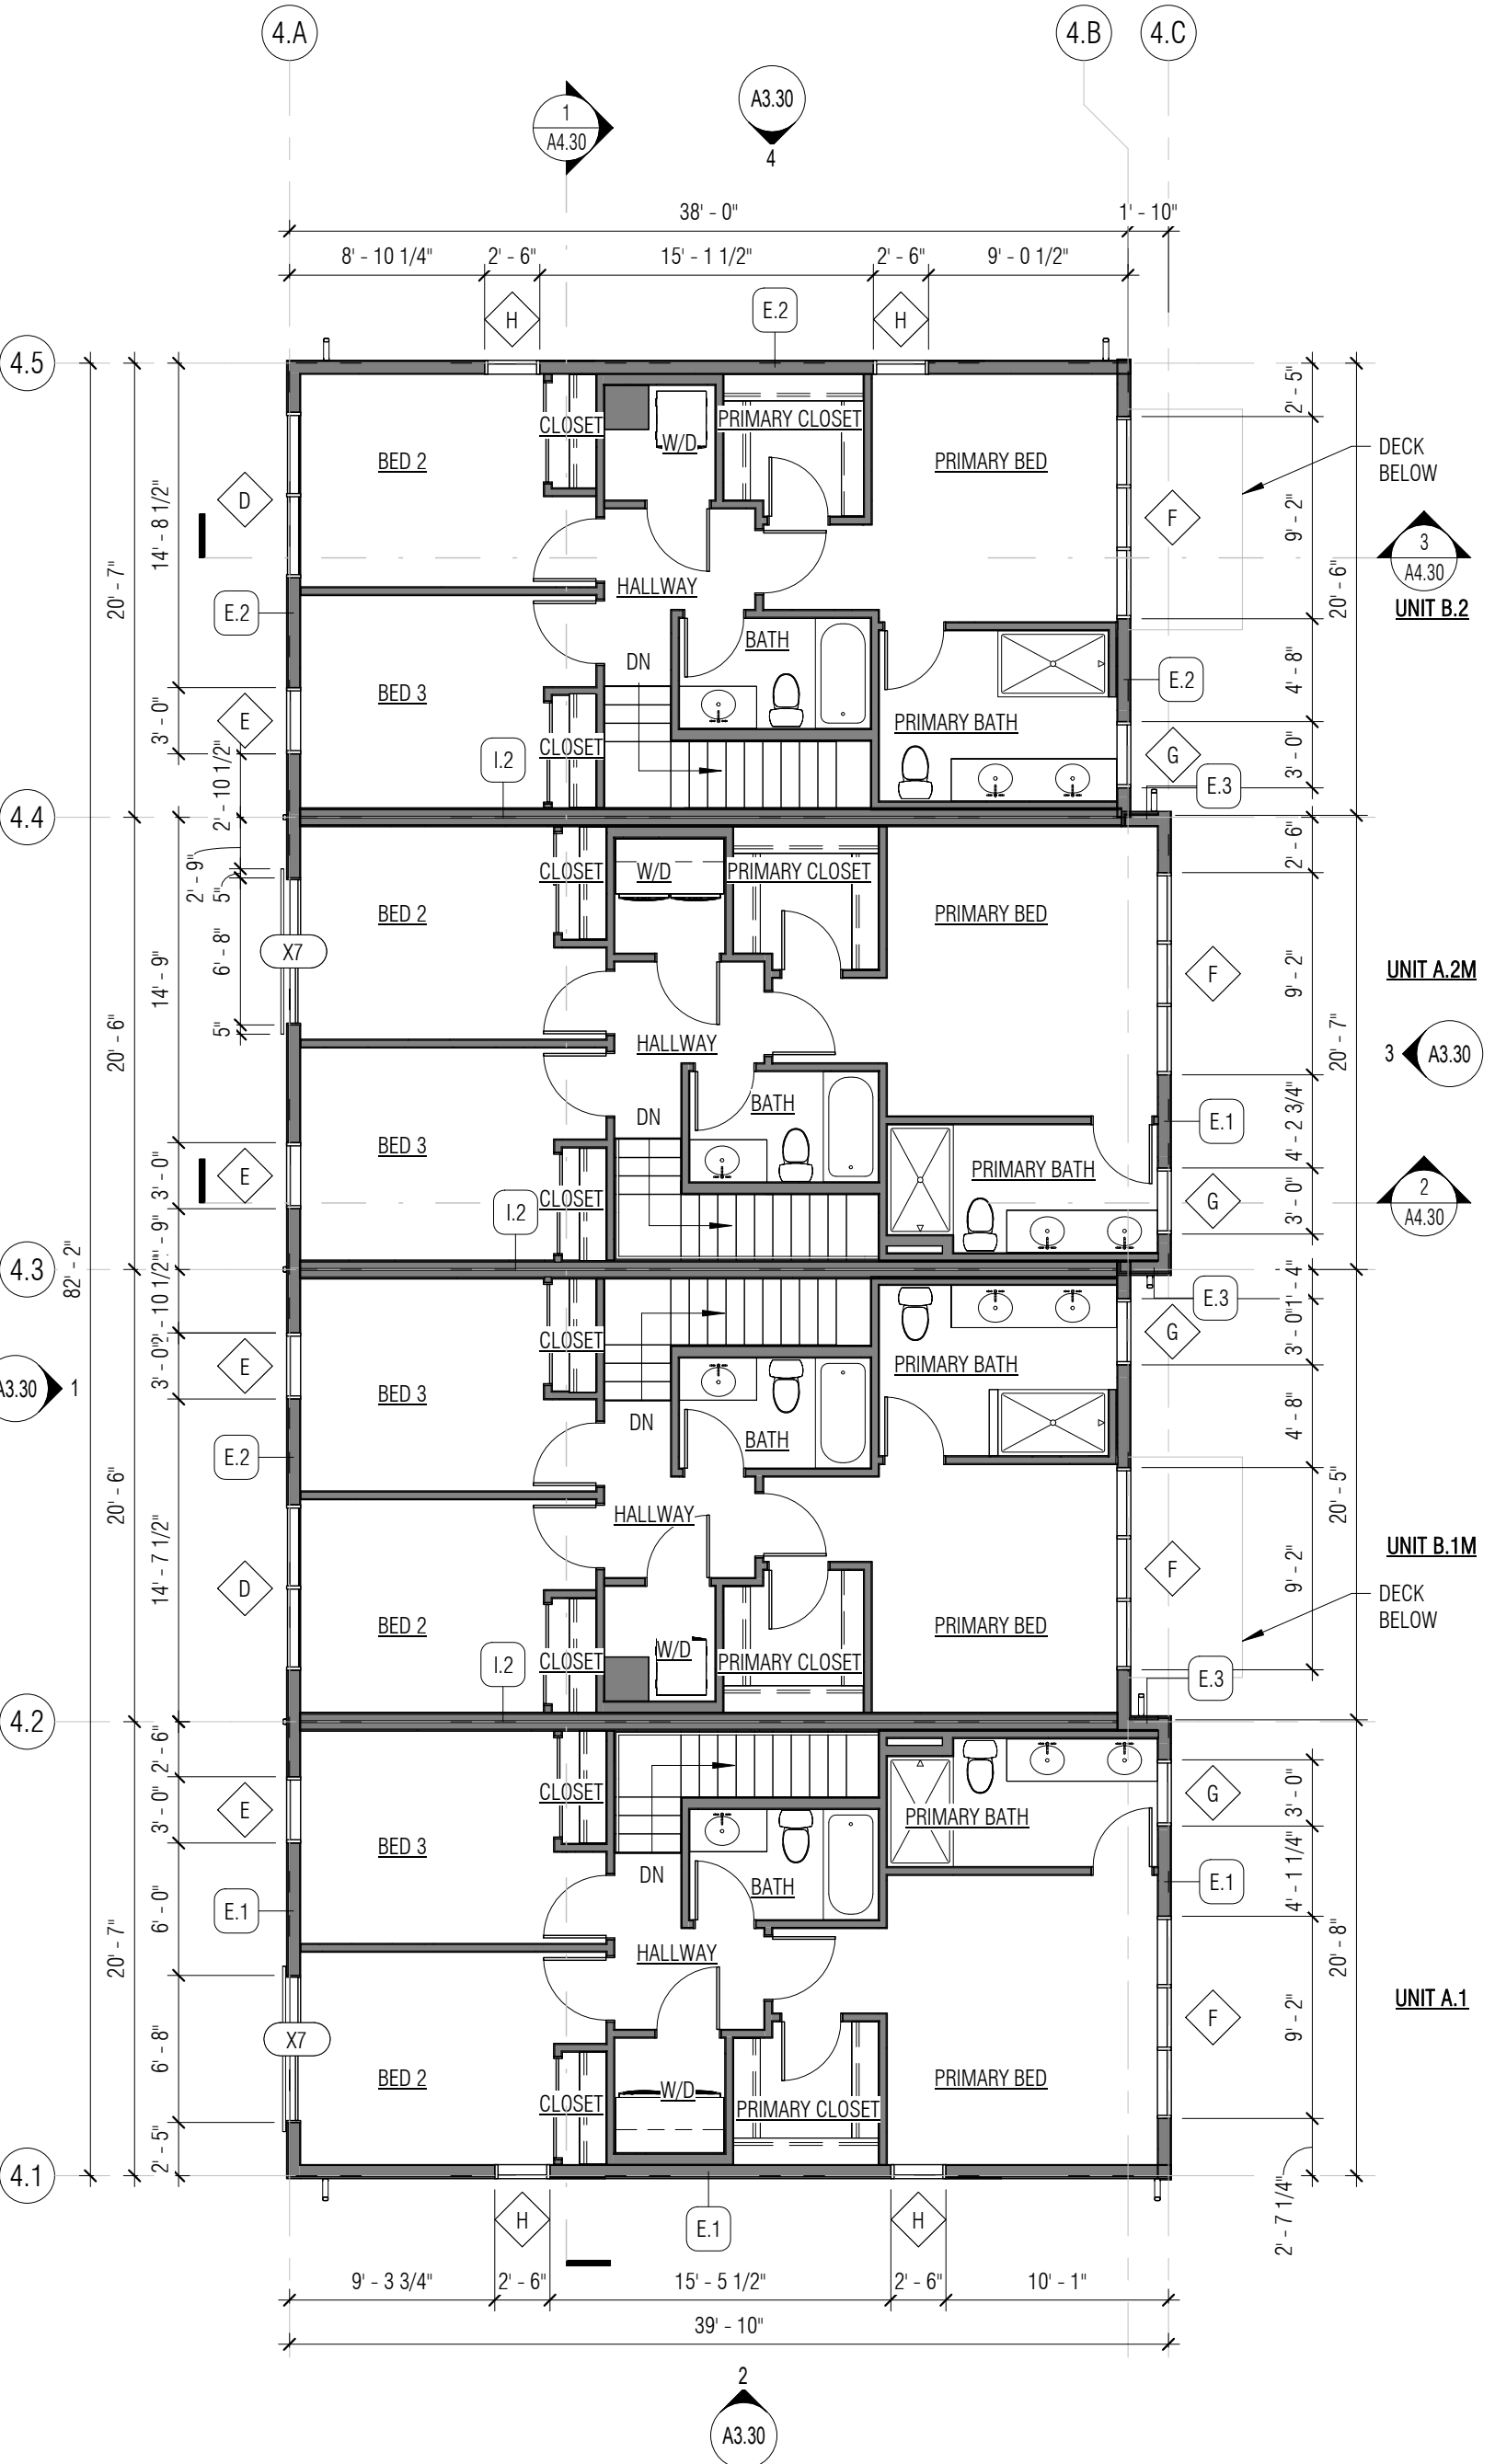

4-PACK TOWNHOUSE "A-B-A-B" FLOOR PLAN - LEVEL 2
1/8" = 1'-0"

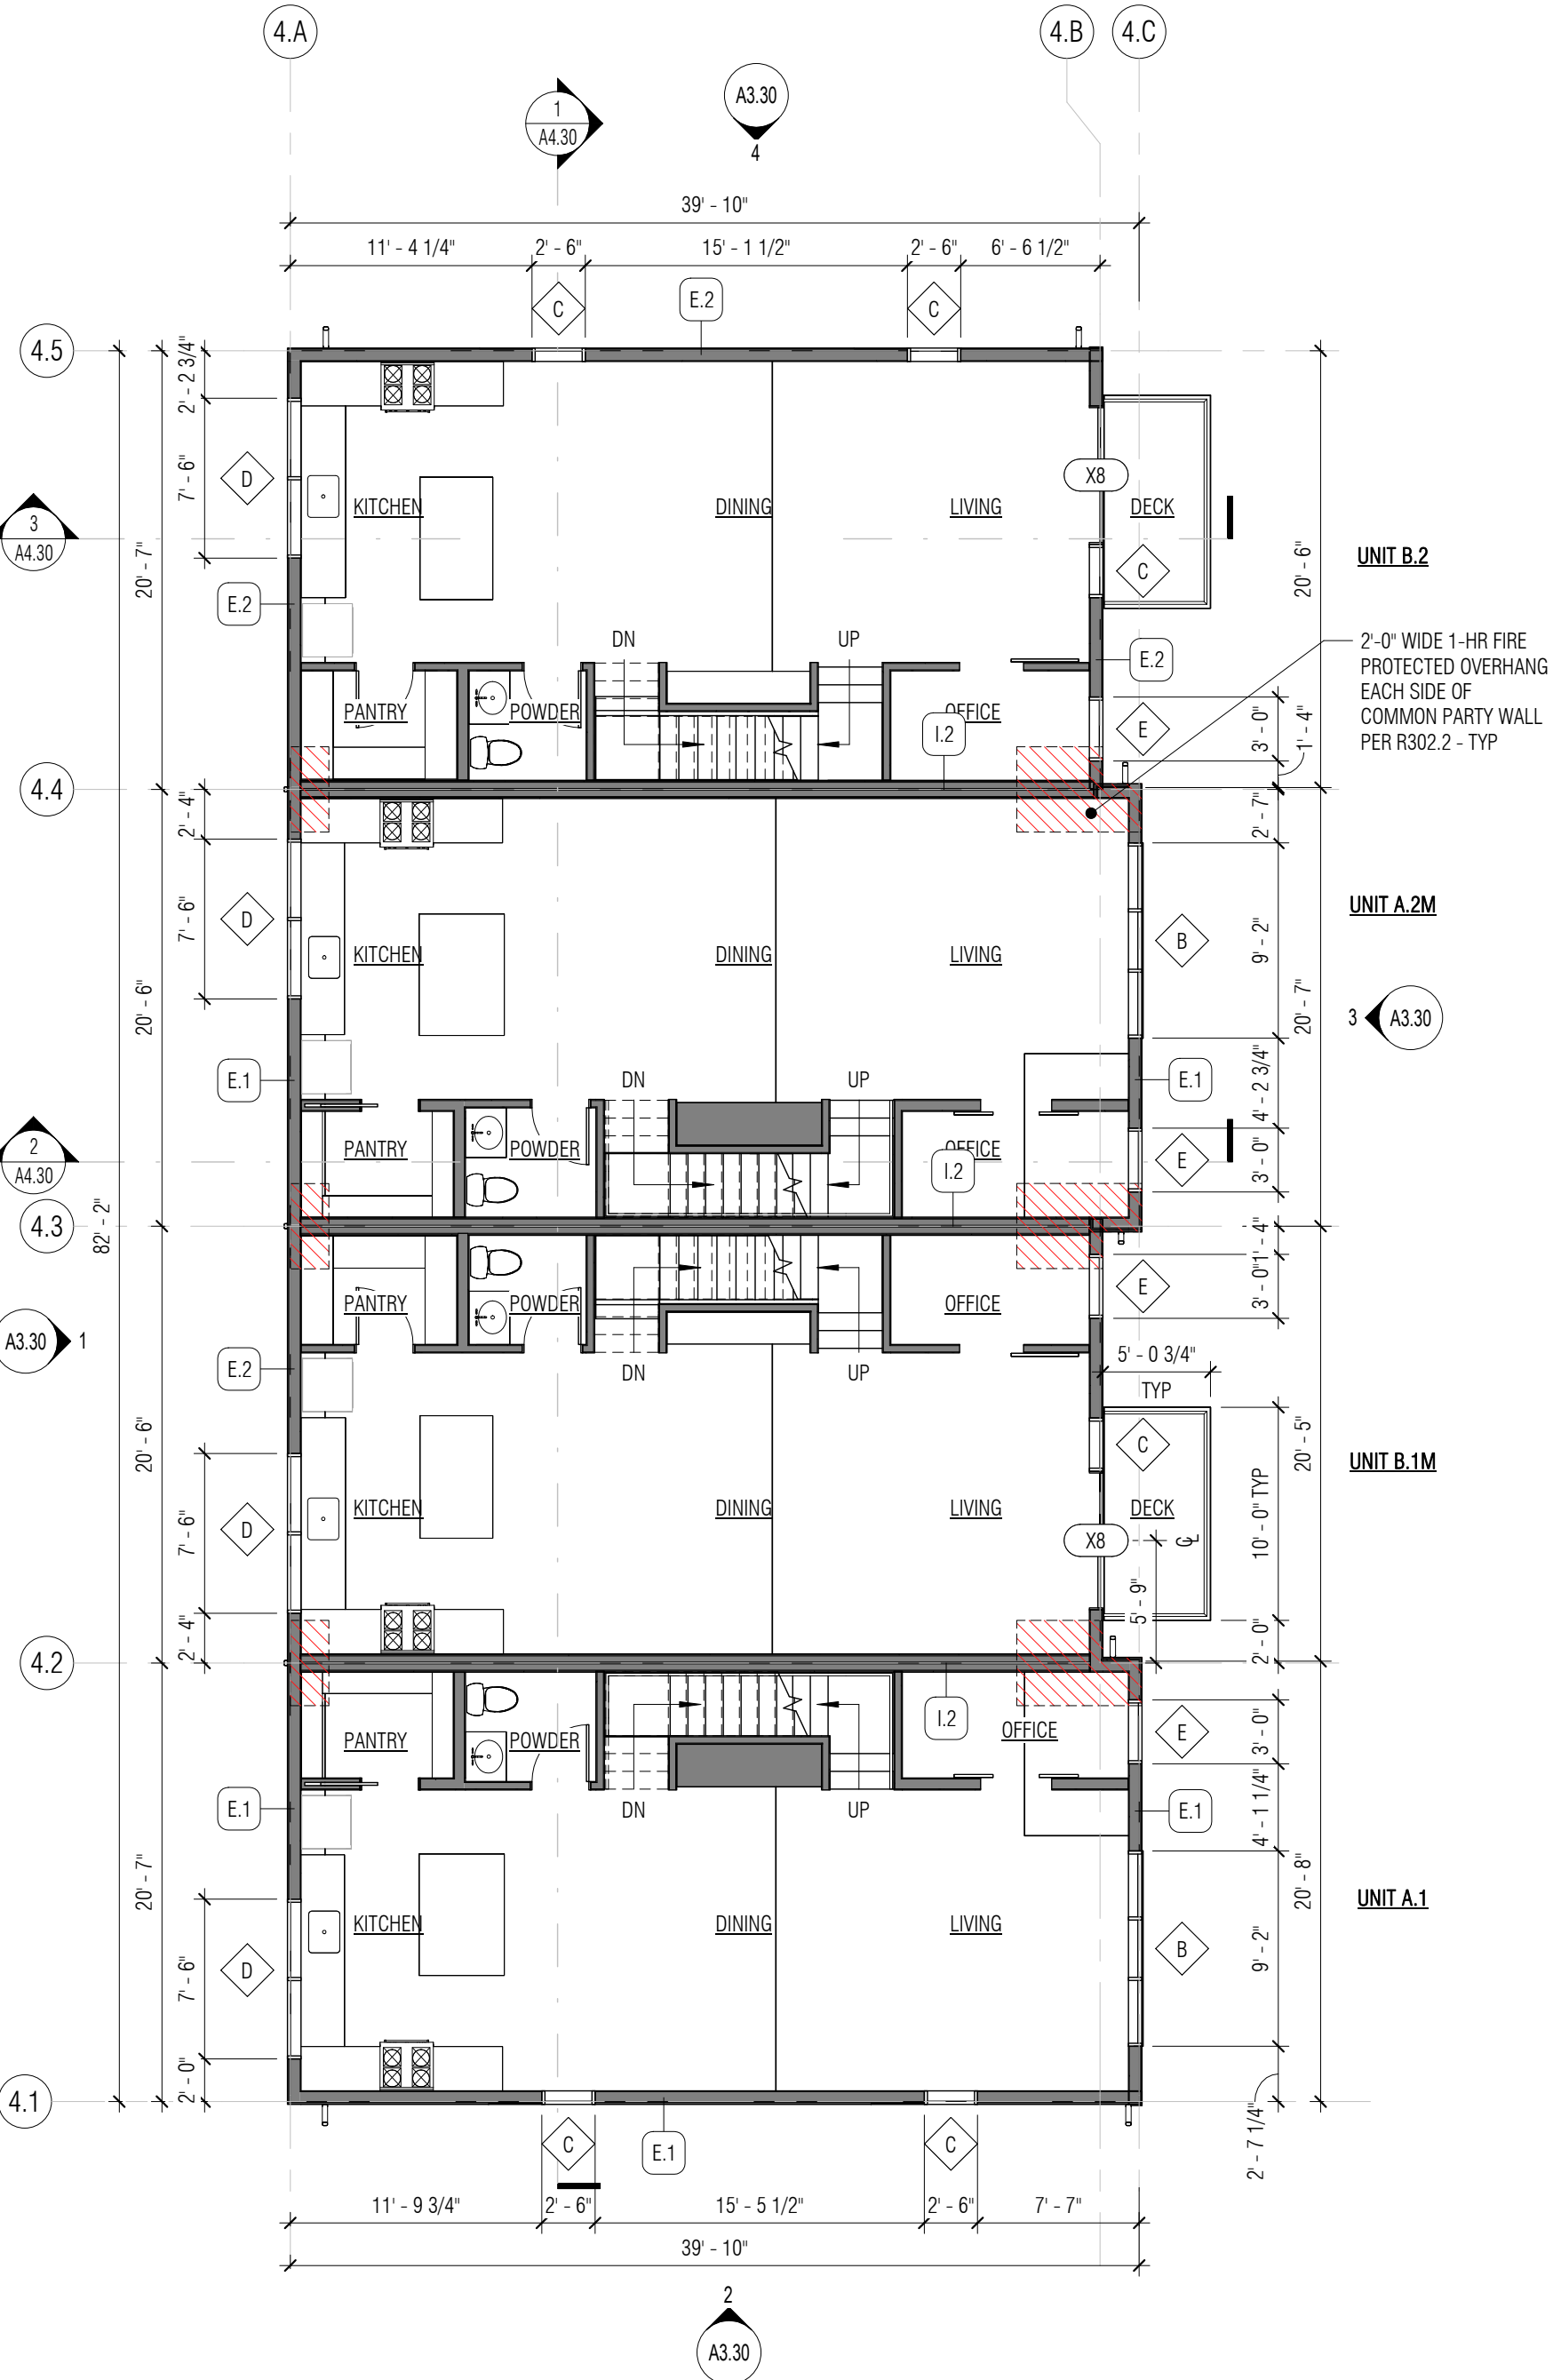


GENERAL NOTES - FLOOR PLANS

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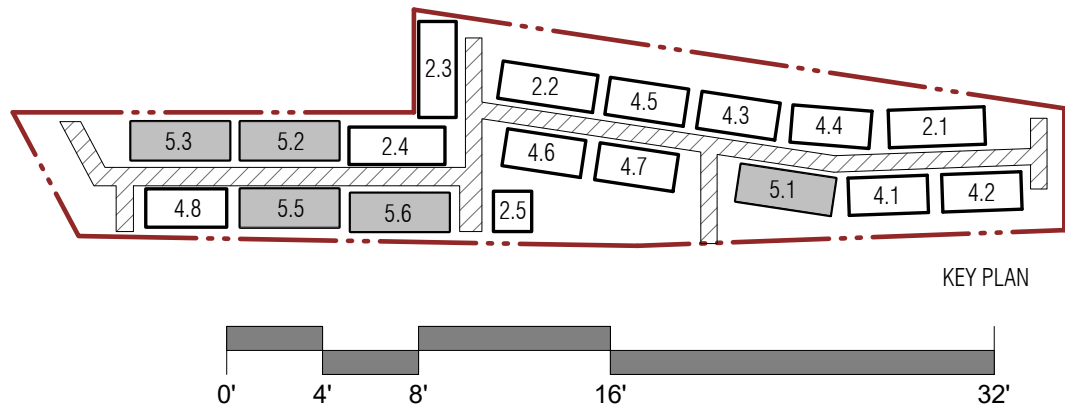
- WALL
- CONC. WALL
- 1-HR RATED WALL
- 1-HR RATED FLOOR OR ROOF AREA
- STRIP VENT
- SOLAR READY ZONE



1 5-PACK TOWNHOUSE "A-B-A-B-A" FLOOR PLAN - LEVEL 1

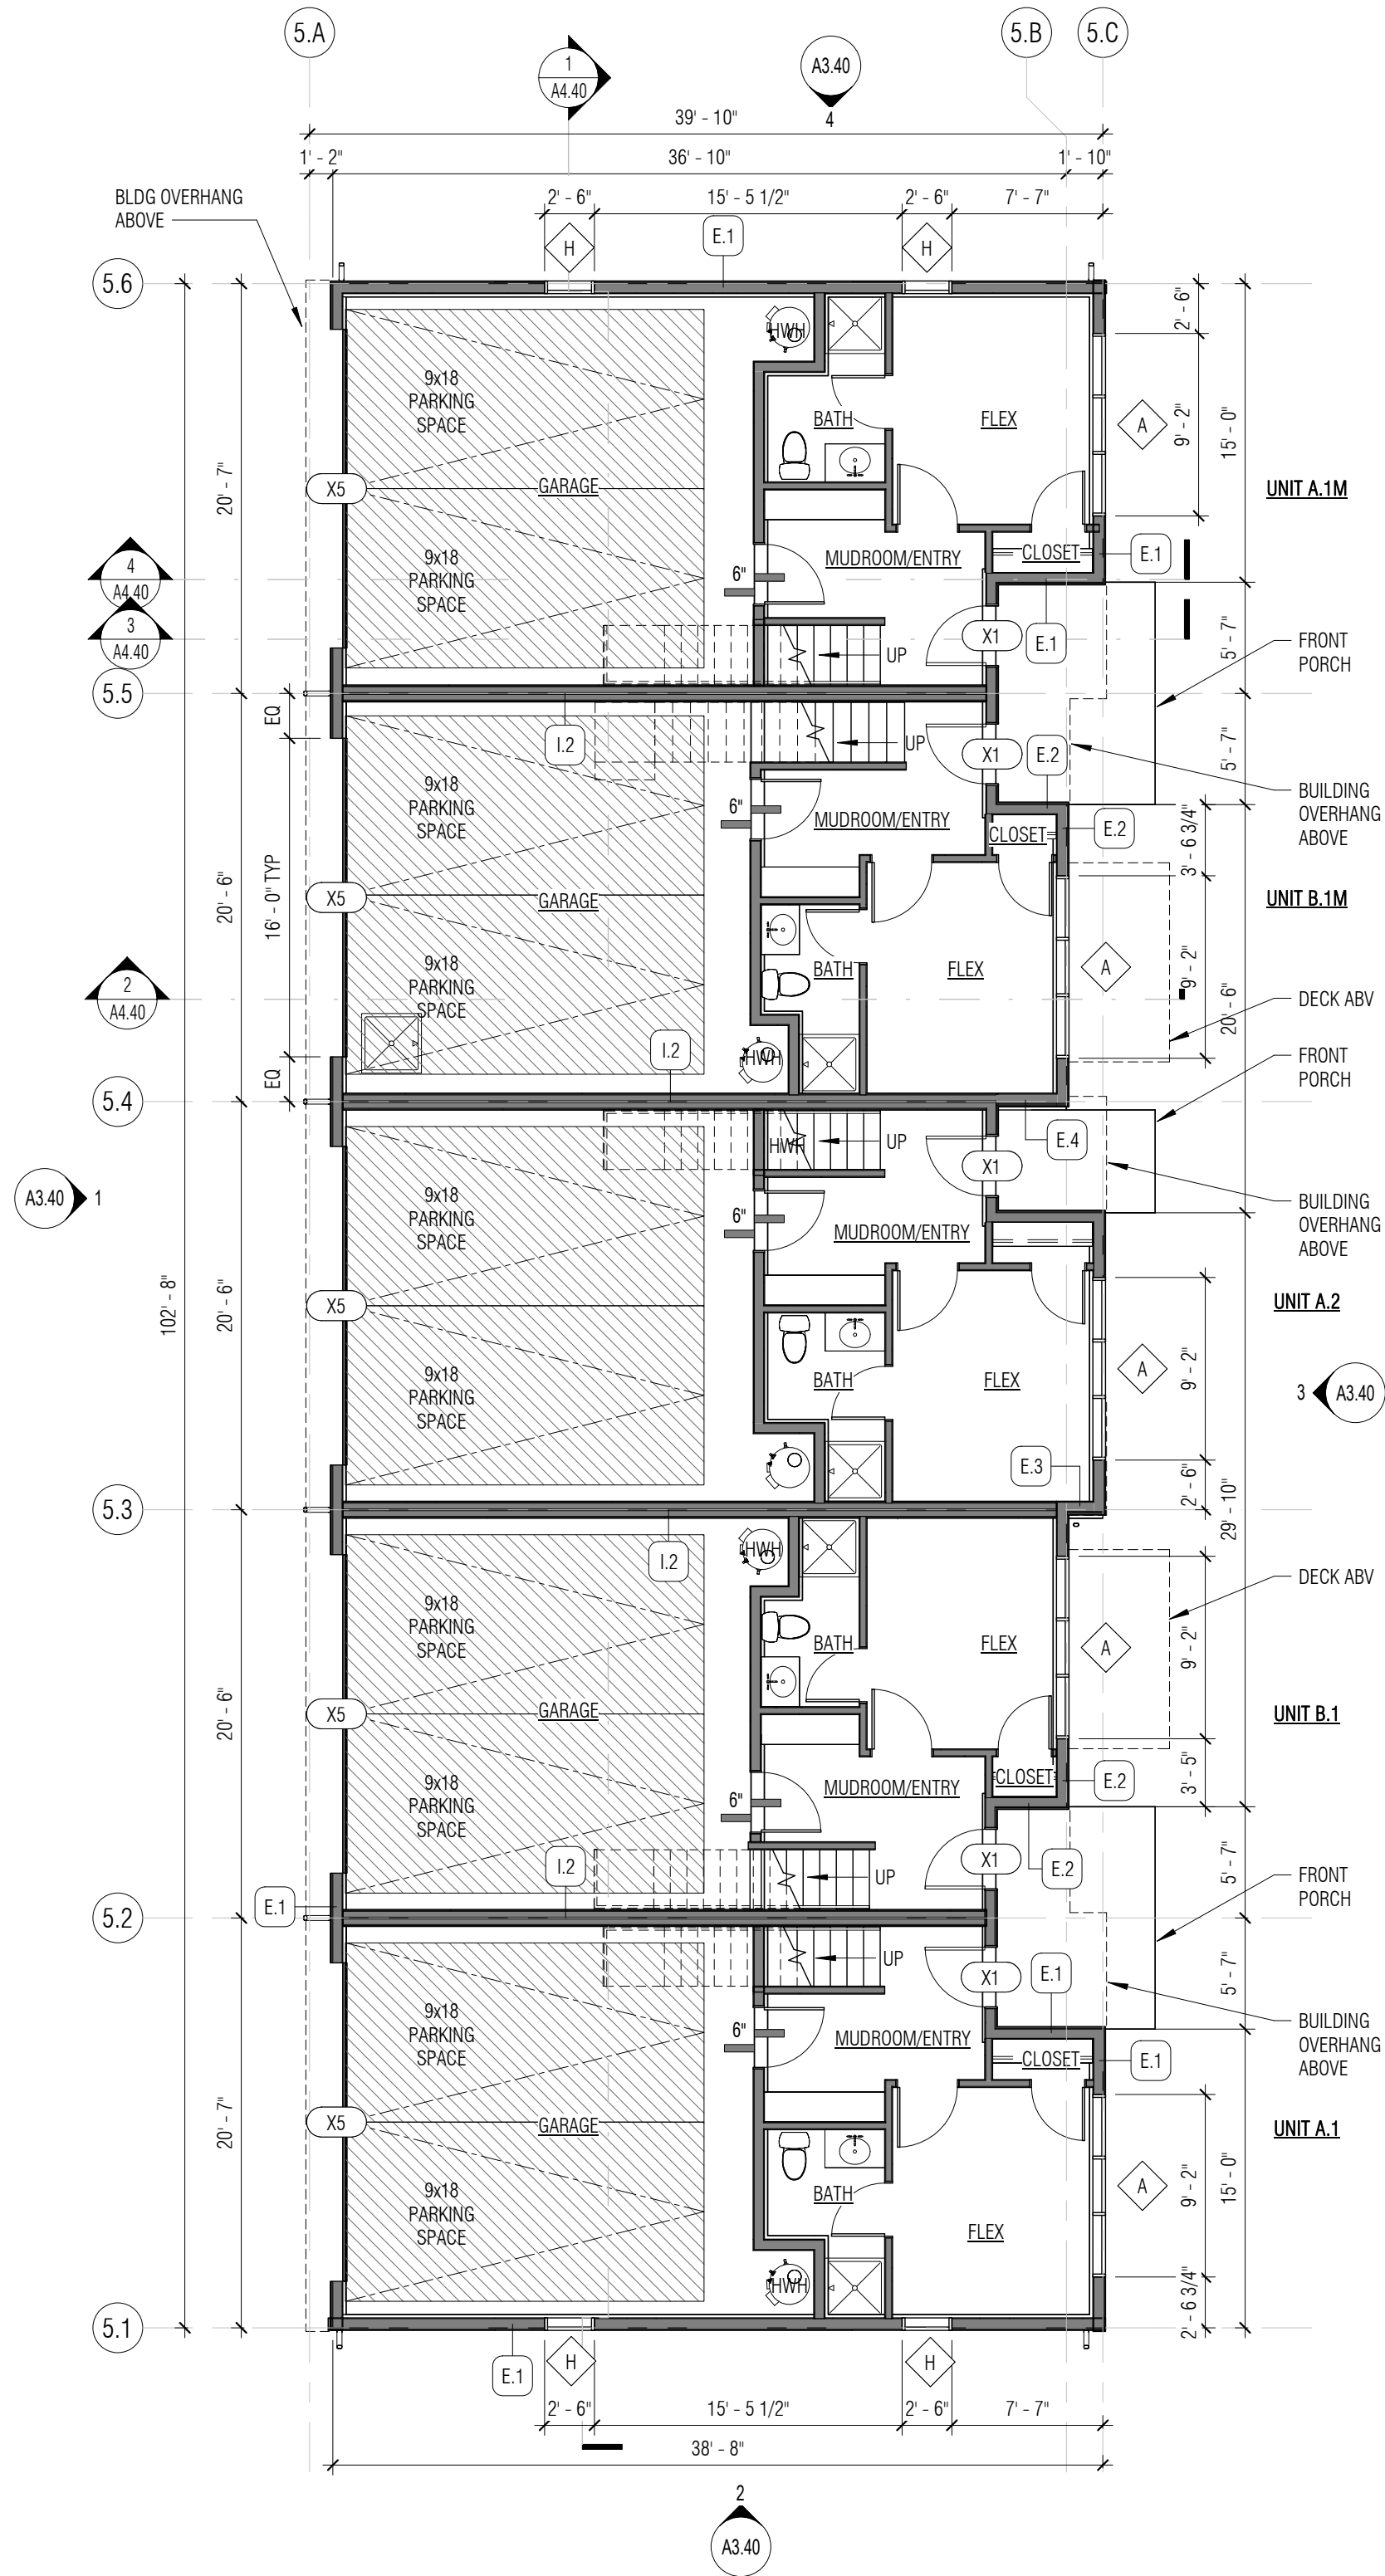1/8" = 1'-0"

FLOOR PLAN - LEVEL 1 FOR BLDGS 5.2, 5.3, SEE A2.41
FLOOR PLAN - LEVEL 1 FOR BLDGS 5.4, 5.5, 5.6, SEE A2.42



ROOF VENTILATION CALCULATIONS

REFERENCE: 2018 INTERNATIONAL RESIDENTIAL CODE SECTION R806

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UNIT	AREA OF VENTED ATTIC (SF)	TOTAL REQ. VENT AREA = 1/300 OF AREA	VENTS PROVIDED	NET FREE OPENING AREA PER LINEAL FOOT (SI)	AREA PROVIDED (SI)	% OF REQD
A.1 / A.1M / A.2	767	368 SI	RIDGE VENT: (1) 20' LONG STRIP VENT: (1) 20' LONG	10 10	200 200	50% 50%
MIN. REQD NET FREE AREA			PROVIDED NET FREE AREA			
			400 SI			



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B.1 / B.1M / B.2	730	351 SI	RIDGE VENT: (1) 20' LONG STRIP VENT: (1) 20' LONG	10 10	200 200	50% 50%
MIN. REQD NET FREE AREA			PROVIDED NET FREE AREA			
			400 SI			

UNIT NUMBER	AREA OF VENTED ATTIC SPACE (SF)	REQUIRED 1/300 (SI)
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UNIT A.2	764 SF	367 SI
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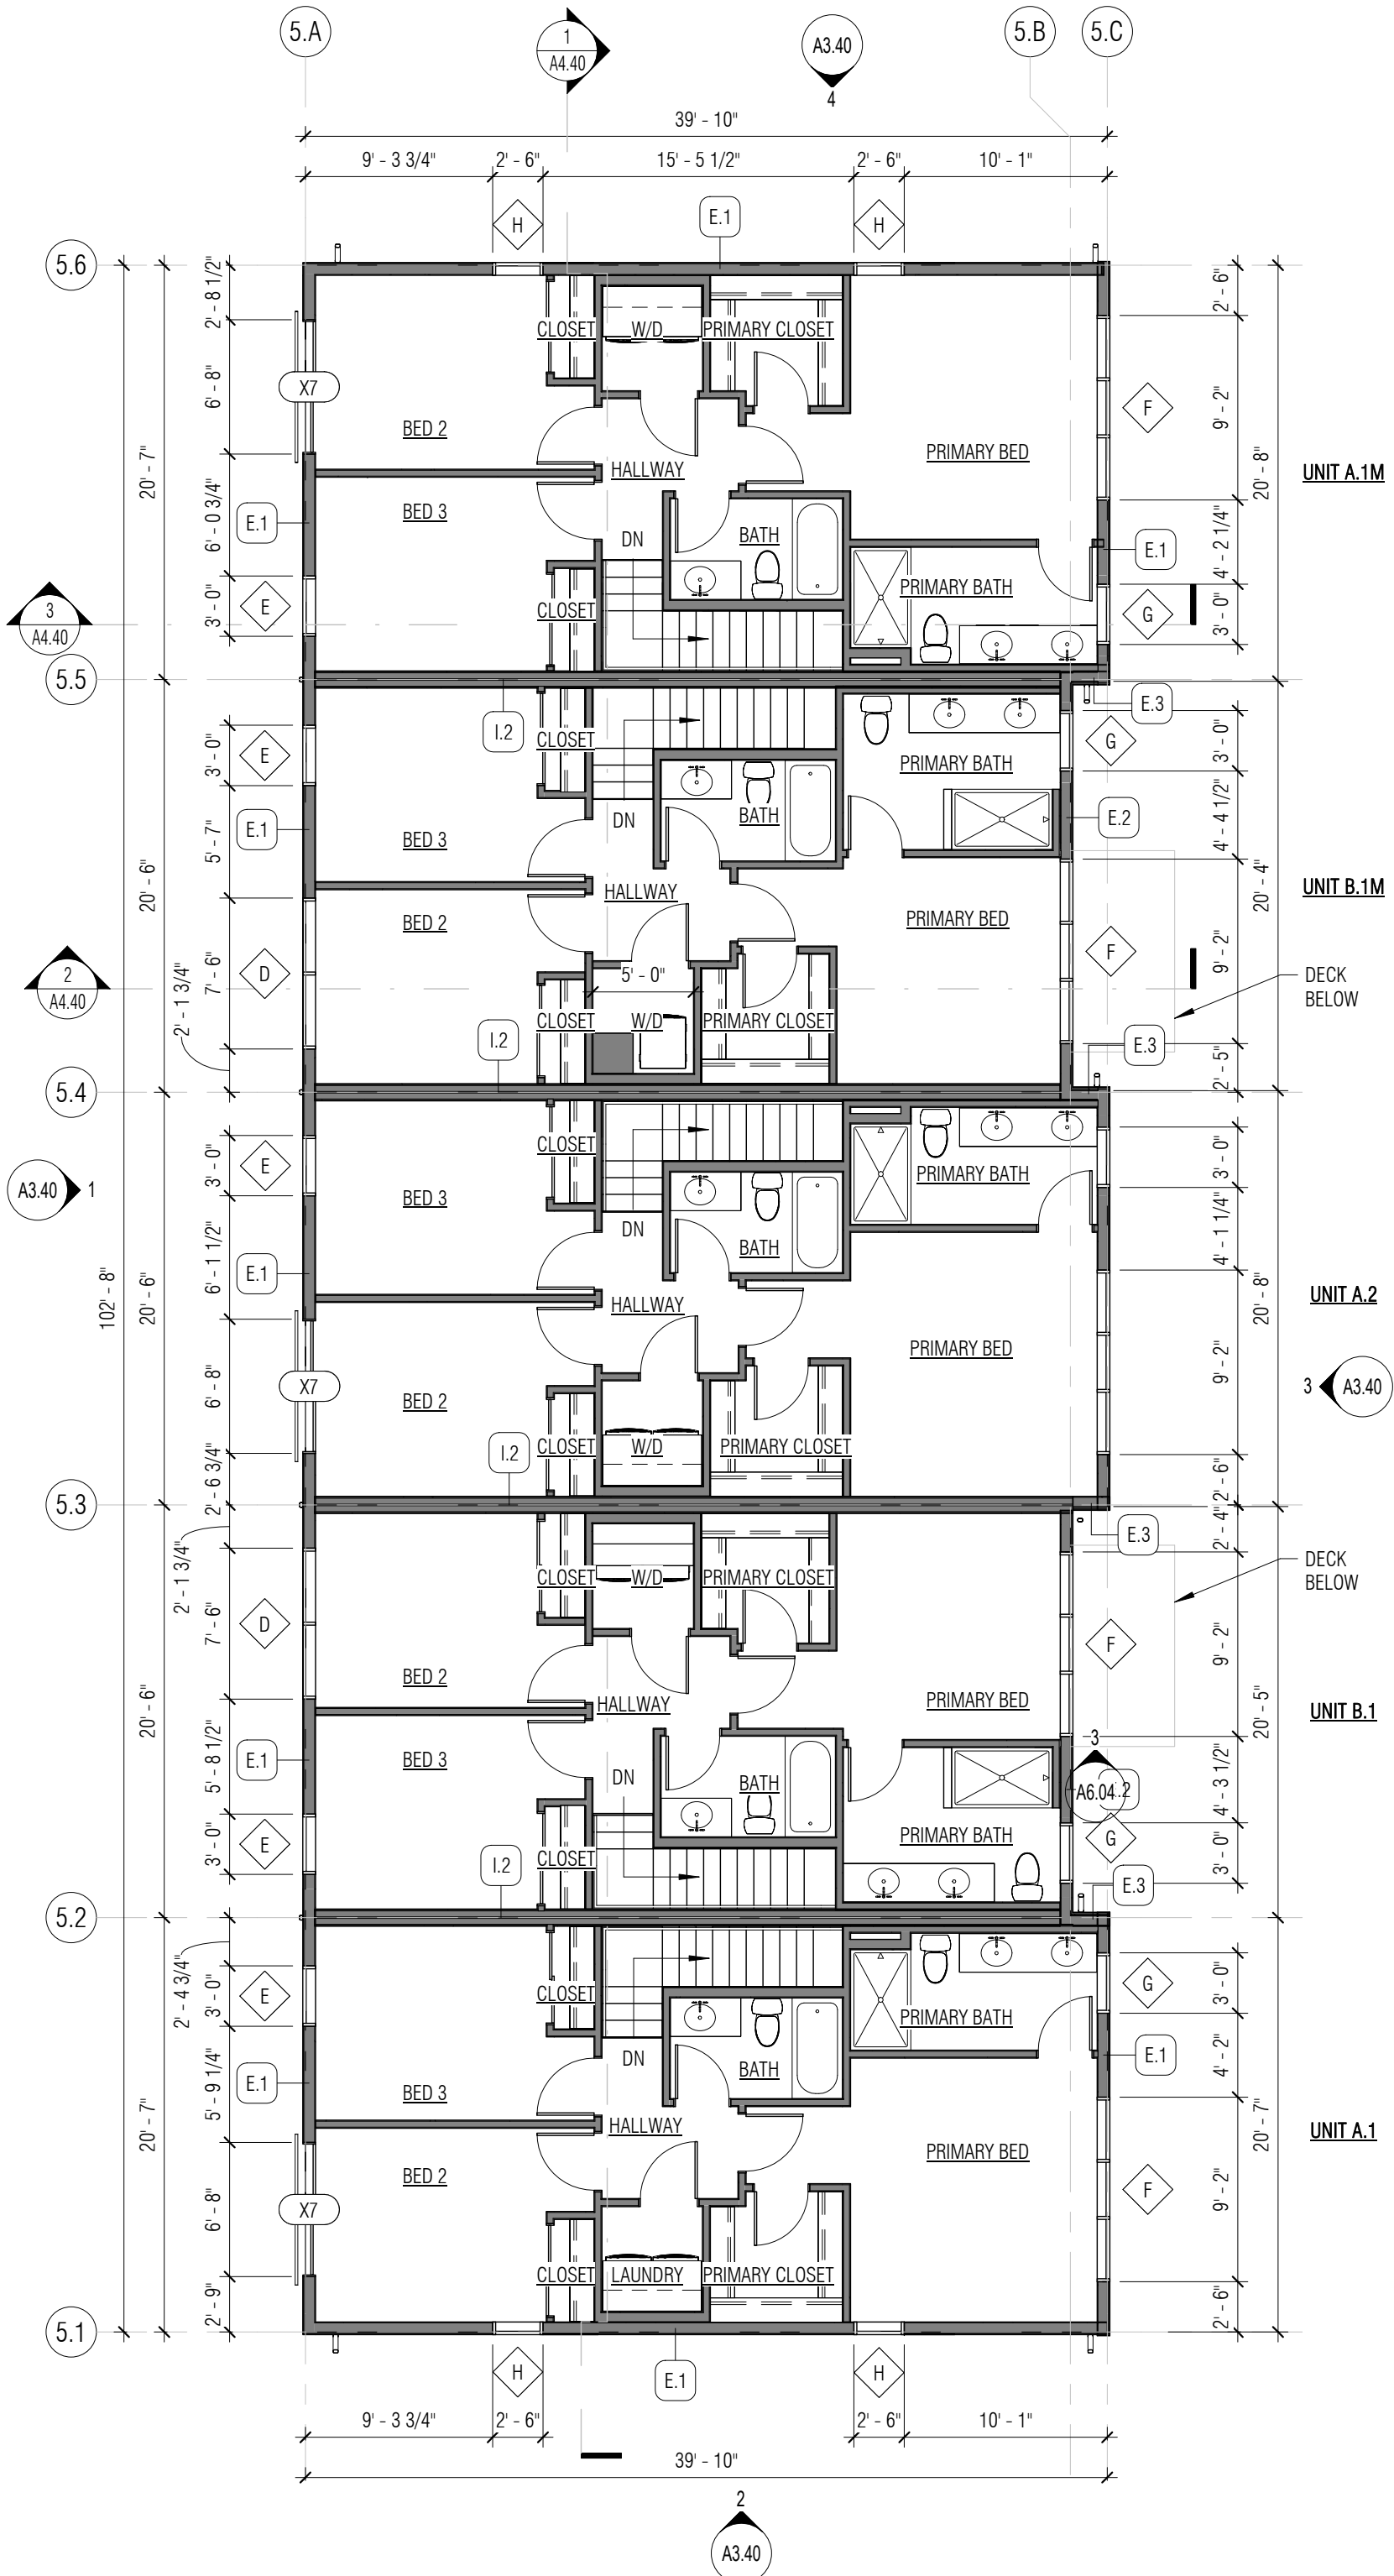
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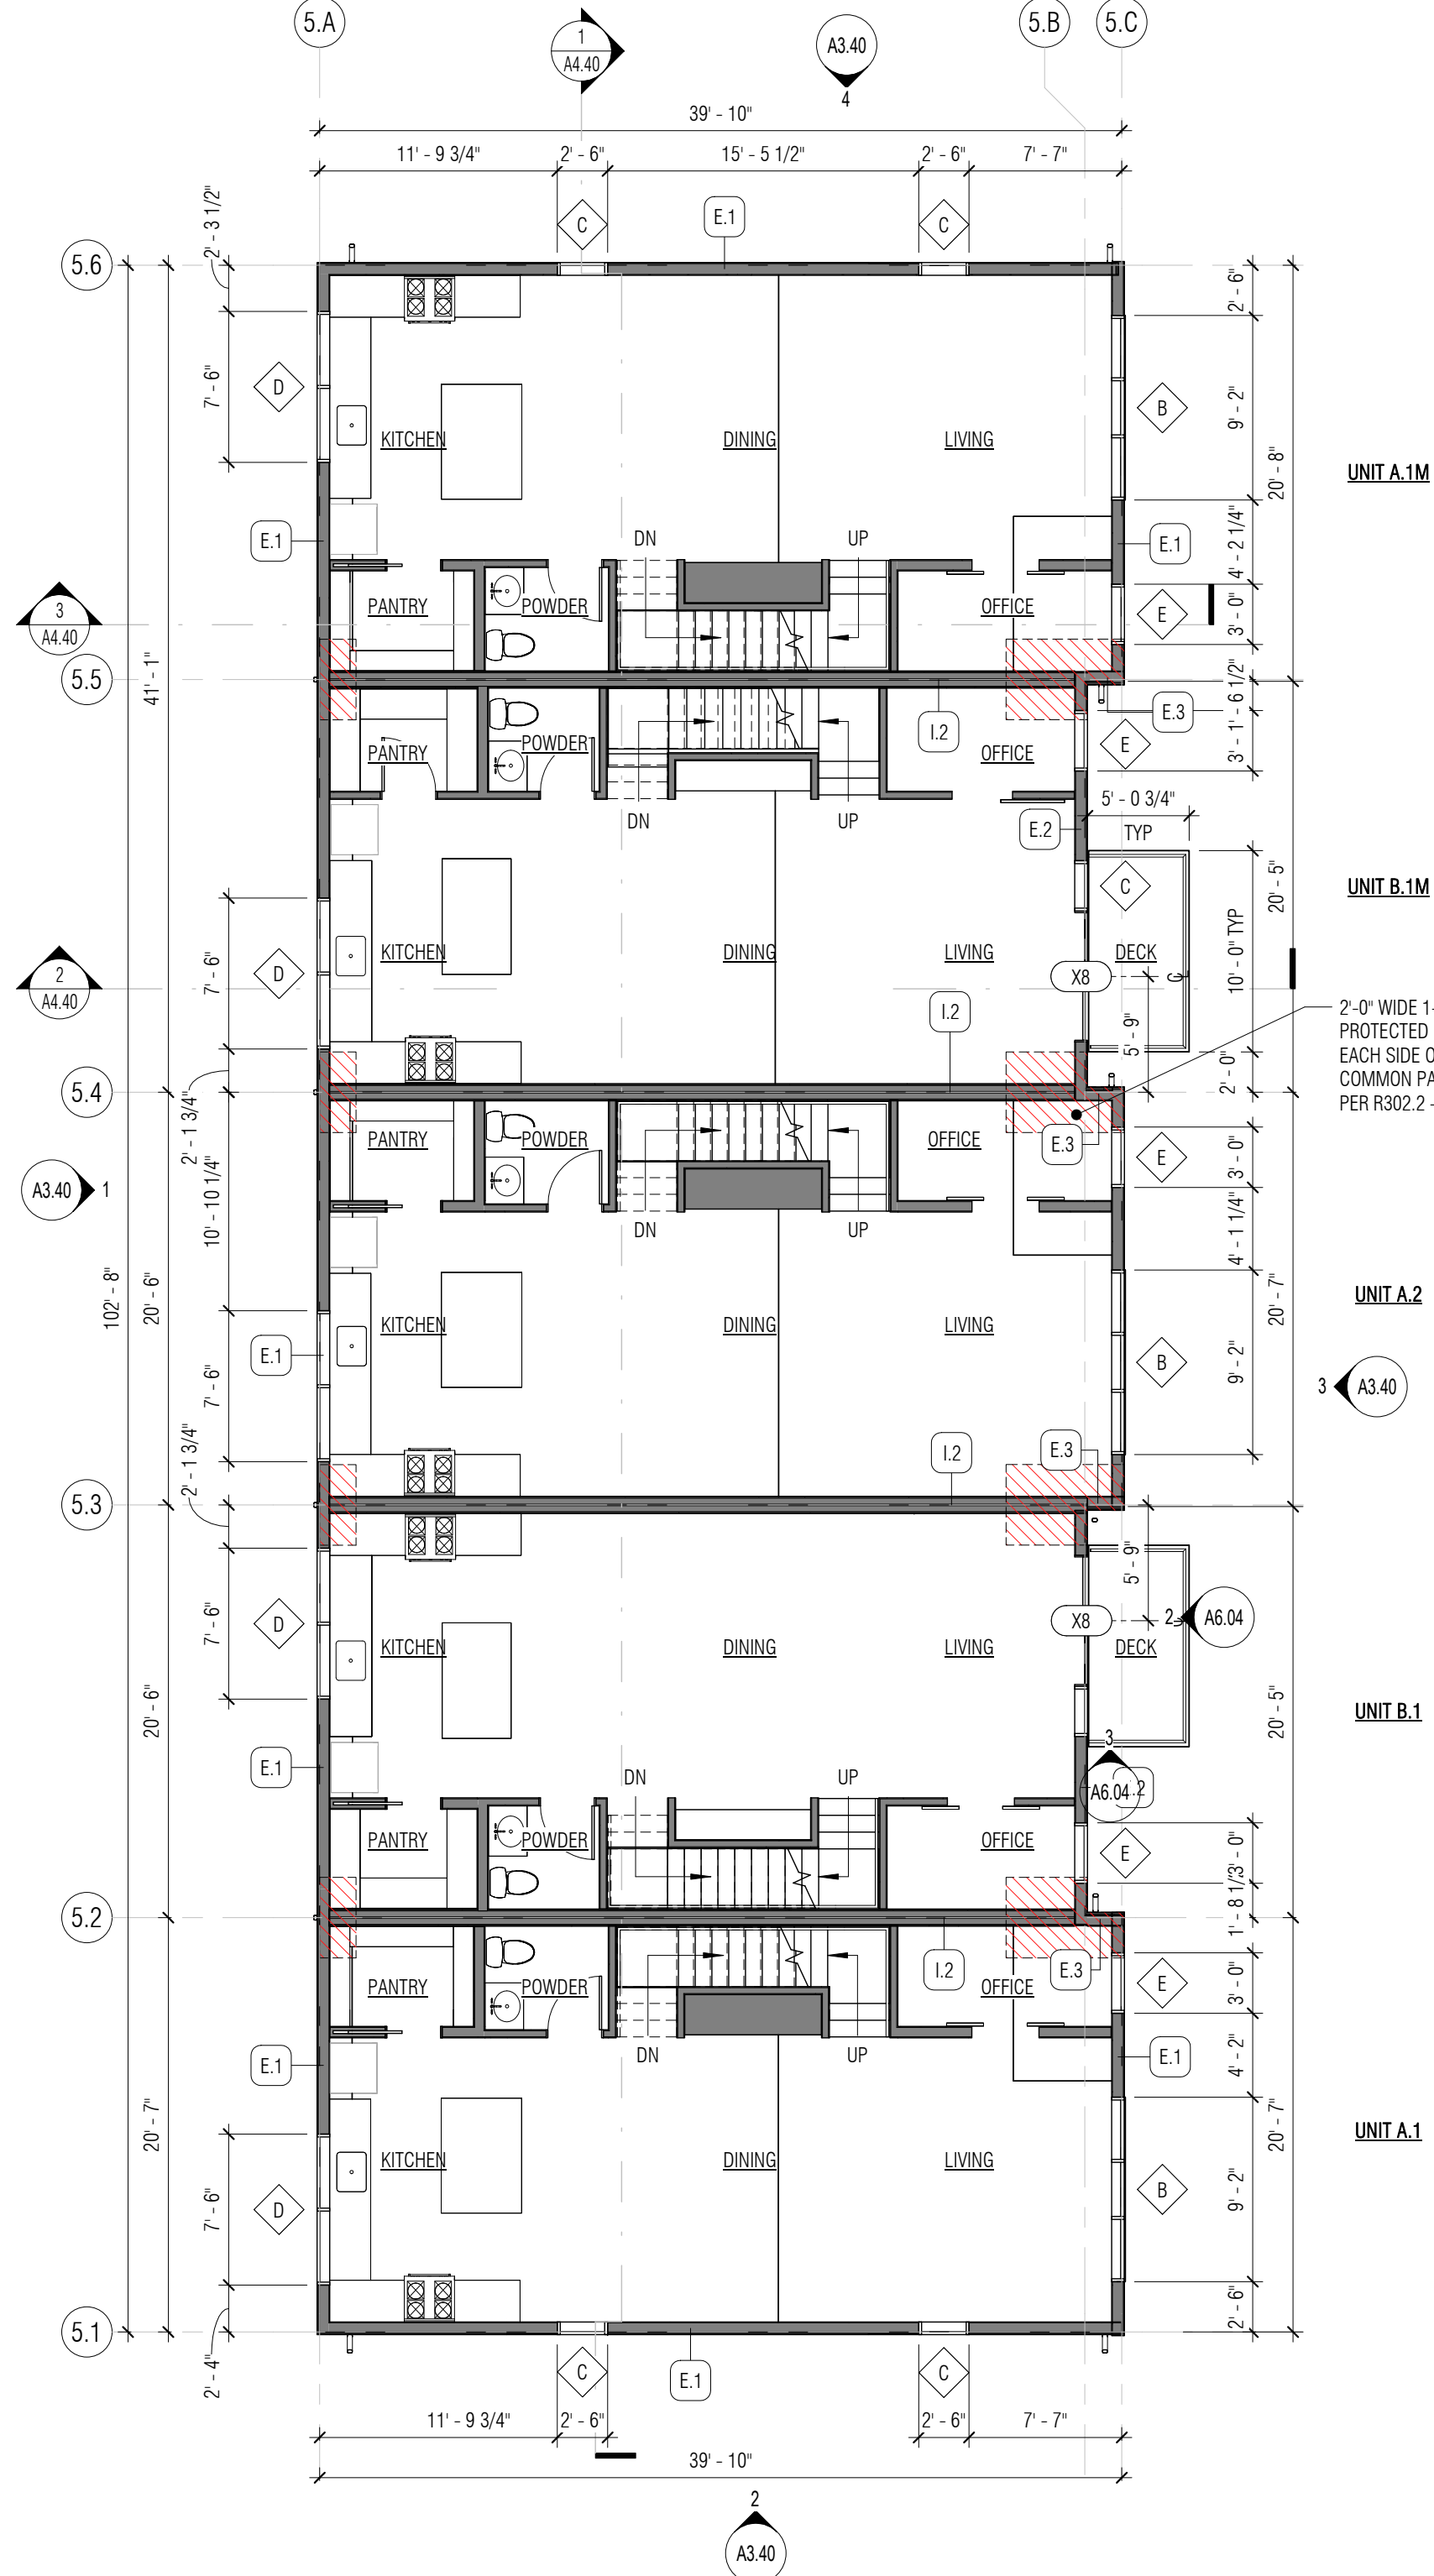
FLOOR PLAN KEY




3 5-PACK TOWNHOUSE "A-B-A-B-A" ROOF PLAN
1/8" = 1'-0"

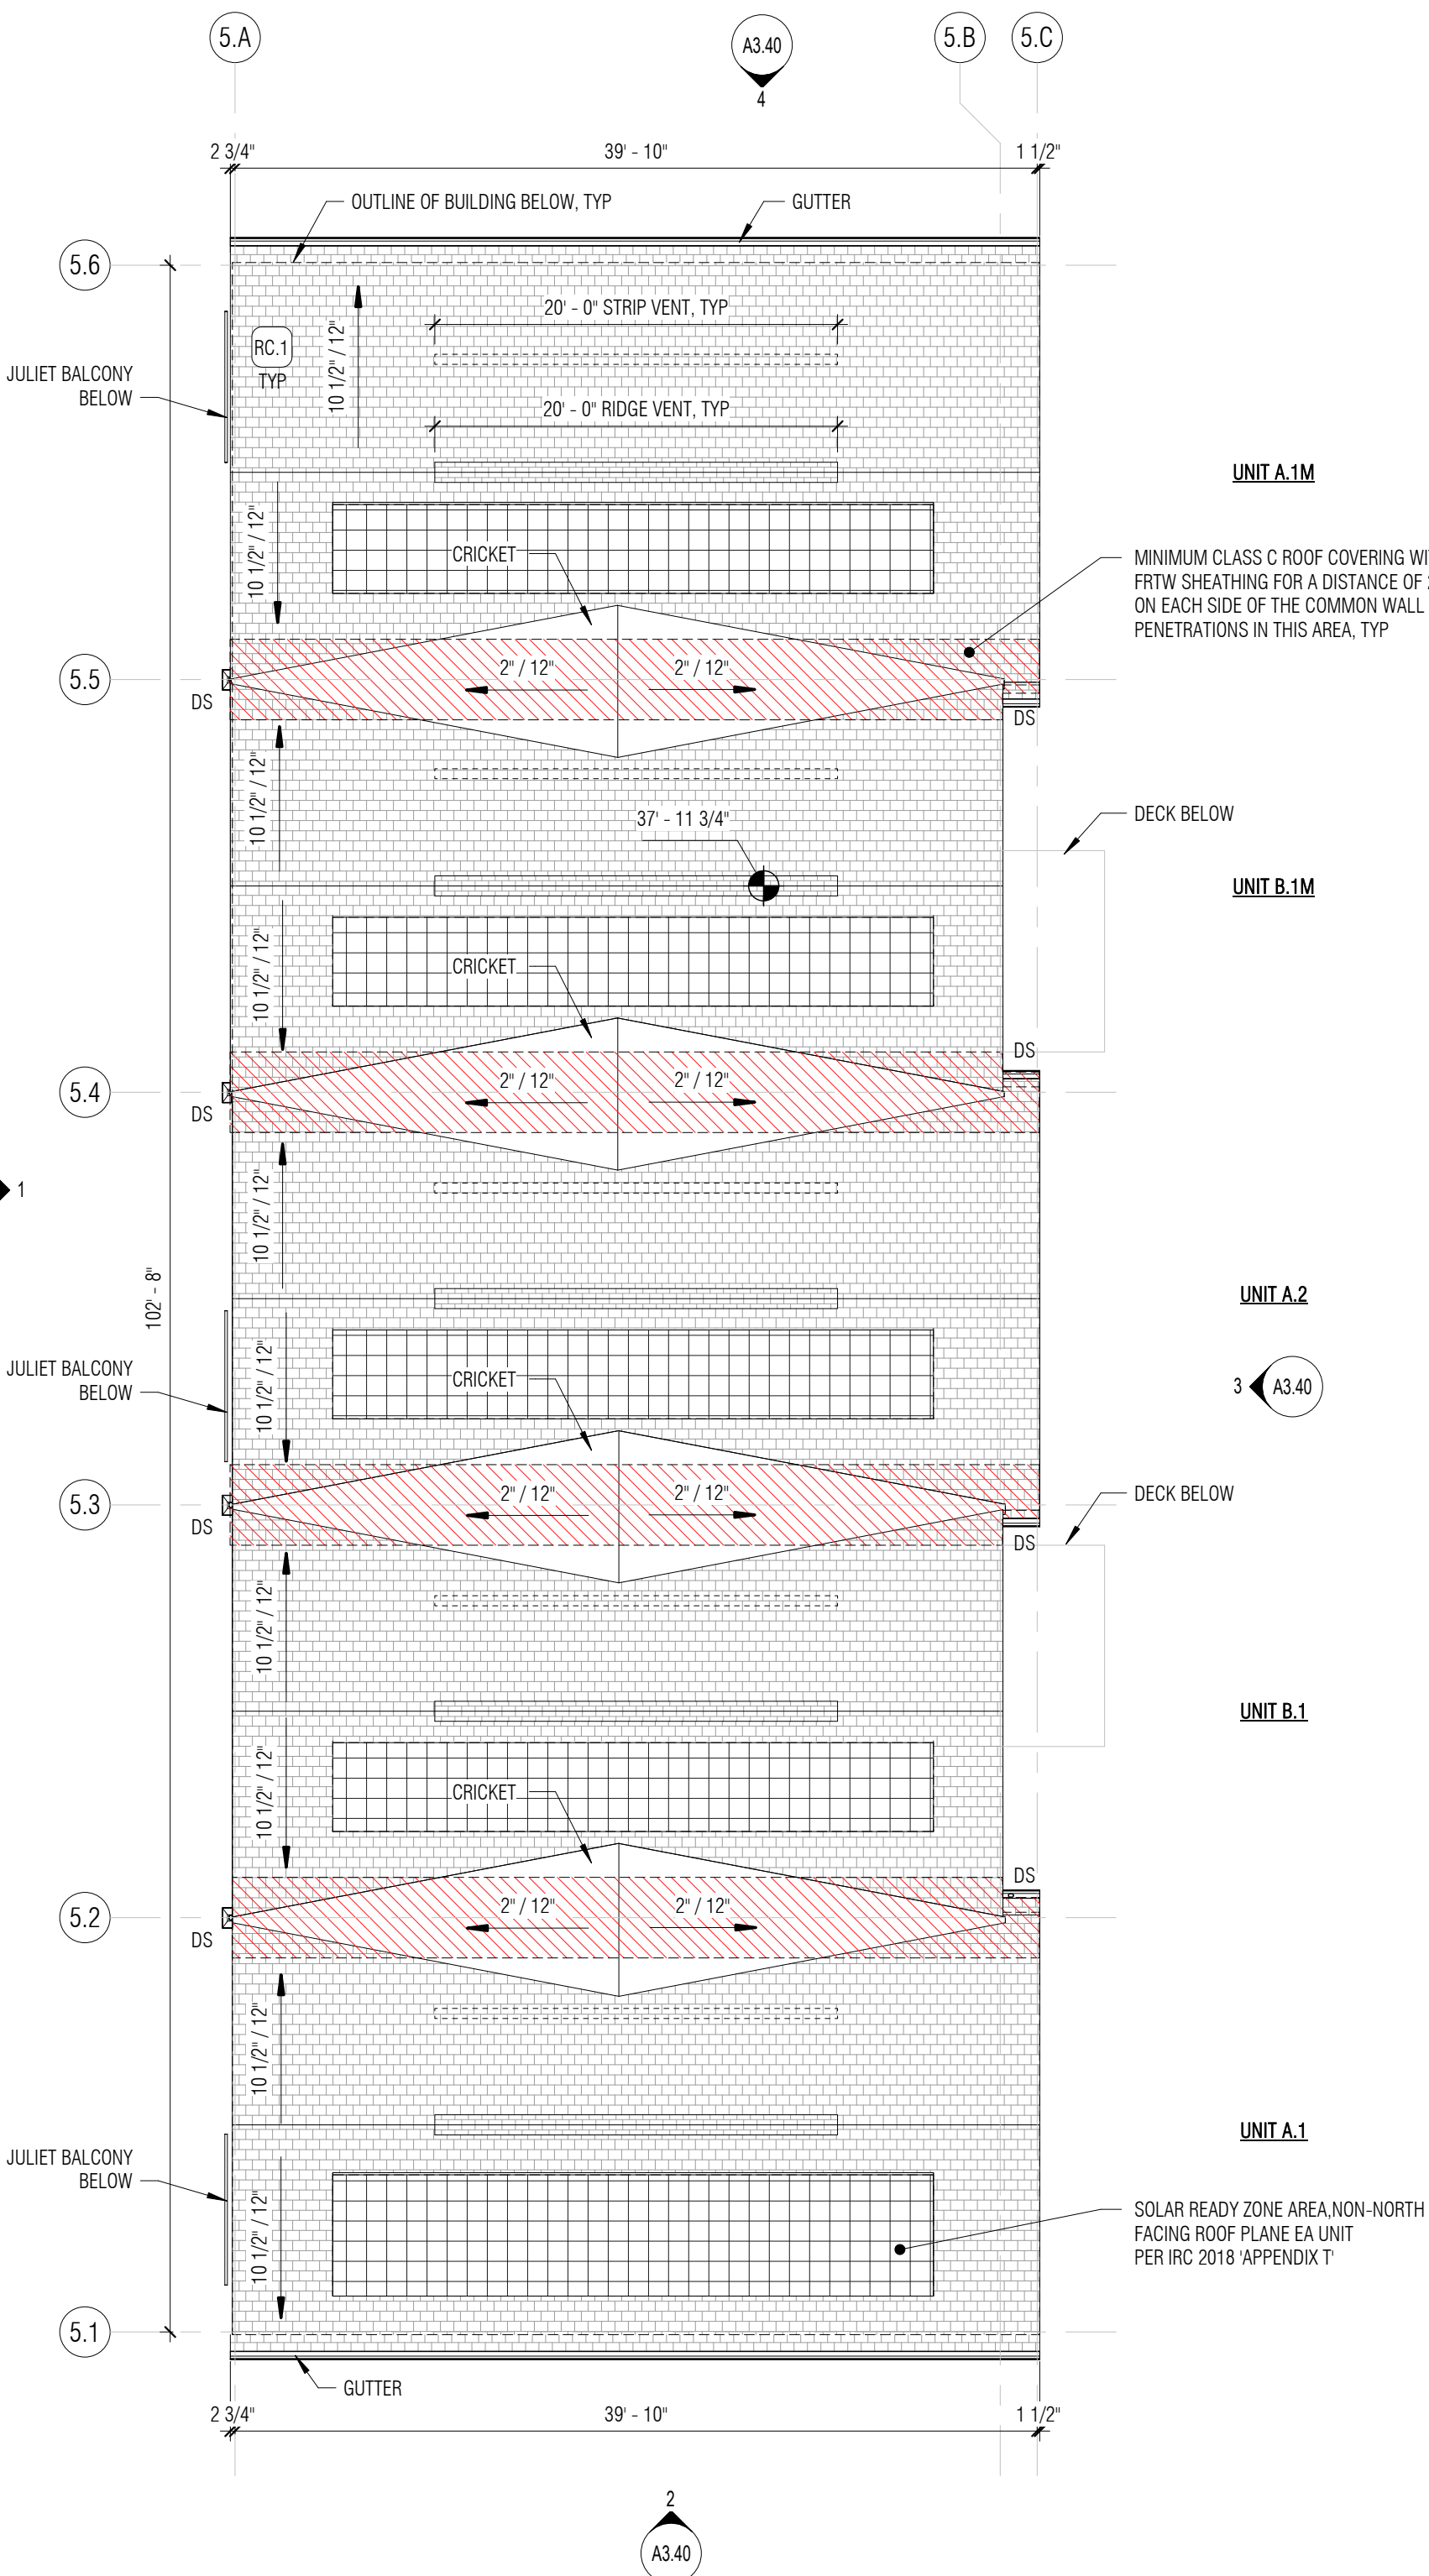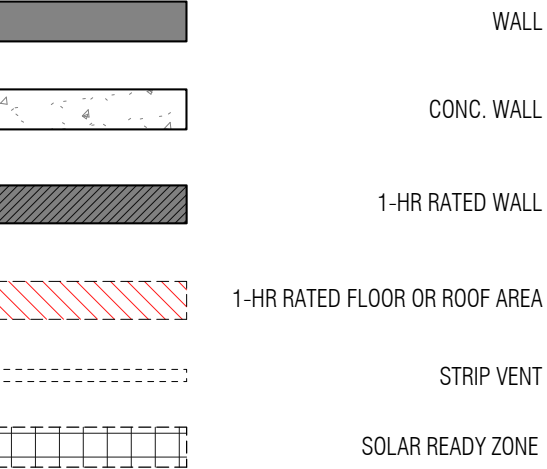

2 5-PACK TOWNHOUSE "A-B-A-B-A" FLOOR PLAN - LEVEL 3
1/8" = 1'-0"



1 5-PACK TOWNHOUSE "A-B-A-B-A" FLOOR PLAN - LEVEL 2
1/8" = 1'-0"

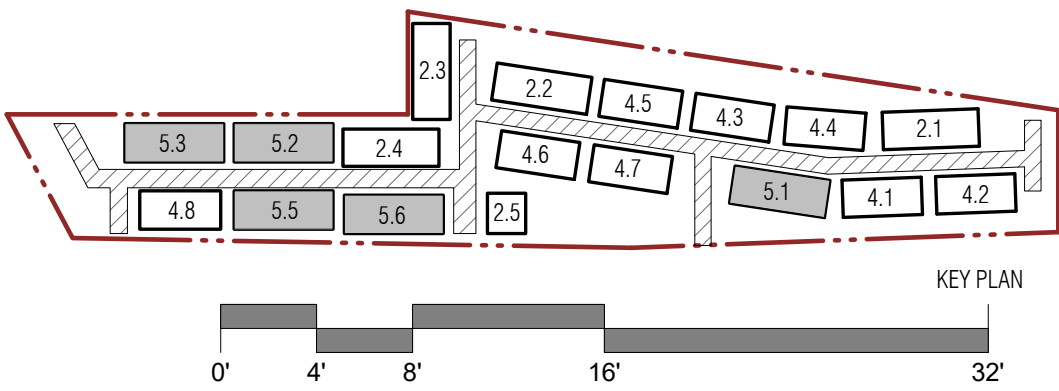


EXTERIOR MATERIAL SCHEDULE

1 ASPHALT SHINGLE ROOFING
CHARCOAL GRAY



2 FIBER CEMENT SIDING -
VERTICAL BOARD AND BATTEN
5/16" FIBER CEMENT PANEL WITH BATTENS
2-1/2" WIDE X 3/4" DEEP
RANDOMIZE BATTEN SPACING PER
PAINT COLOR: SW6252 ICE CUBE

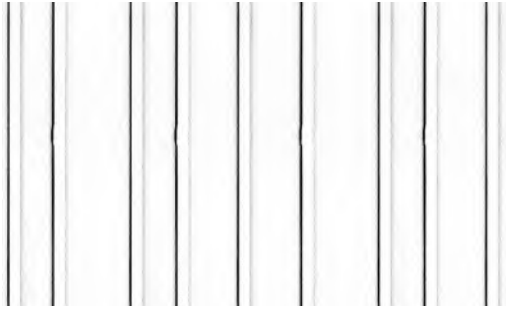

3 FIBER CEMENT SIDING -
VERTICAL BOARD AND BATTEN
5/16" FIBER CEMENT PANEL WITH BATTENS
2-1/2" WIDE X 3/4" DEEP
RANDOMIZE BATTEN SPACING PER
PAINT COLOR: SW6591 BLACK MAGIC



4 FIBER CEMENT SIDING - WOOD LOOK
5/16" FIBER CEMENT PANEL



5 NOT USED

6 FASCIA - BLACK METAL



7 VINYL WINDOW FRAME - BLACK



8 VINYL DOOR - BLACK



9 VINYL SLIDING DOOR - BLACK



10 METAL RAILING - BLACK



11 GARAGE DOOR - BLACK



12 DOWNSPOUT / GUTTER - BLACK



13 SOLID WASTE ENCLOSURE
HORIZONTAL WOOD SLATS



REVISION	DATE	DESCRIPTION
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DATE	DESCRIPTION
7/29/2022	LAND USE APPLICATION
1/13/2023	LAND USE APP RESUBMITTAL
4/14/2023	LAND USE APP RESUBMITTAL

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ORIGINAL SHEET SIZE IS 24"x36"

BOARD & VELLUM PROJECT #: 2021170.00
COB PROJECT #: 2021-0105

PLOT DATE: 04.12.2023


BUILDING ELEVATIONS -
MATERIALS

SHEET NO.:

A3.00




3 2-PACK TOWNHOUSE (C-C) ENTRY ELEVATION
1/8" = 1'-0"

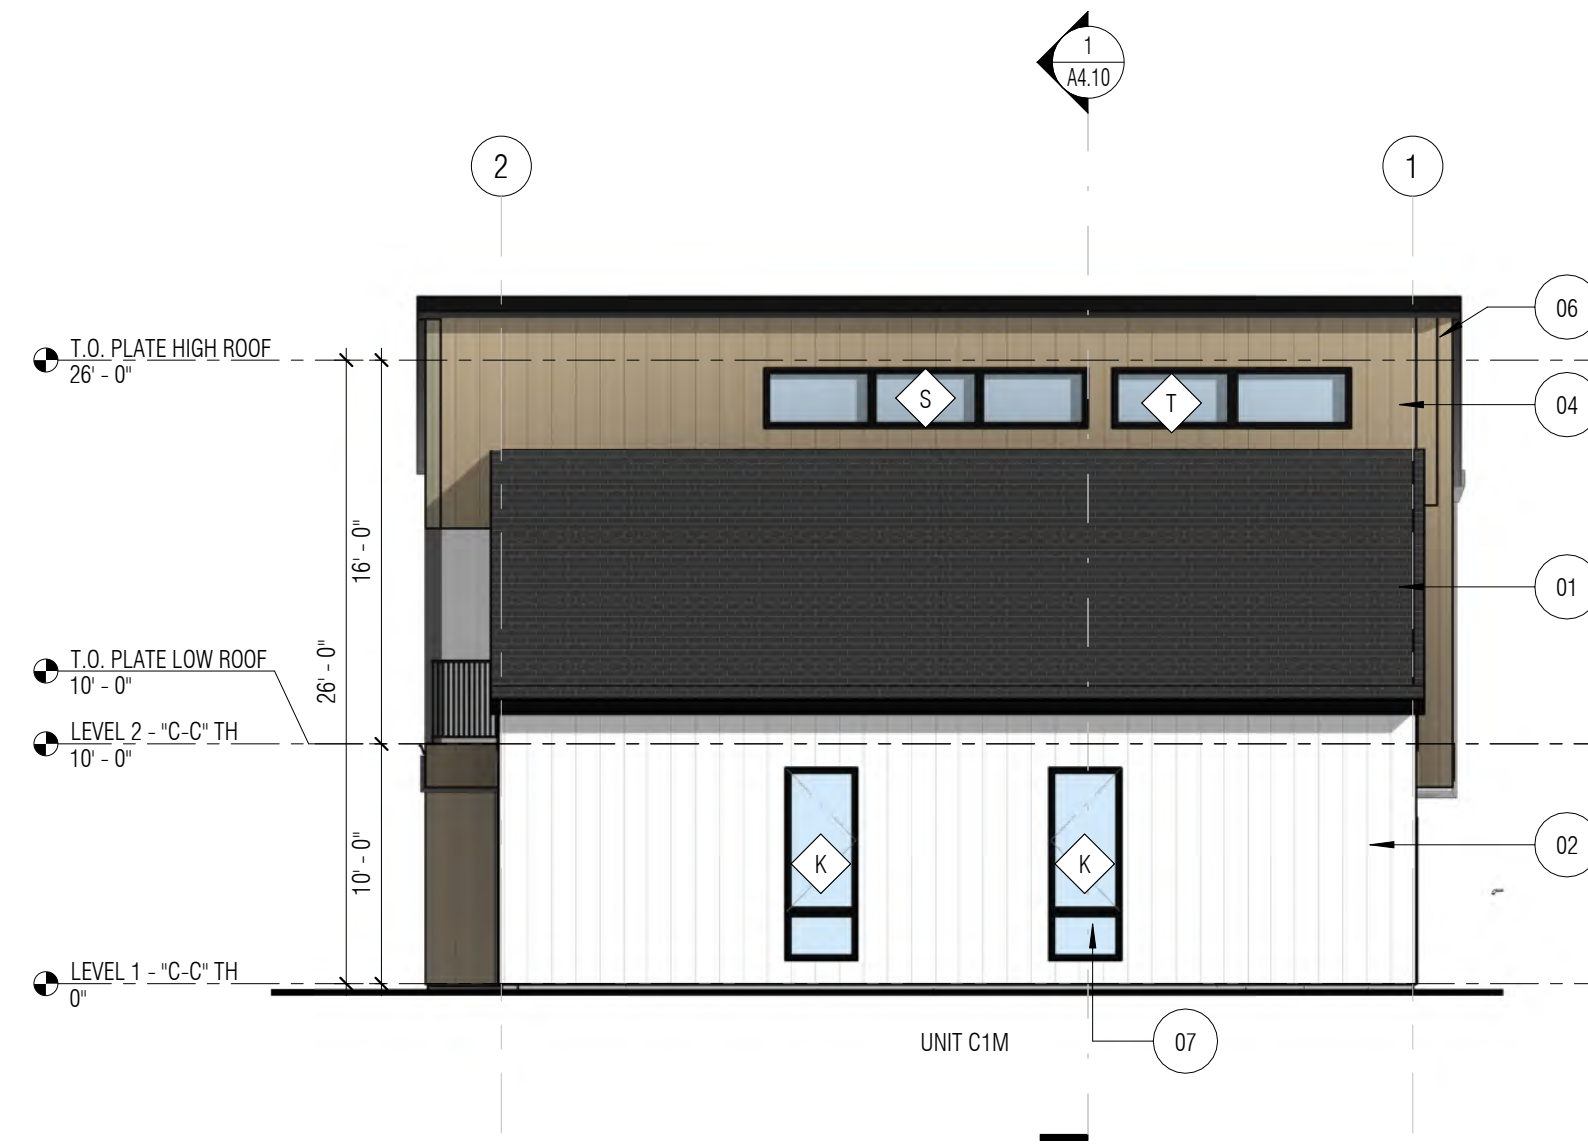

4 2-PACK TOWNHOUSE (C-C) LEFT ELEVATION
1/8" = 1'-0"



1 2-PACK TOWNHOUSE (C-C) GARAGE ELEVATION
1/8" = 1'-0"

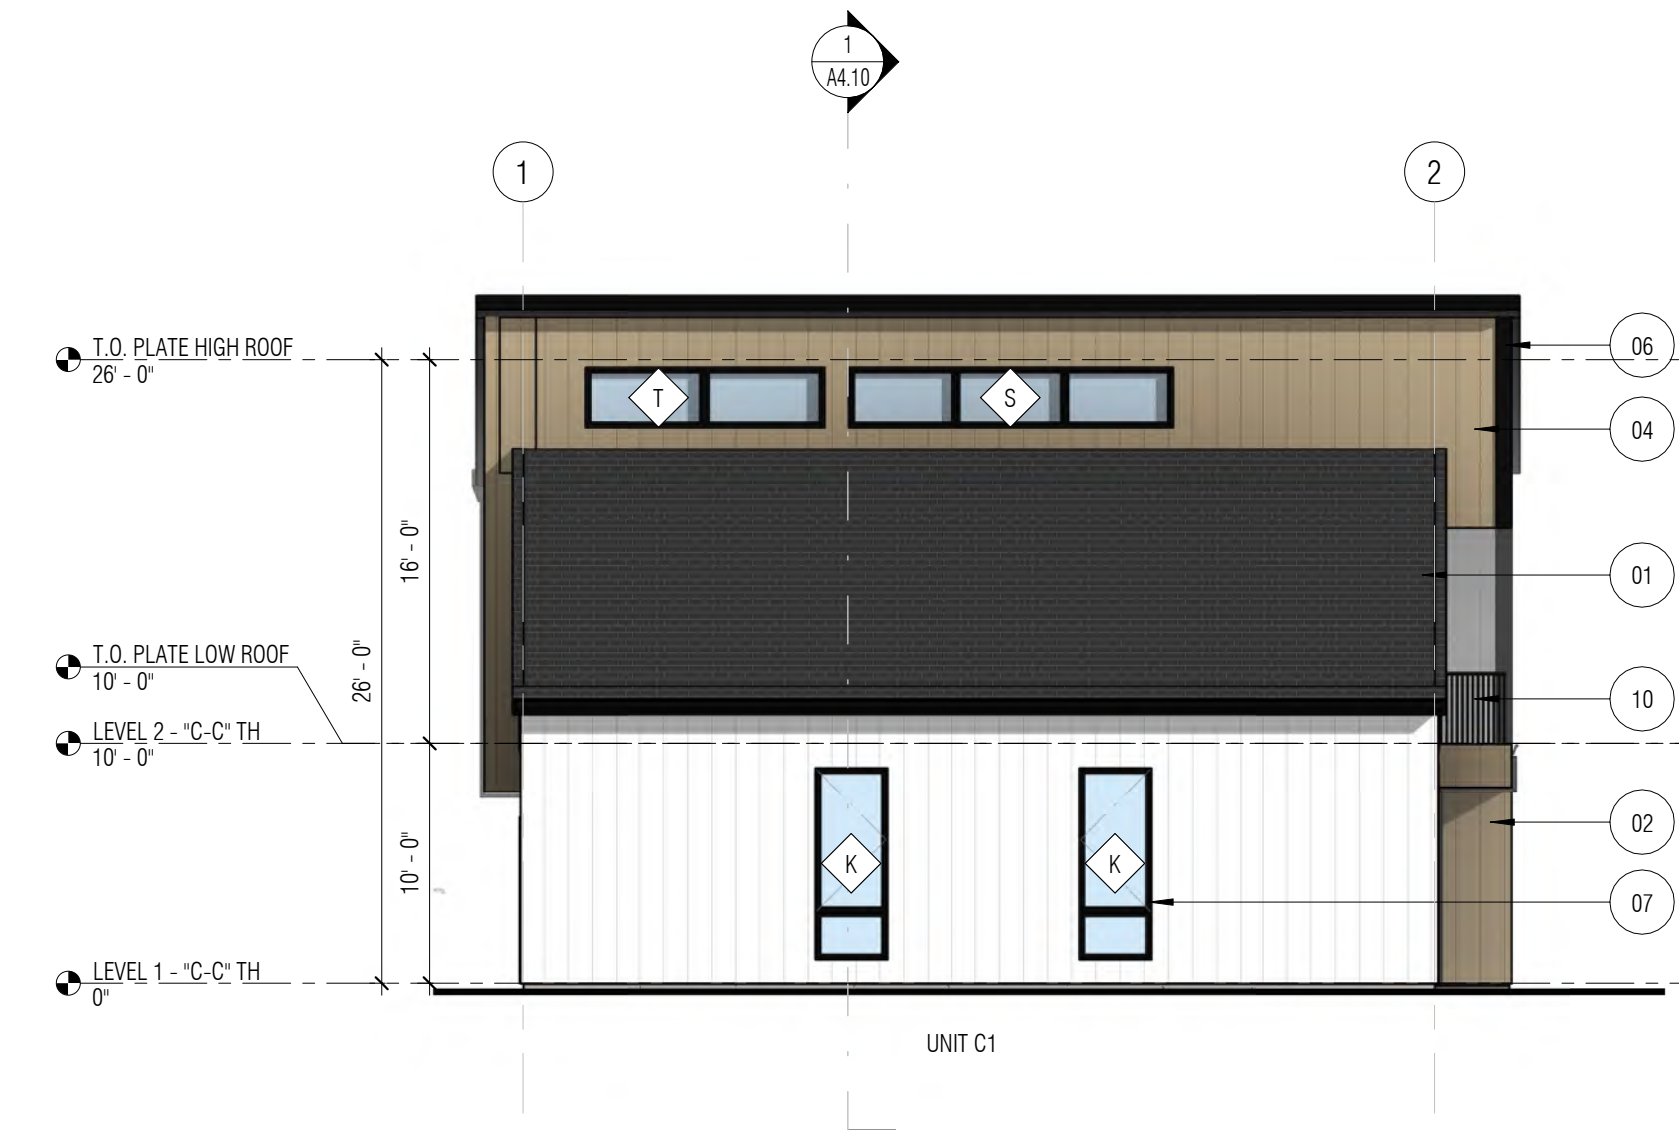

2 2-PACK TOWNHOUSE (C-C) RIGHT ELEVATION
1/8" = 1'-0"

GENERAL NOTES

1. REFER TO SHEET A2.00 FOR EXTERIOR BUILDING PRODUCT IMAGES.
2. REFER TO SHEET G1.02 FOR ZONING HEIGHT LIMIT AND GRADE INFORMATION.
3. REFER TO ENLARGED SITE PLAN AT A1.21 AND A1.22 FOR UNIT FINISH FLOOR ELEVATIONS.
4. EXHAUST DUCTS AND OPENINGS SHALL TERMINATE NOT LESS THAN 3 FEET FROM OPERABLE WINDOWS, OPENINGS INTO THE BUILDING AND FROM THE PROPERTY LINE AND FIRE SEPARATION LINES.

EXTERIOR MATERIAL SCHEDULE

- 1 ASPHALT SHINGLE ROOFING - CHARCOAL GRAY
- 2 FIBER CEMENT SIDING - VERTICAL BOARD AND BATTEN
5/16" FIBER CEMENT PANEL WITH BATTENS 2-1/2" WIDE X 3/4" DEEP
RANDOMIZE BATTEN SPACING PER
PAINT COLOR: SW6252 ICE CUBE
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PAINT COLOR: SW6991 BLACK MAGIC
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- 5 NOT USED
- 6 FASCIA - BLACK METAL
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- 8 VINYL DOOR - BLACK
- 9 VINYL SLIDING DOOR - BLACK
- 10 METAL RAILING - BLACK
- 11 GARAGE DOOR - BLACK
- 12 DOWNSPOUT / GUTTER - BLACK

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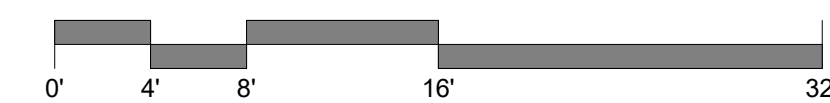
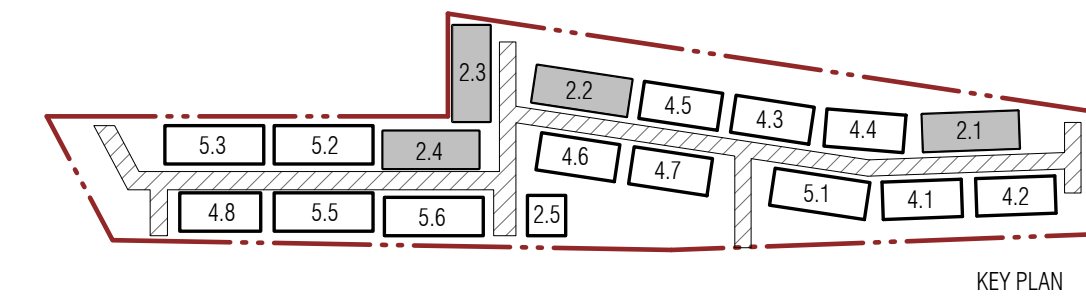
BOARD & VELLUM PROJECT #: 2021170.00
COB PROJECT #: 2021-0105

PLOT DATE: 04.12.2023

BUILDING ELEVATIONS -
2-PACK TH "C-C" UNITS

SHEET NO.:

A3.10






1 2-PACK TOWNHOUSE "A-B" ENTRY ELEVATION
1/8" = 1'-0"



3 2-PACK TOWNHOUSE "A-B" LEFT ELEVATION
1/8" = 1'-0"



2 2-PACK TOWNHOUSE "A-B" GARAGE ELEVATION
1/8" = 1'-0"

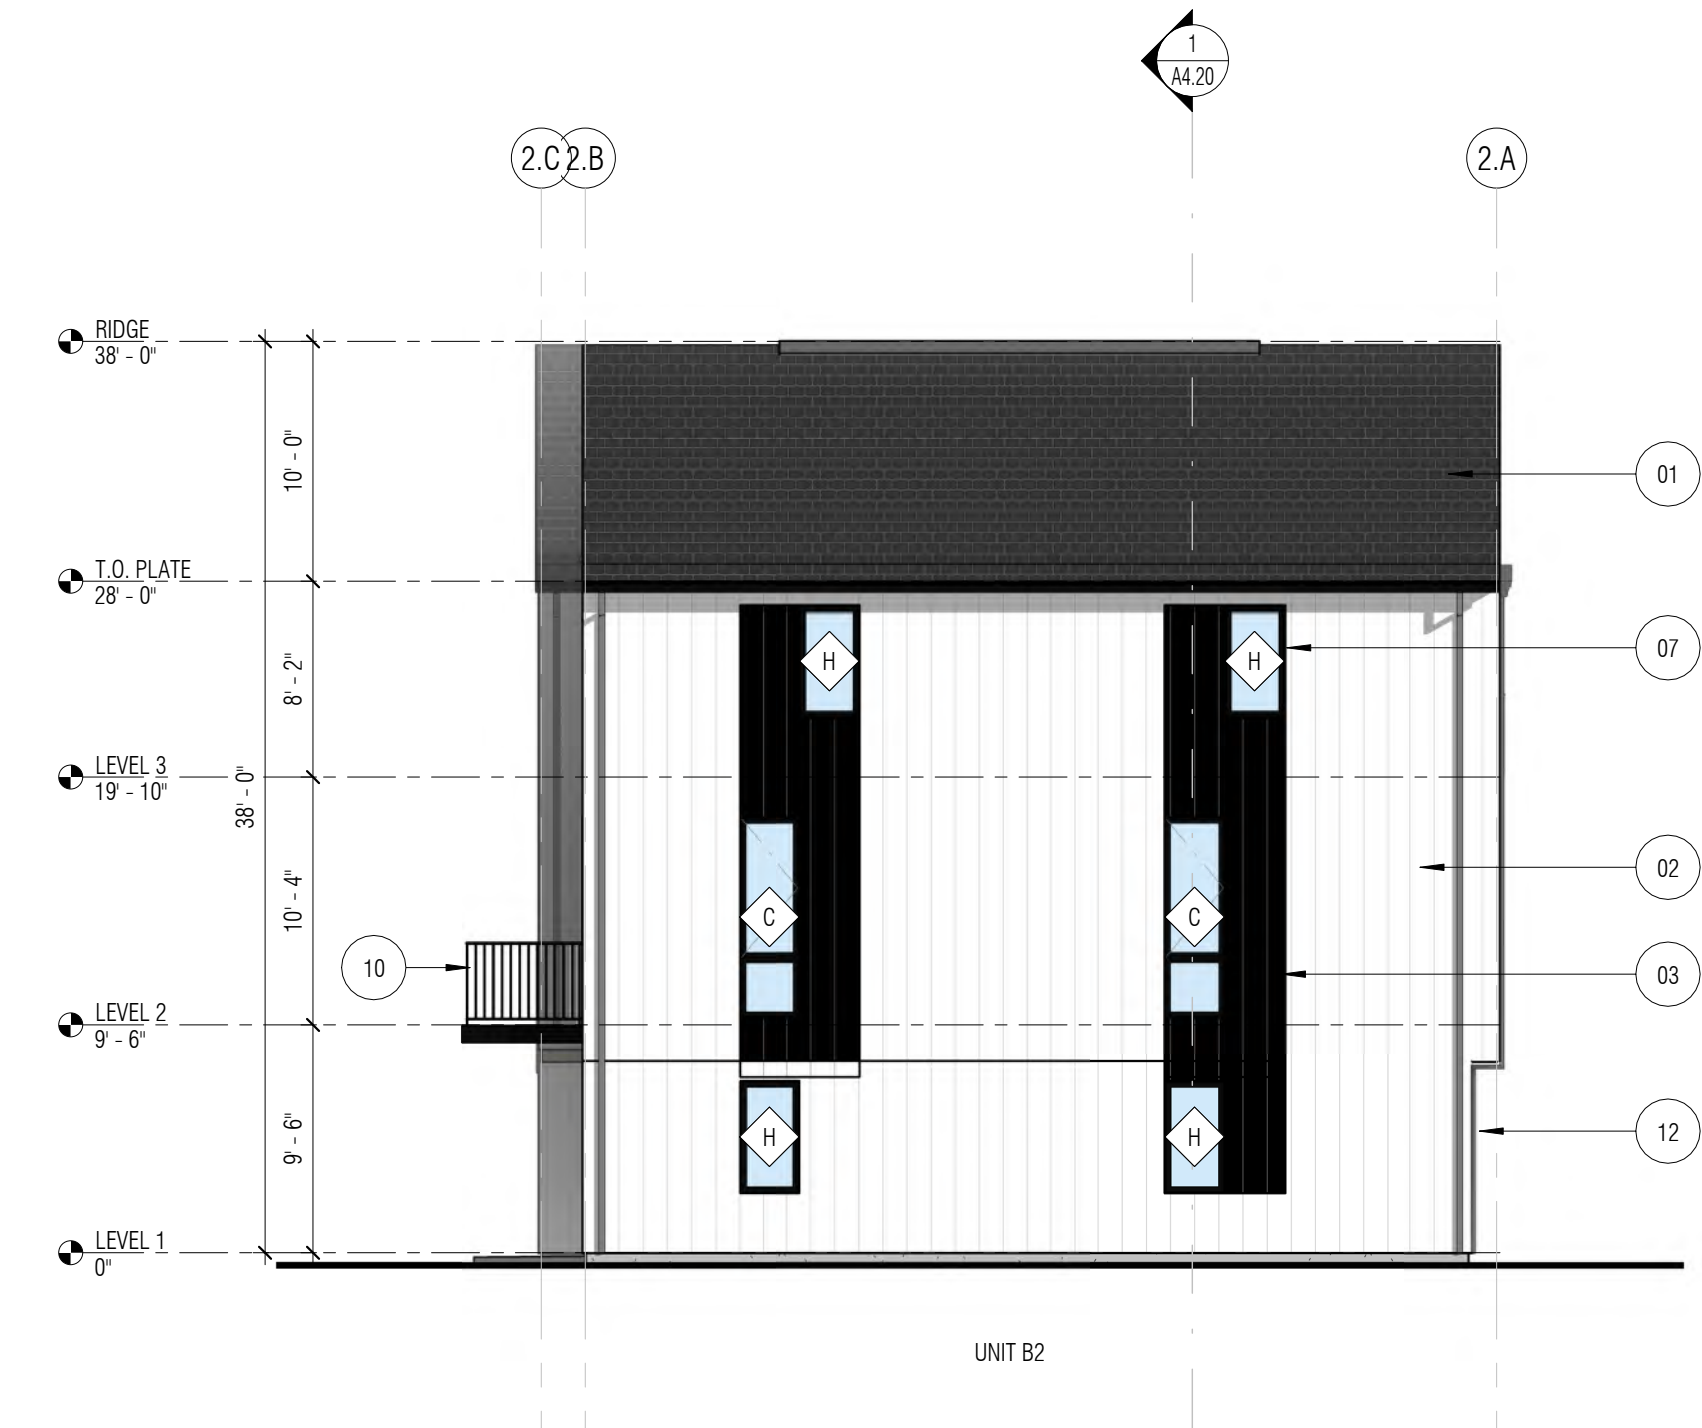



4 2-PACK TOWNHOUSE "A-B" RIGHT ELEVATION
1/8" = 1'-0"


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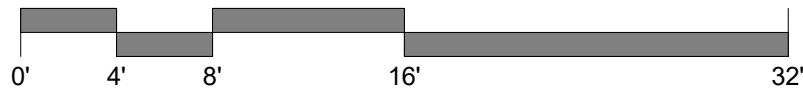
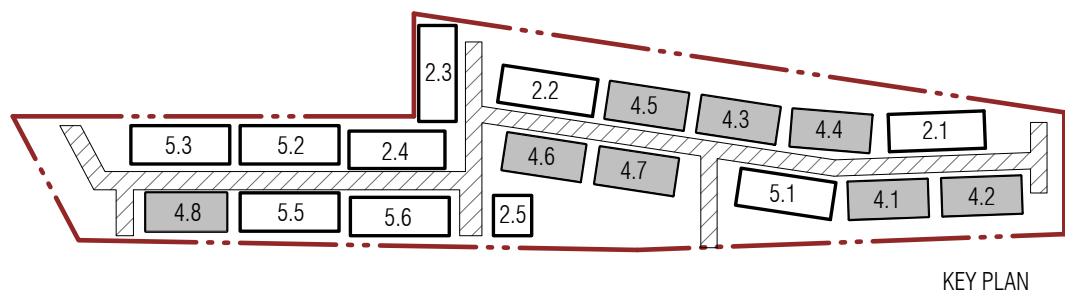


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PLOT DATE: 04.12.2023

BUILDING ELEVATIONS -
4-PACK TH "A-B-A-B" UNITS


SHEET NO.:

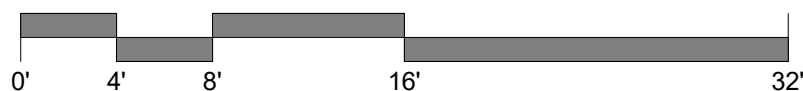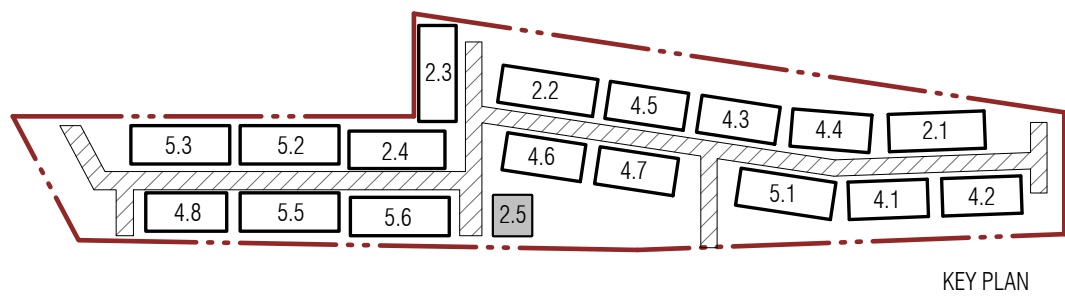

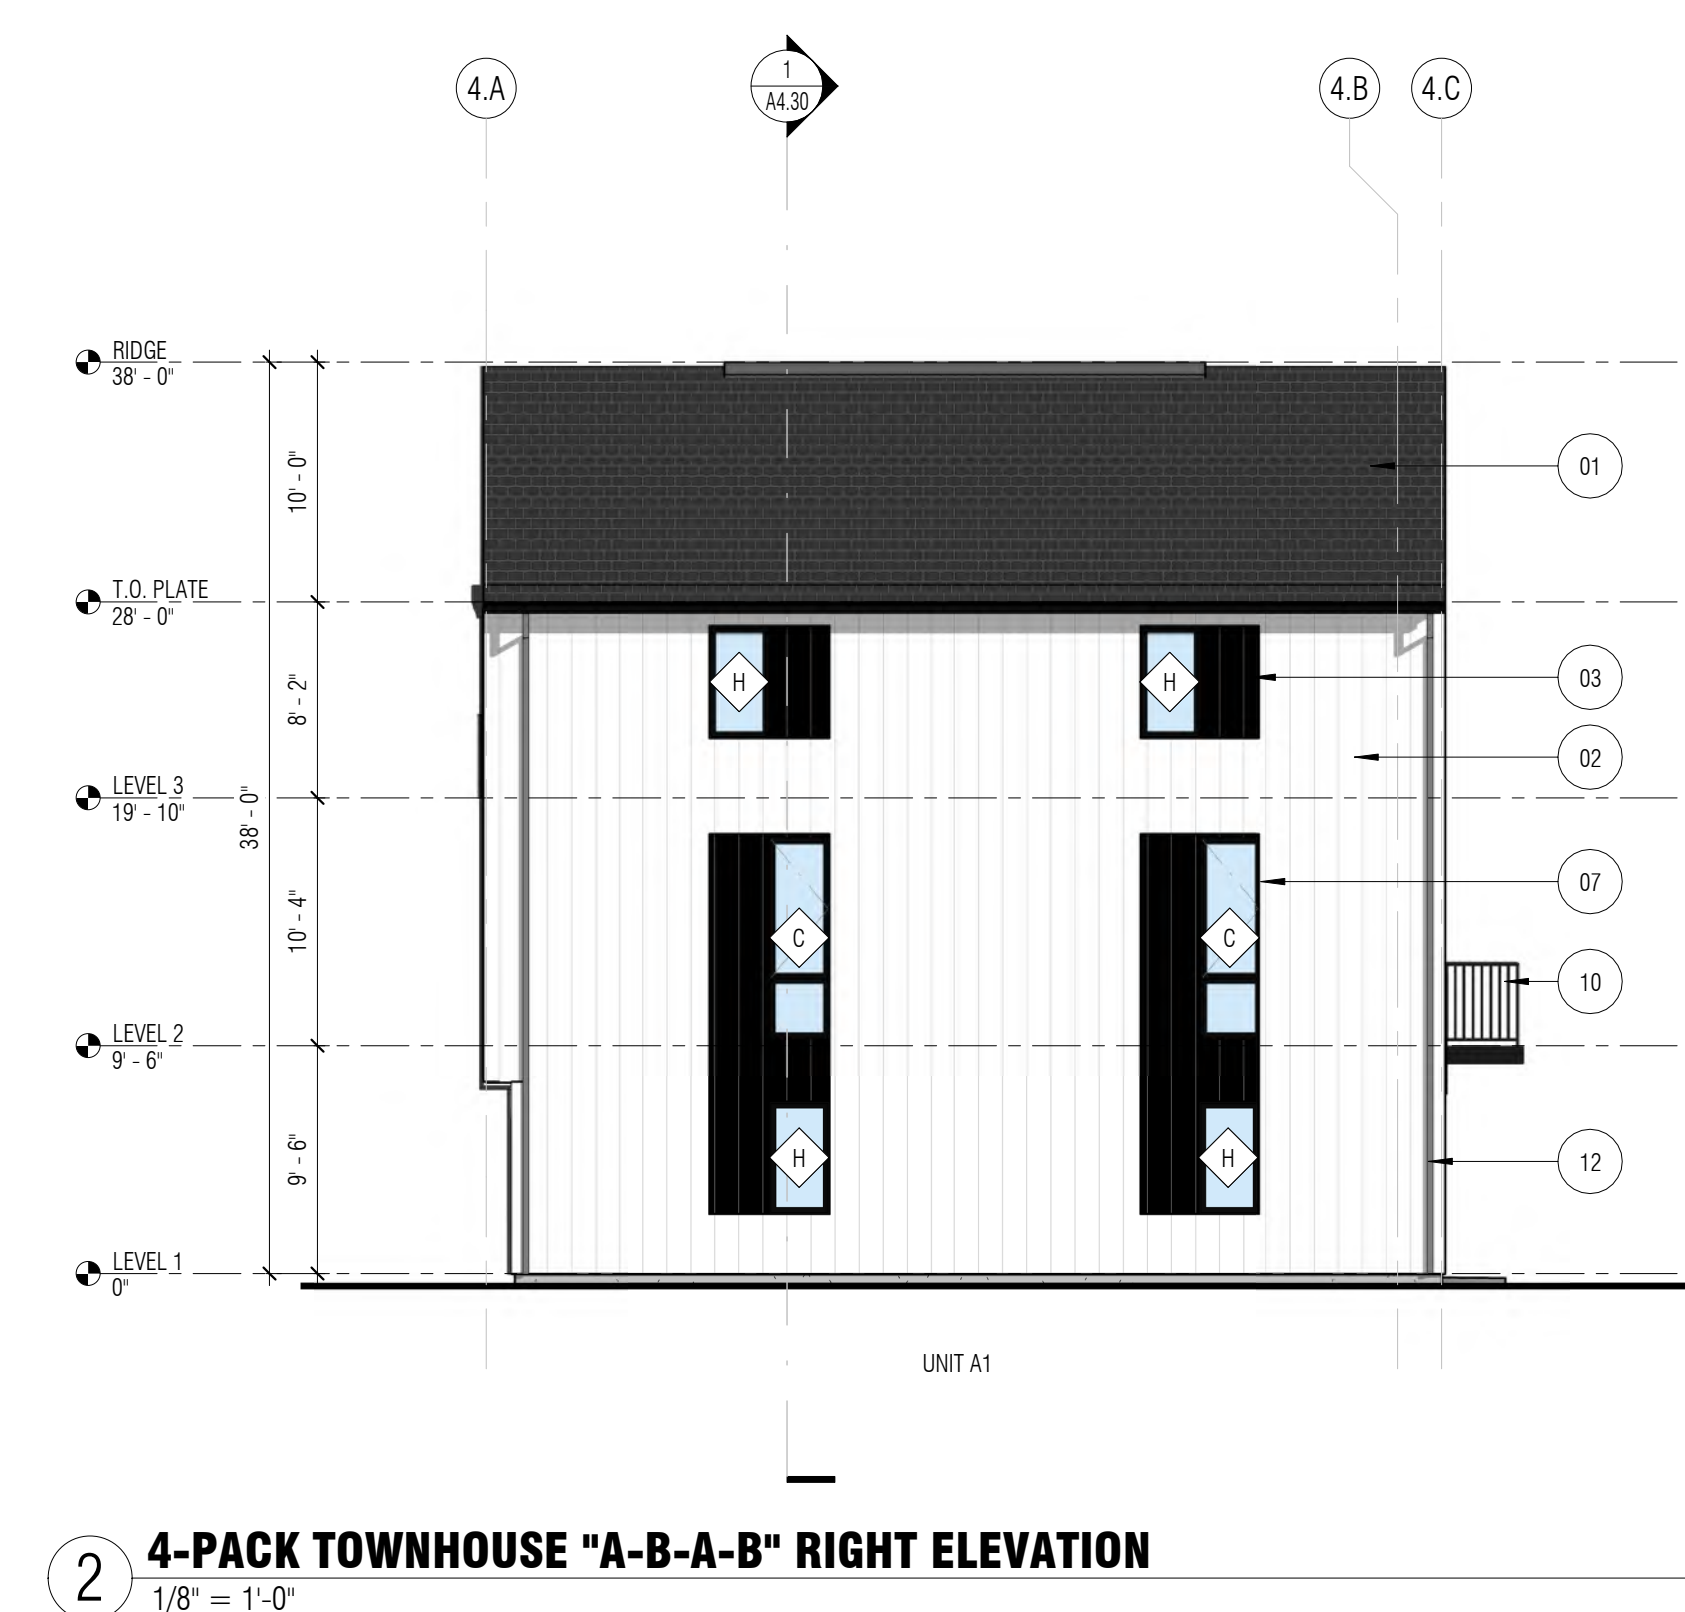3 5-PACK TOWNHOUSE "A-B-A-B-A" ENTRY ELEVATION
1/8" = 1'-0"



1 5-PACK TOWNHOUSE "A-B-A-B-A" GARAGE ELEVATION
1/8" = 1'-0"

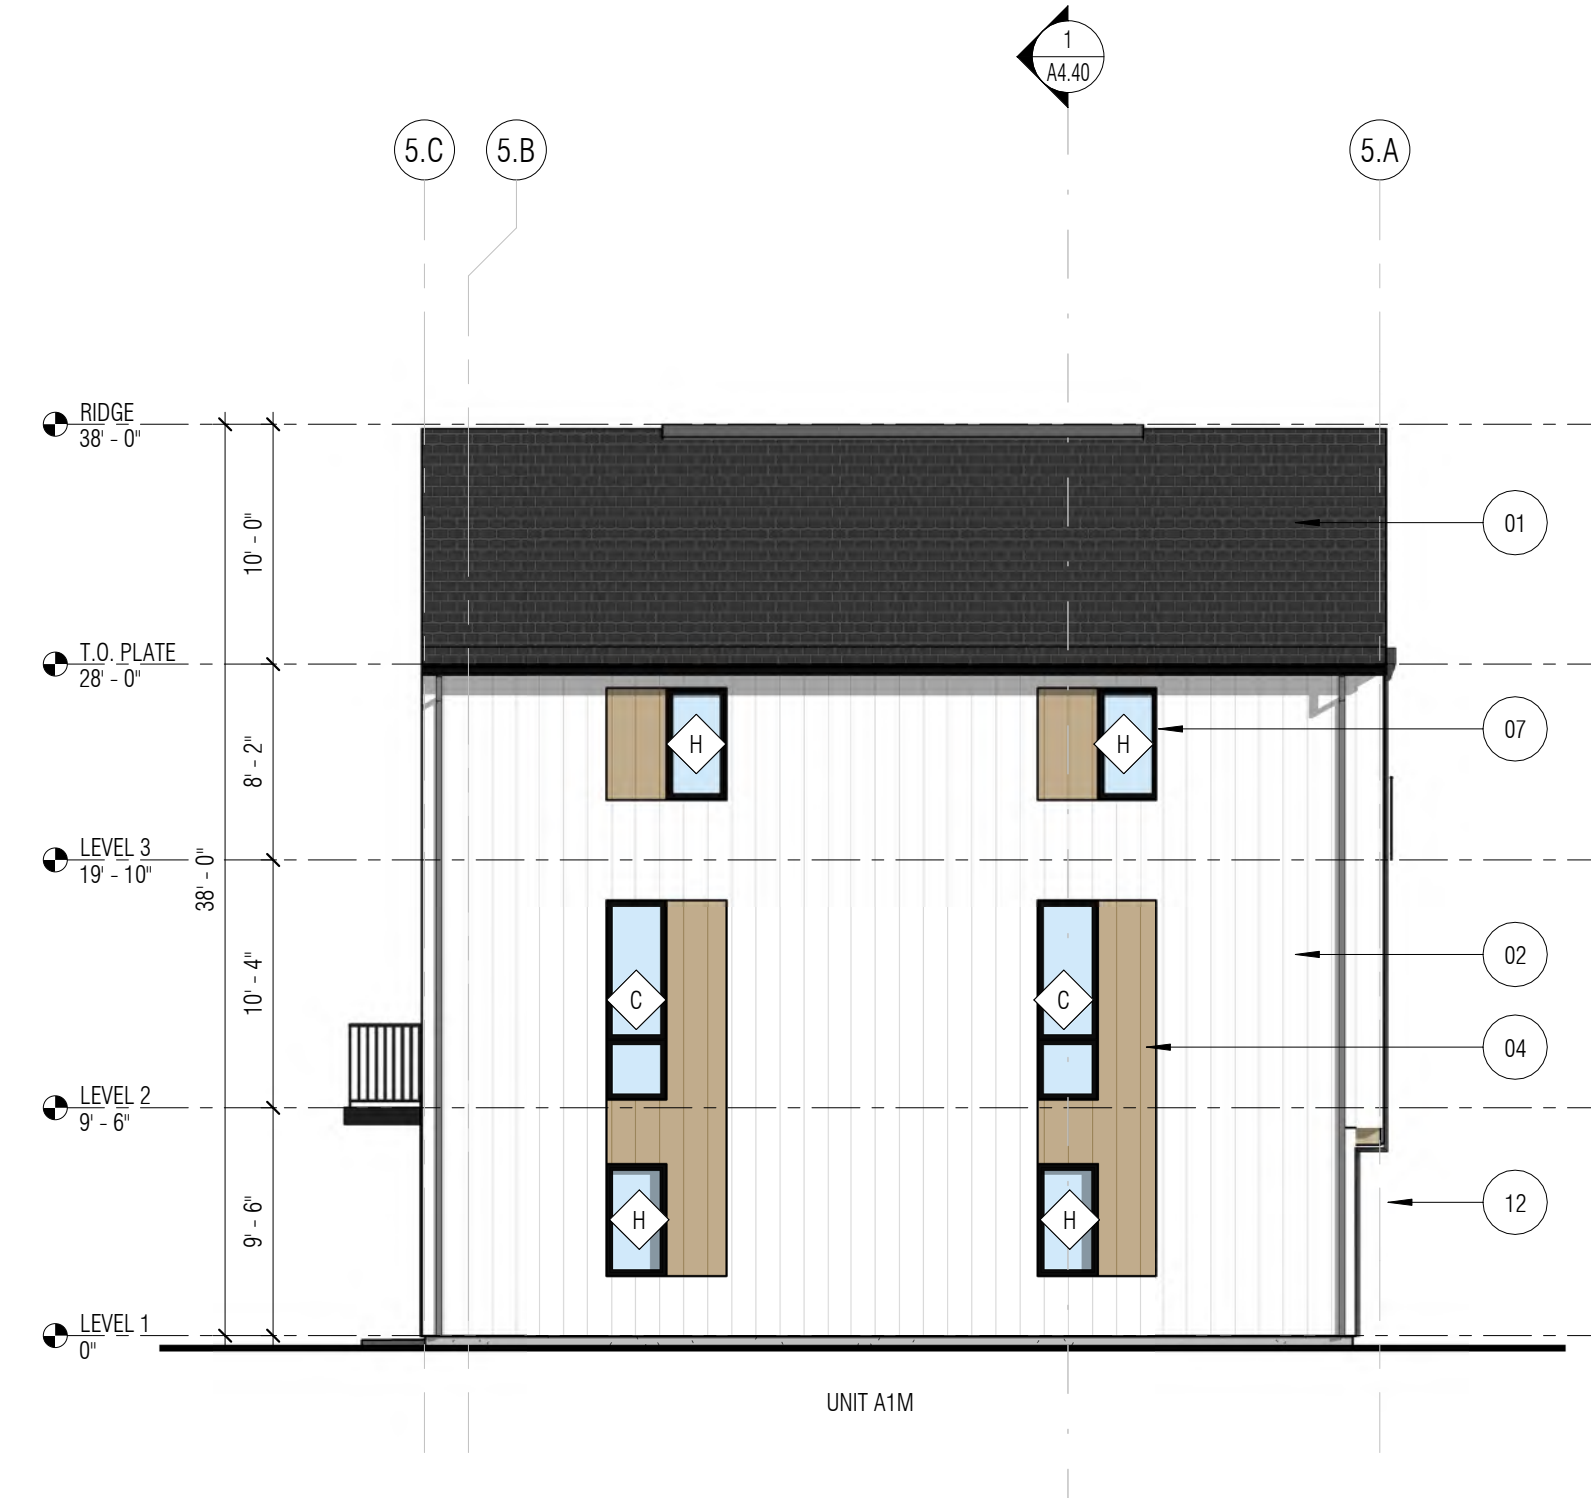

4 5-PACK TOWNHOUSE "A-B-A-B-A" LEFT ELEVATION
1/8" = 1'-0"





2 5-PACK TOWNHOUSE "A-B-A-B-A" RIGHT ELEVATION
1/8" = 1'-0"

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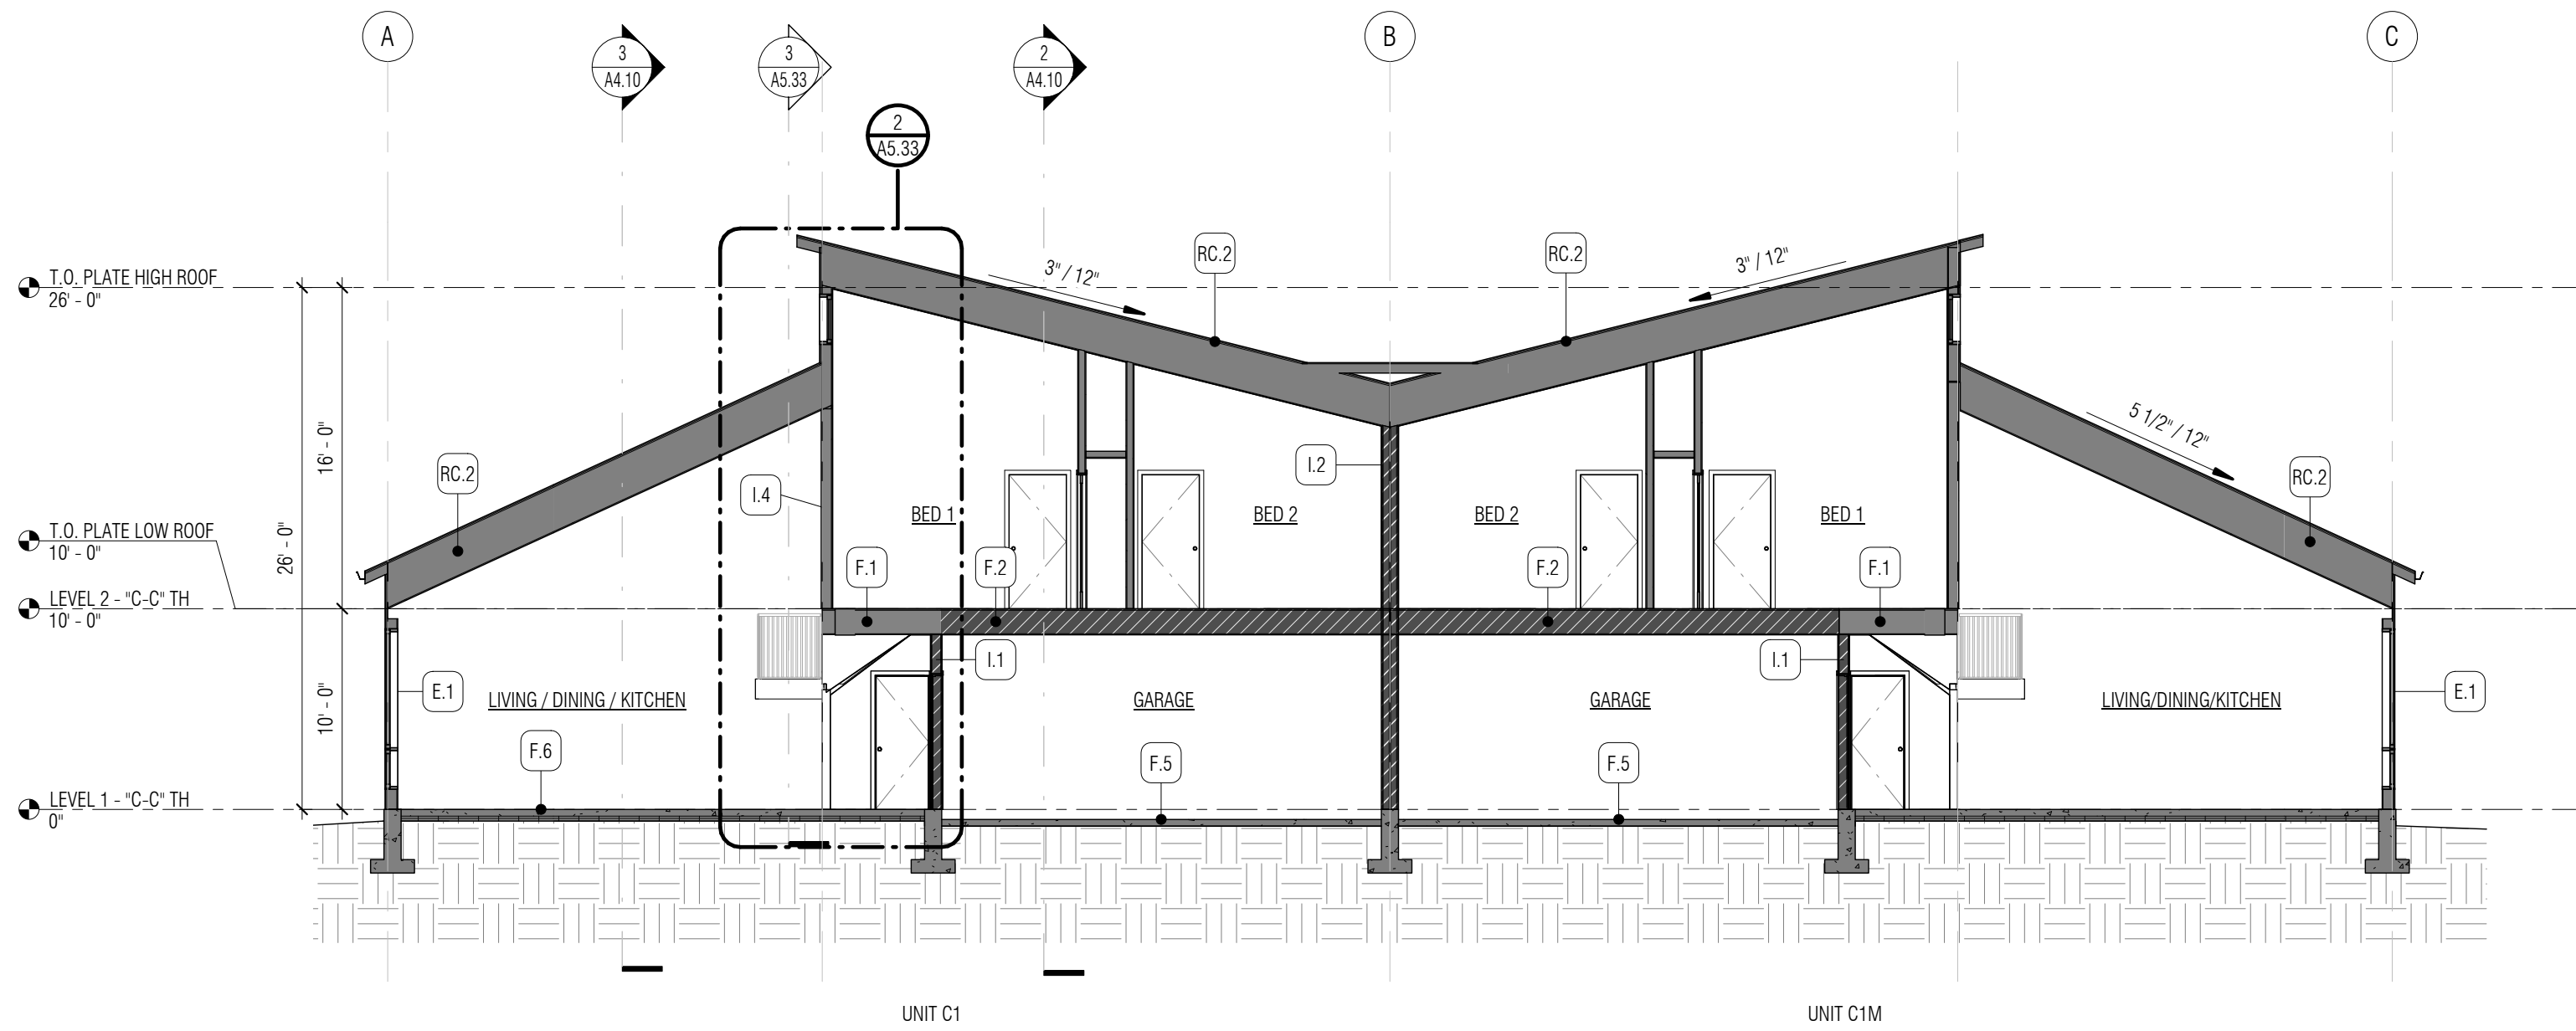
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PLOT DATE: 04.12.2023


**BUILDING ELEVATIONS -
5-PACK TH 'A-B-A-B-A' UNITS**

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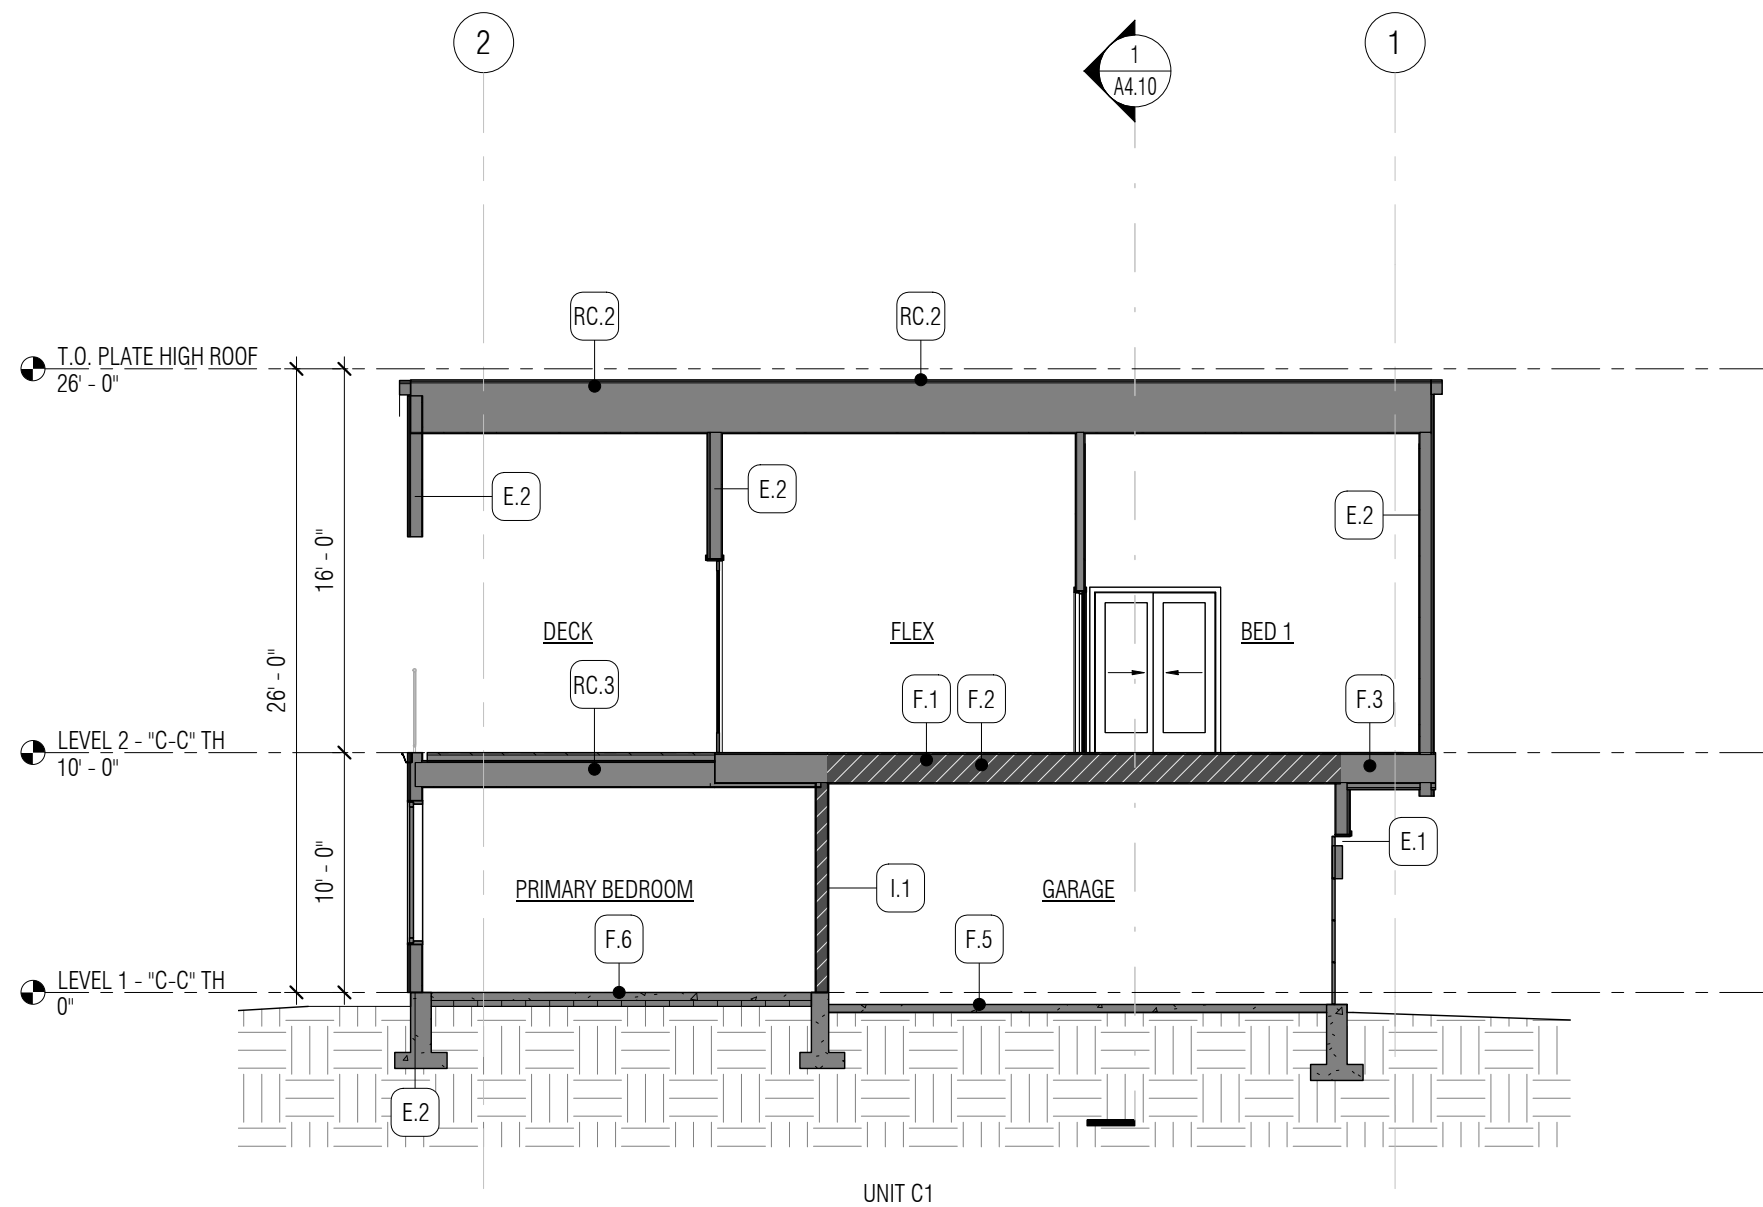
A3.40

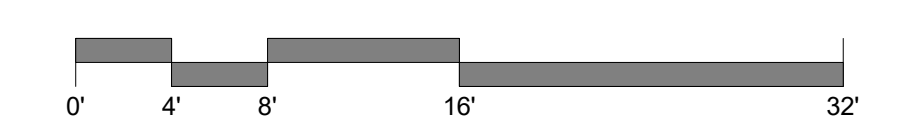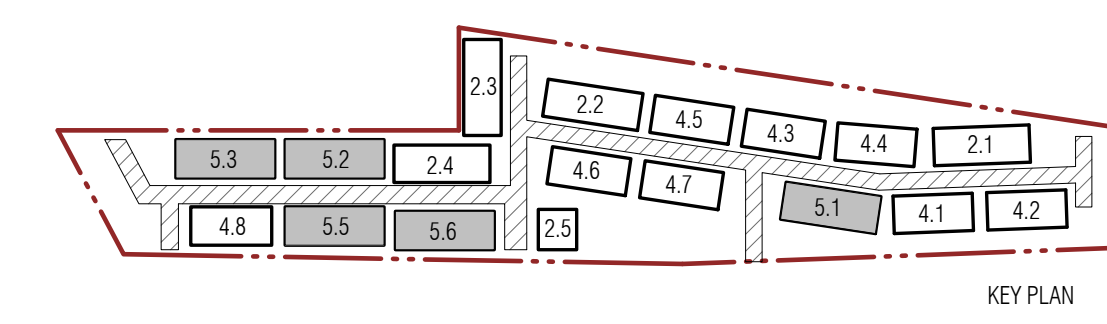

1 2-PACK TOWNHOUSE (C-C) - BUILDING SECTION - LONGITUDINAL
1/8" = 1'-0"

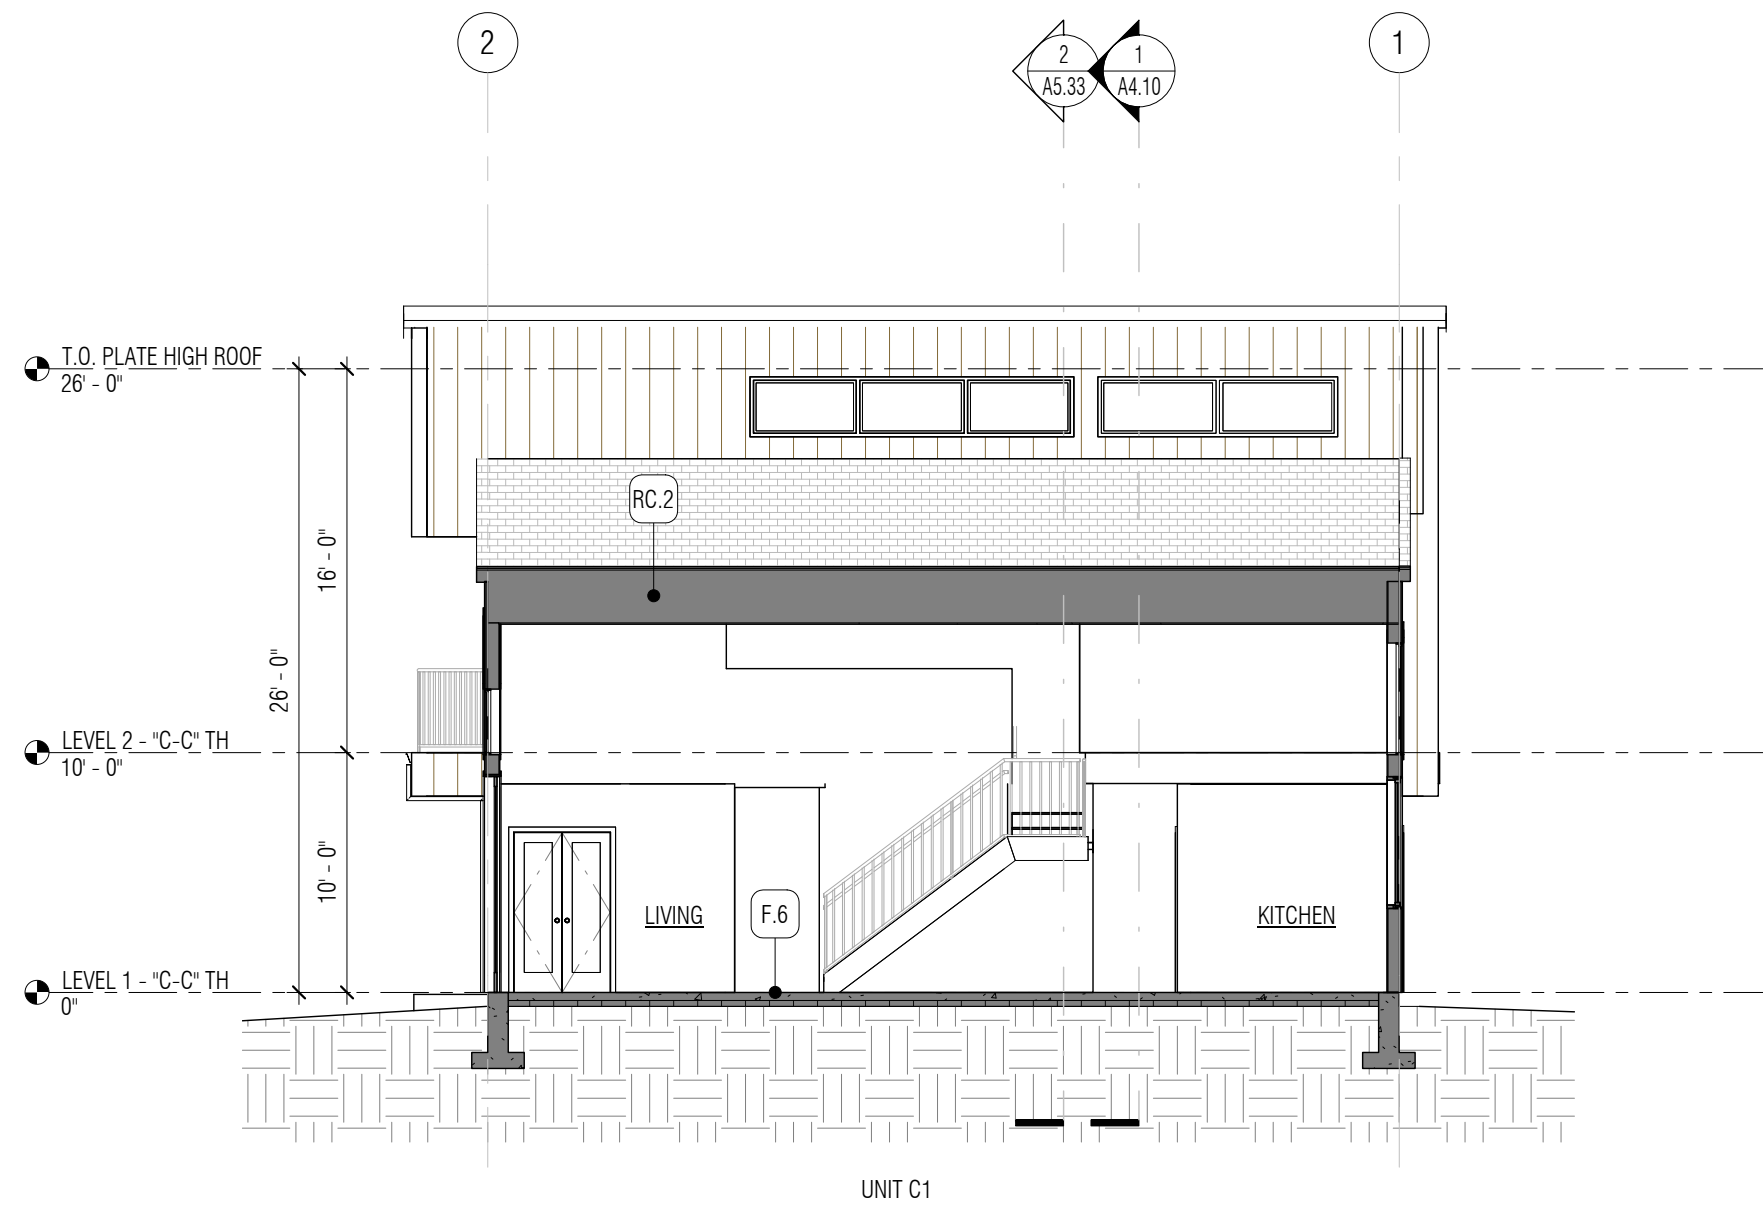

3 2-PACK TOWNHOUSE (C-C) - BUILDING SECTION THROUGH LIVING
1/8" = 1'-0"





2 2-PACK TOWNHOUSE (C-C) - BUILDING SECTION THROUGH GARAGE
1/8" = 1'-0"

GENERAL NOTES - BUILDING SECTIONS

- SEE SHEET FOR GRADES FOR ALL BUILDINGS.
- REFER TO ENLARGED SITE PLAN A1.21 AND A1.22 FOR FINISH FLOOR ELEVATIONS.
- FOR INSULATION VALUES, REFER TO HORIZONTAL ASSEMBLIES SHEET A2.01 AND VERTICAL ASSEMBLIES SHEET A2.02.

WALL LEGEND

	NEW WALL
	NEW CONC WALL
	1-HR RATED ASSEMBLY

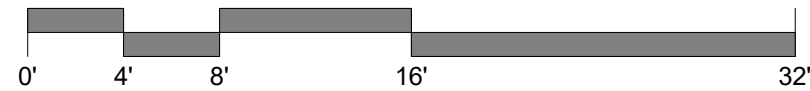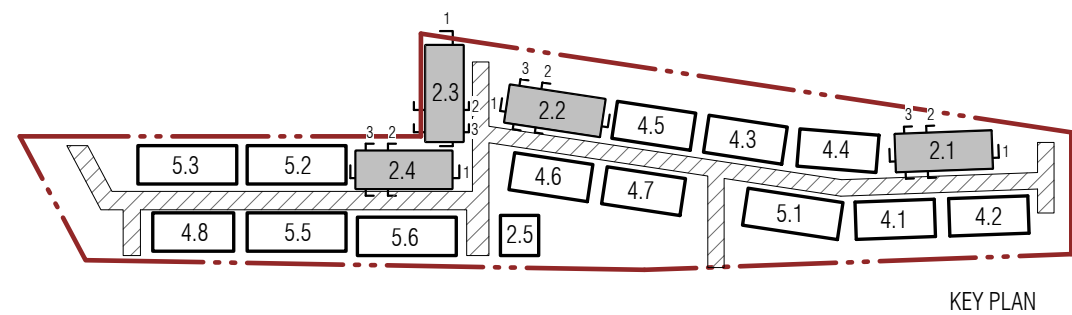

ISSUANCES

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4/14/2023	LAND USE APP RESUBMITTAL


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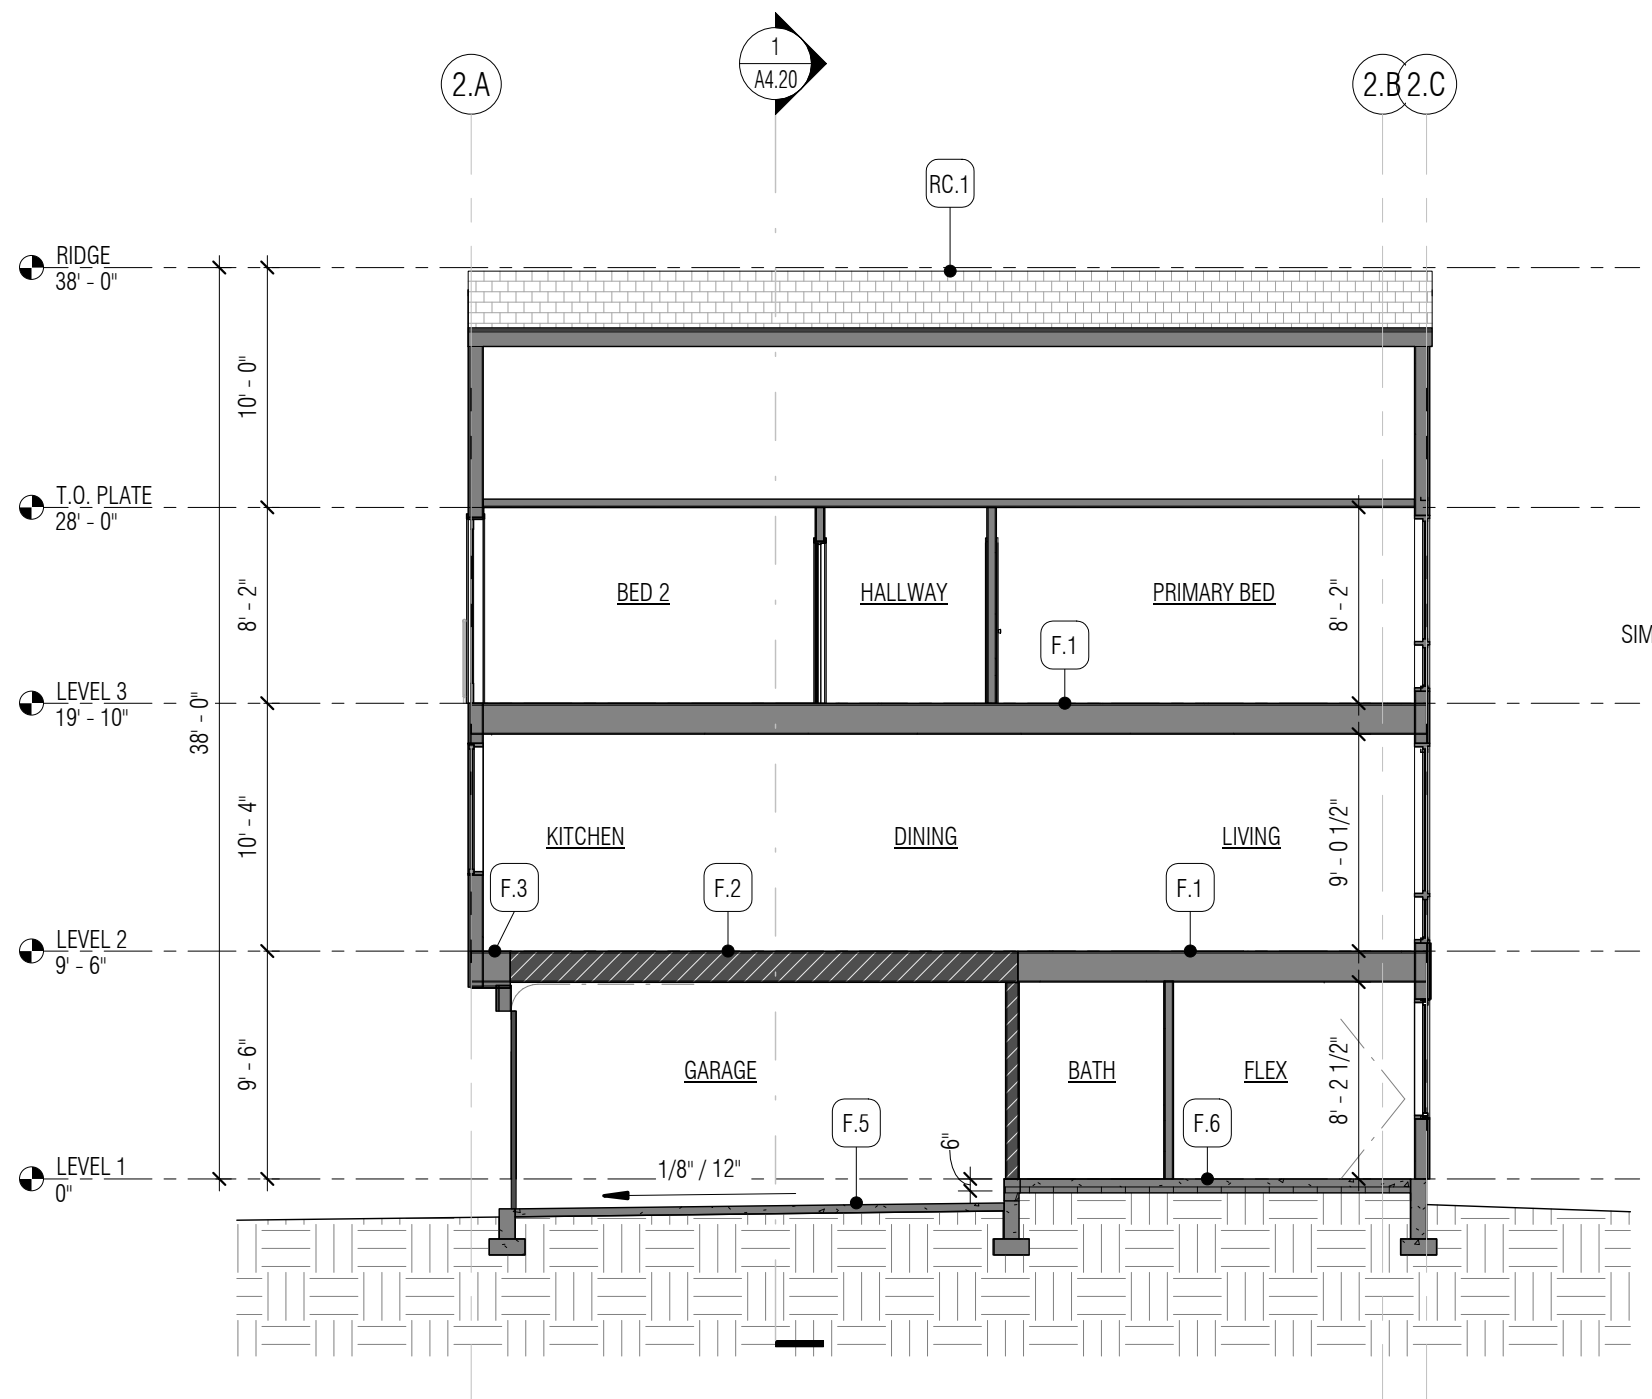
PLOT DATE: 04.12.2023

BUILDING SECTIONS -
2-PACK TH "C-C" UNITS


SHEET NO.:



1 2-PACK TOWNHOUSE (A-B) - LONG SECTION
1/8" = 1'-0"

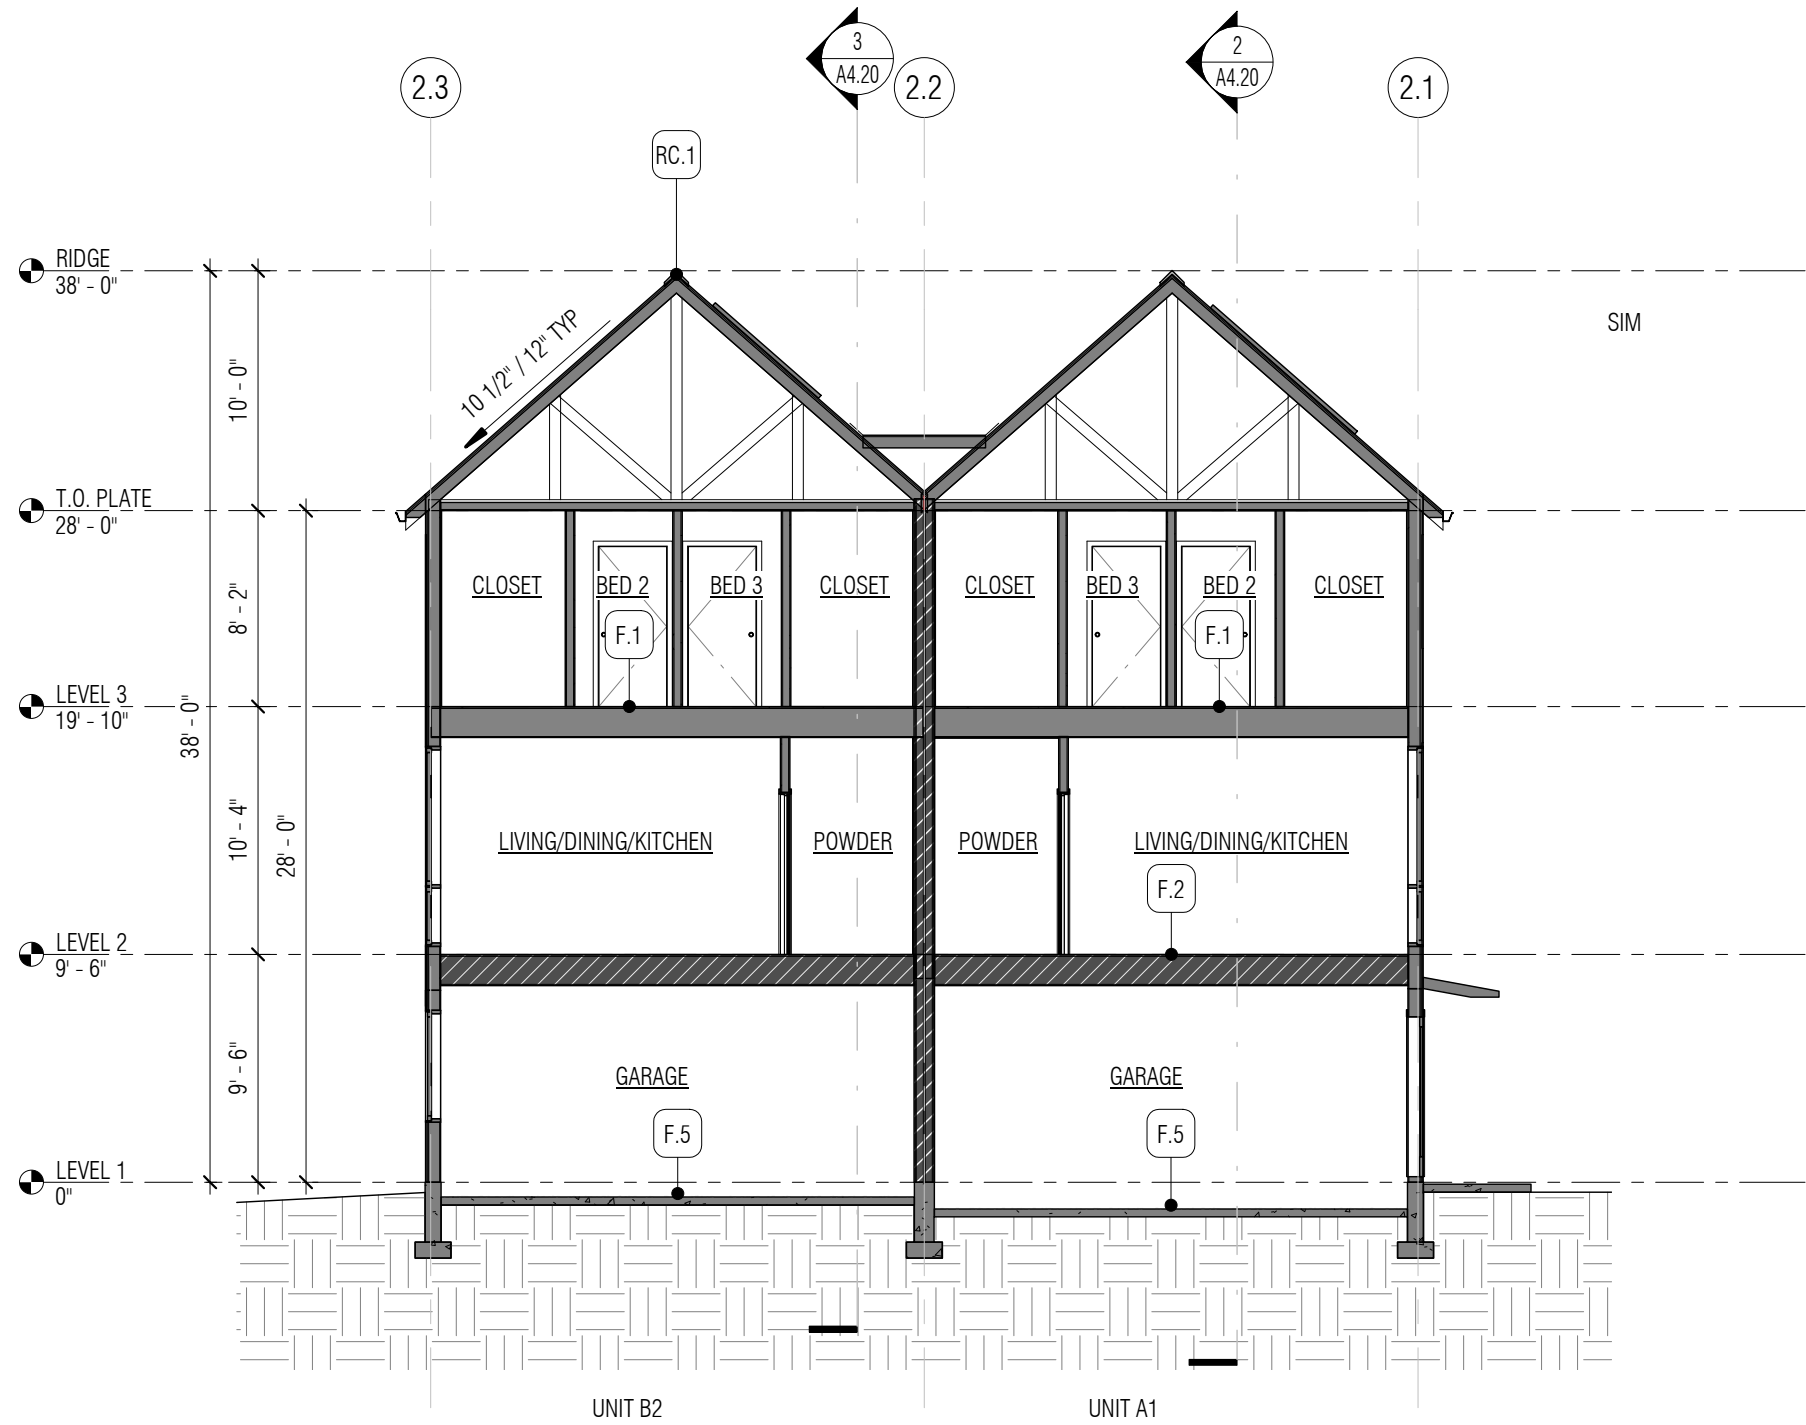

2 2-PACK TOWNHOUSE (A-B) - SHORT SECTION THROUGH UNIT A.1
1/8" = 1'-0"

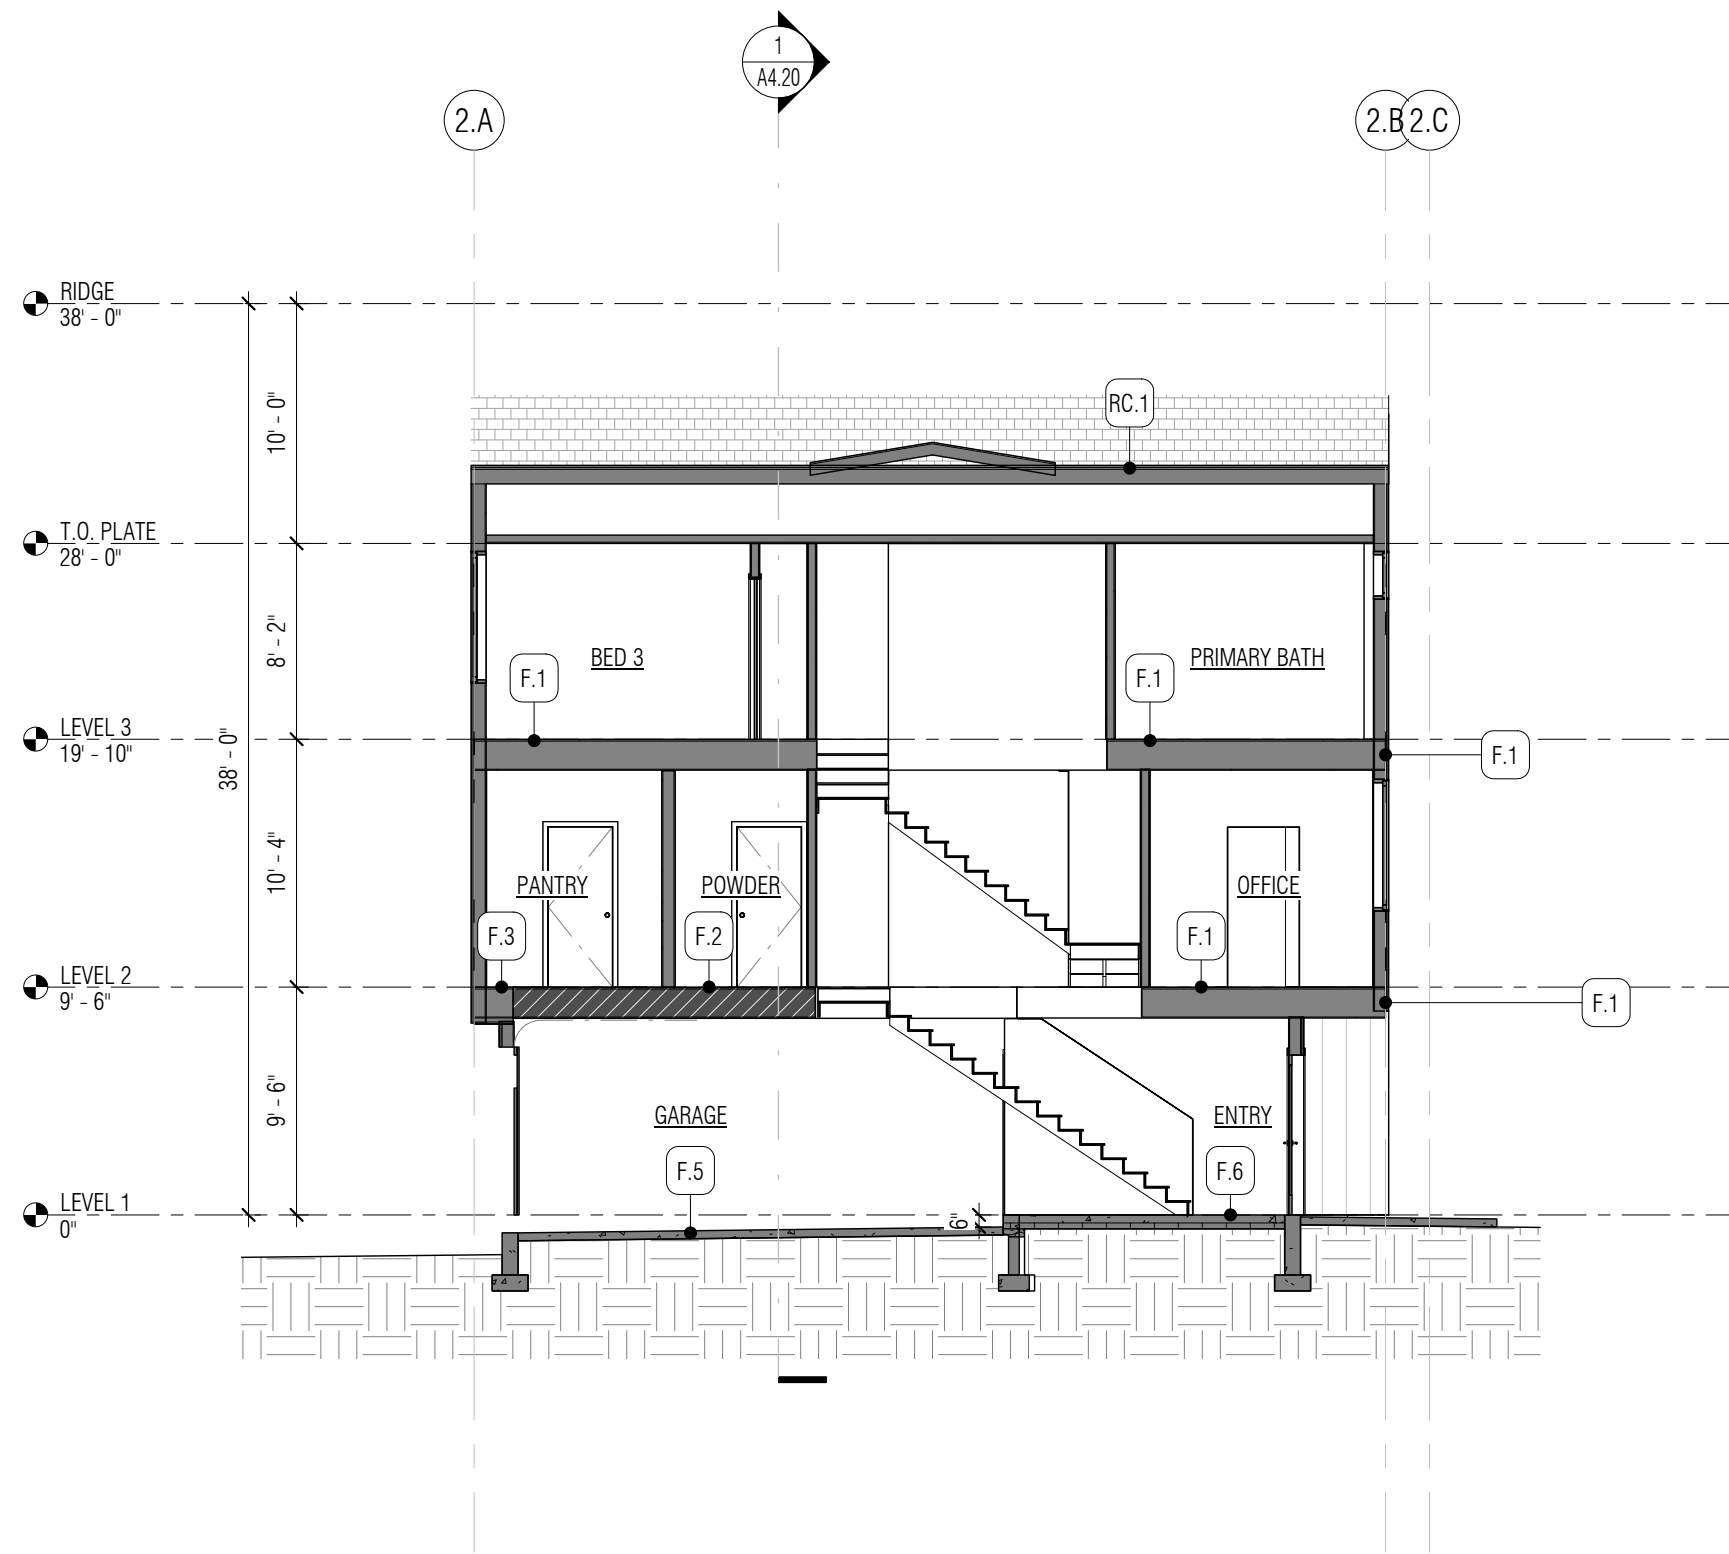



3 2-PACK TOWNHOUSE (A-B) - SHORT SECTION THROUGH UNIT B.2
1/8" = 1'-0"


GENERAL NOTES - BUILDING SECTIONS

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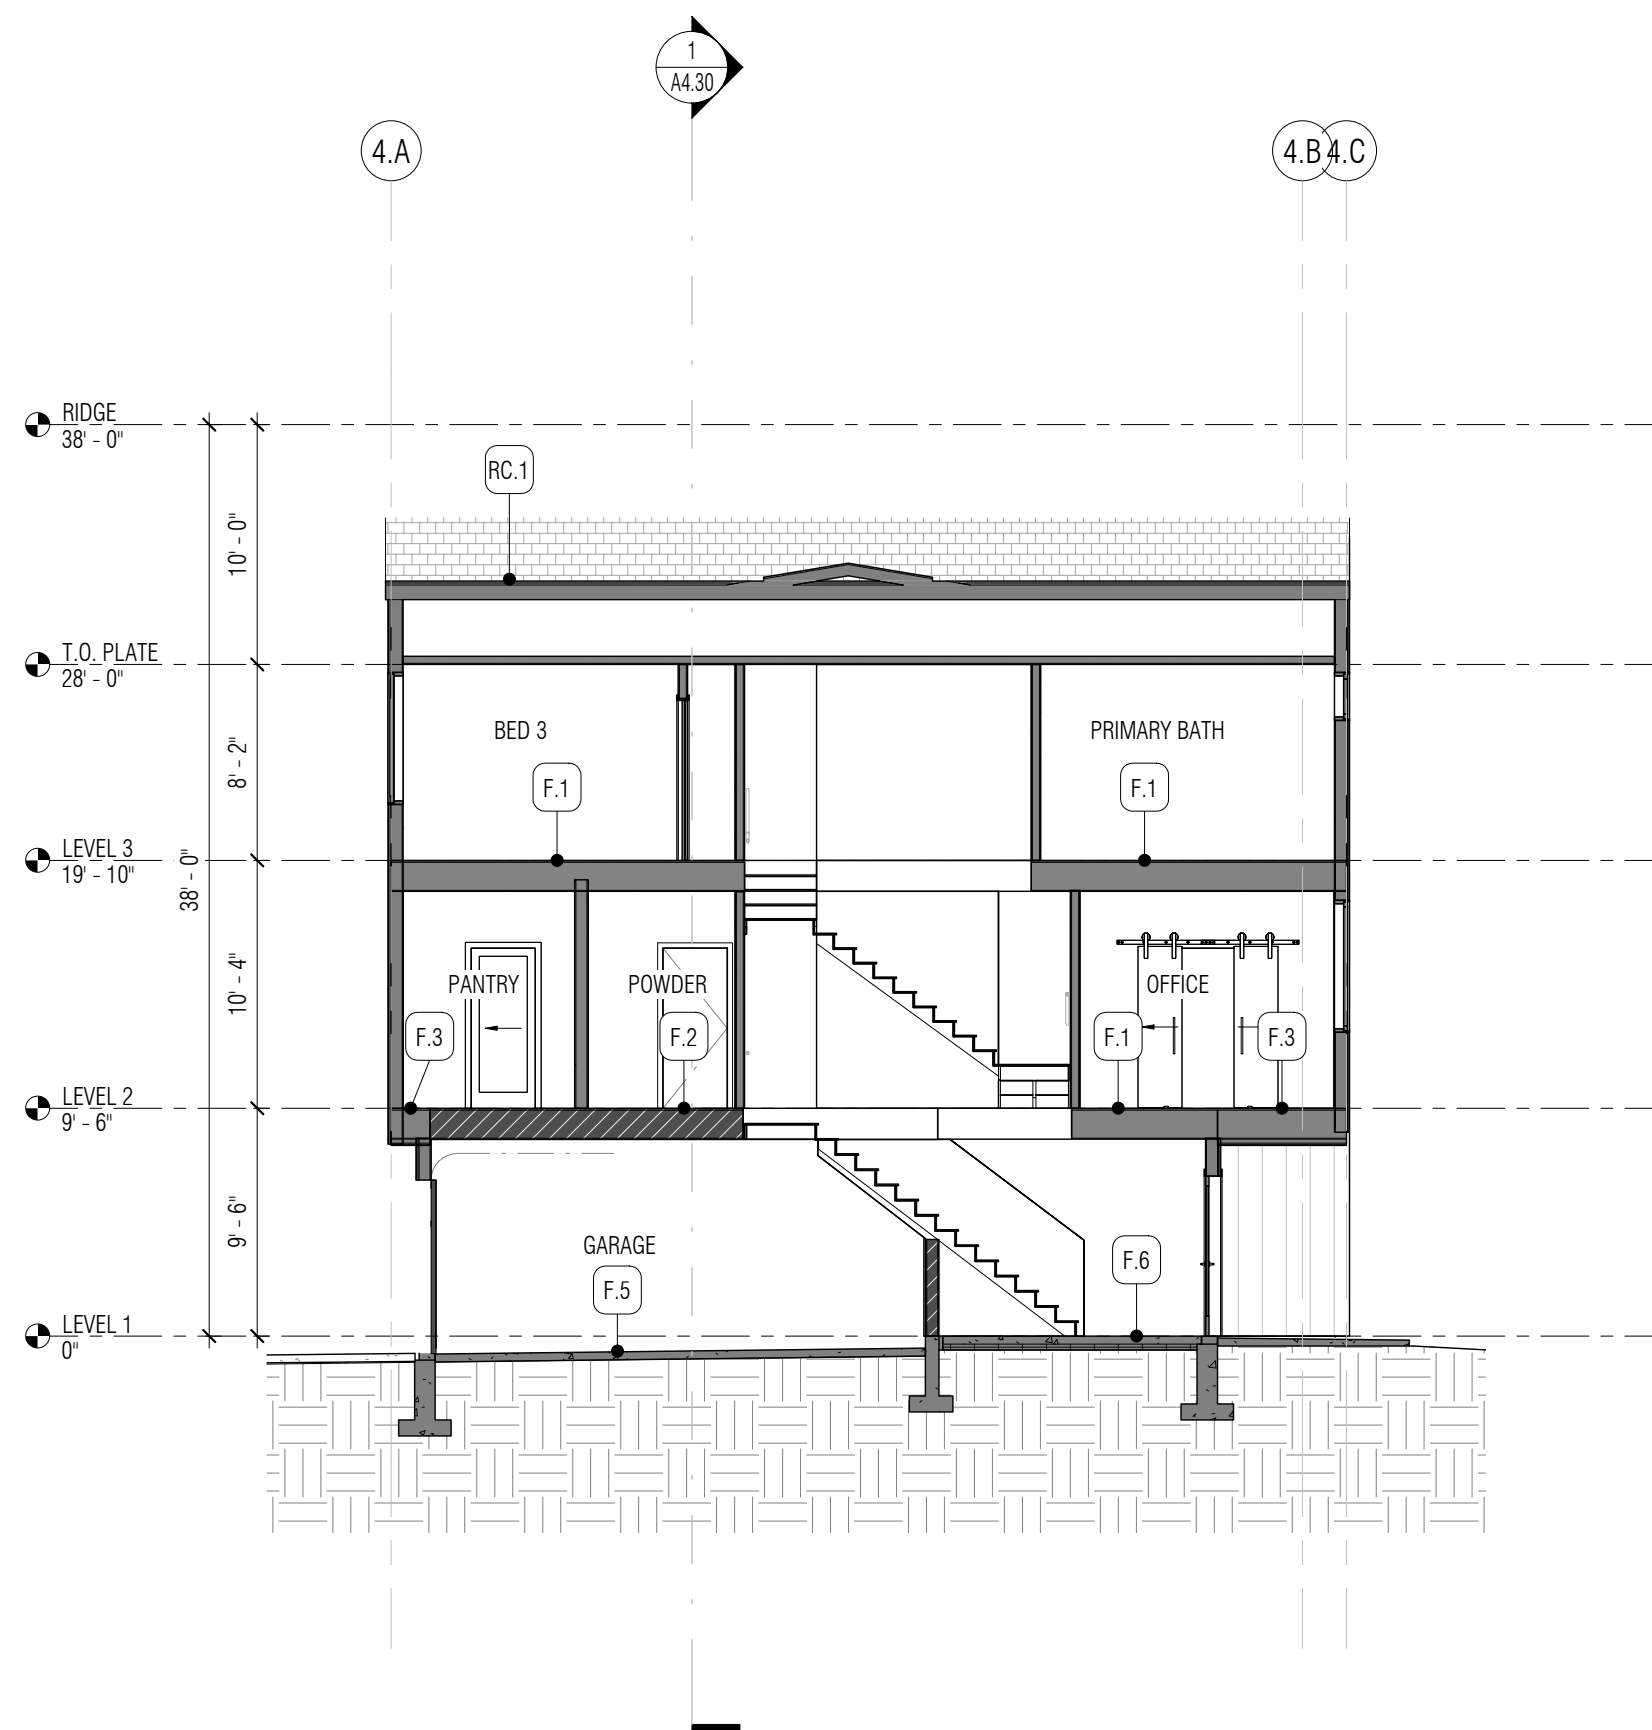
WALL LEGEND

	NEW WALL
	NEW CONC WALL
	1-HR RATED ASSEMBLY




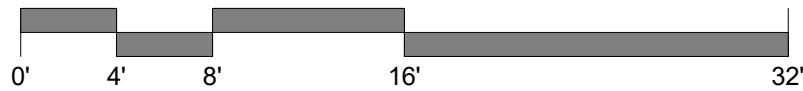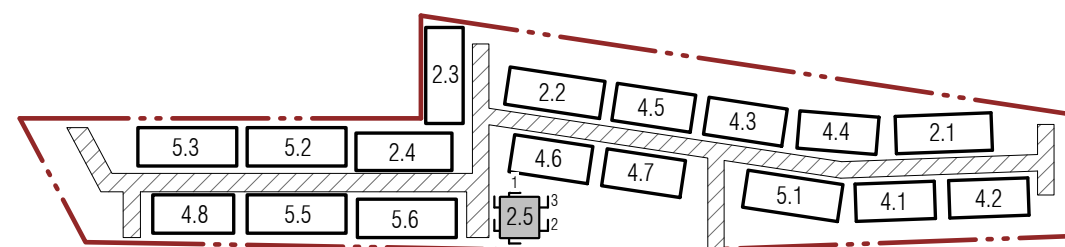

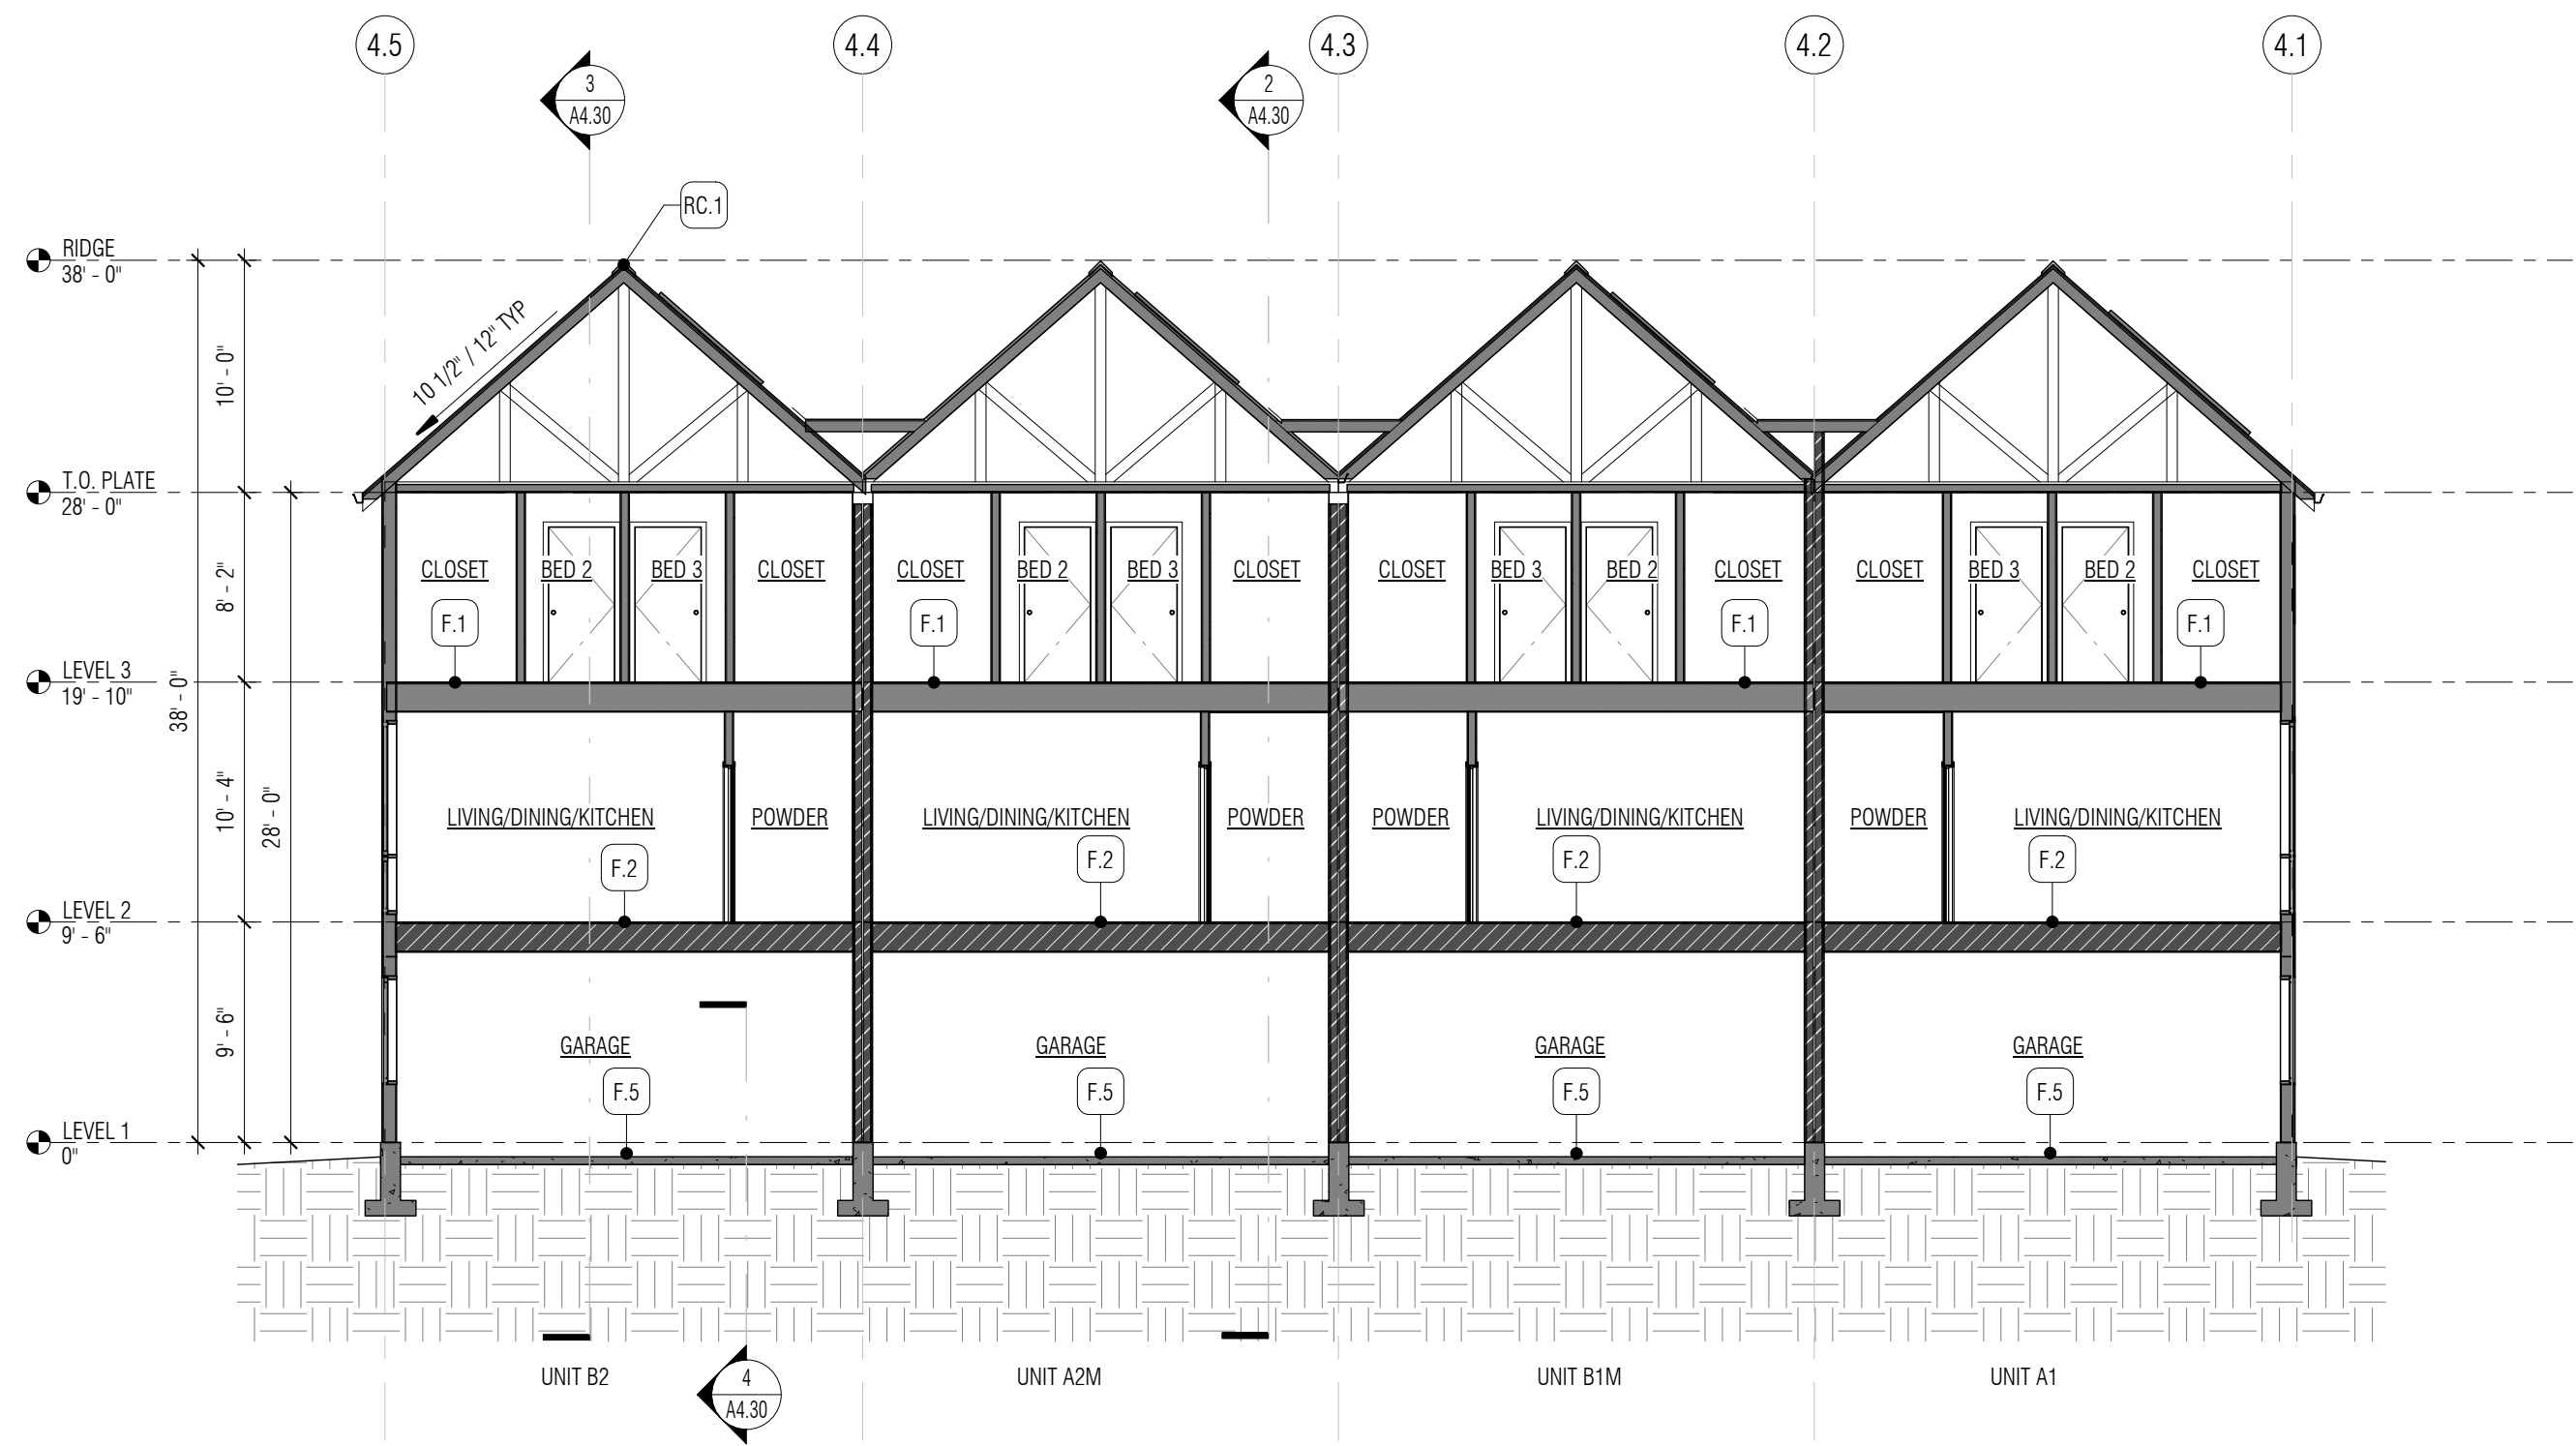
1 4-PACK TOWNHOUSE "A-B-A-B" - LONG SECTION
1/8" = 1'-0"



2 4-PACK TOWNHOUSE "A-B-A-B" - SHORT SECTION THROUGH UNIT A2.M ENTRY
1/8" = 1'-0"

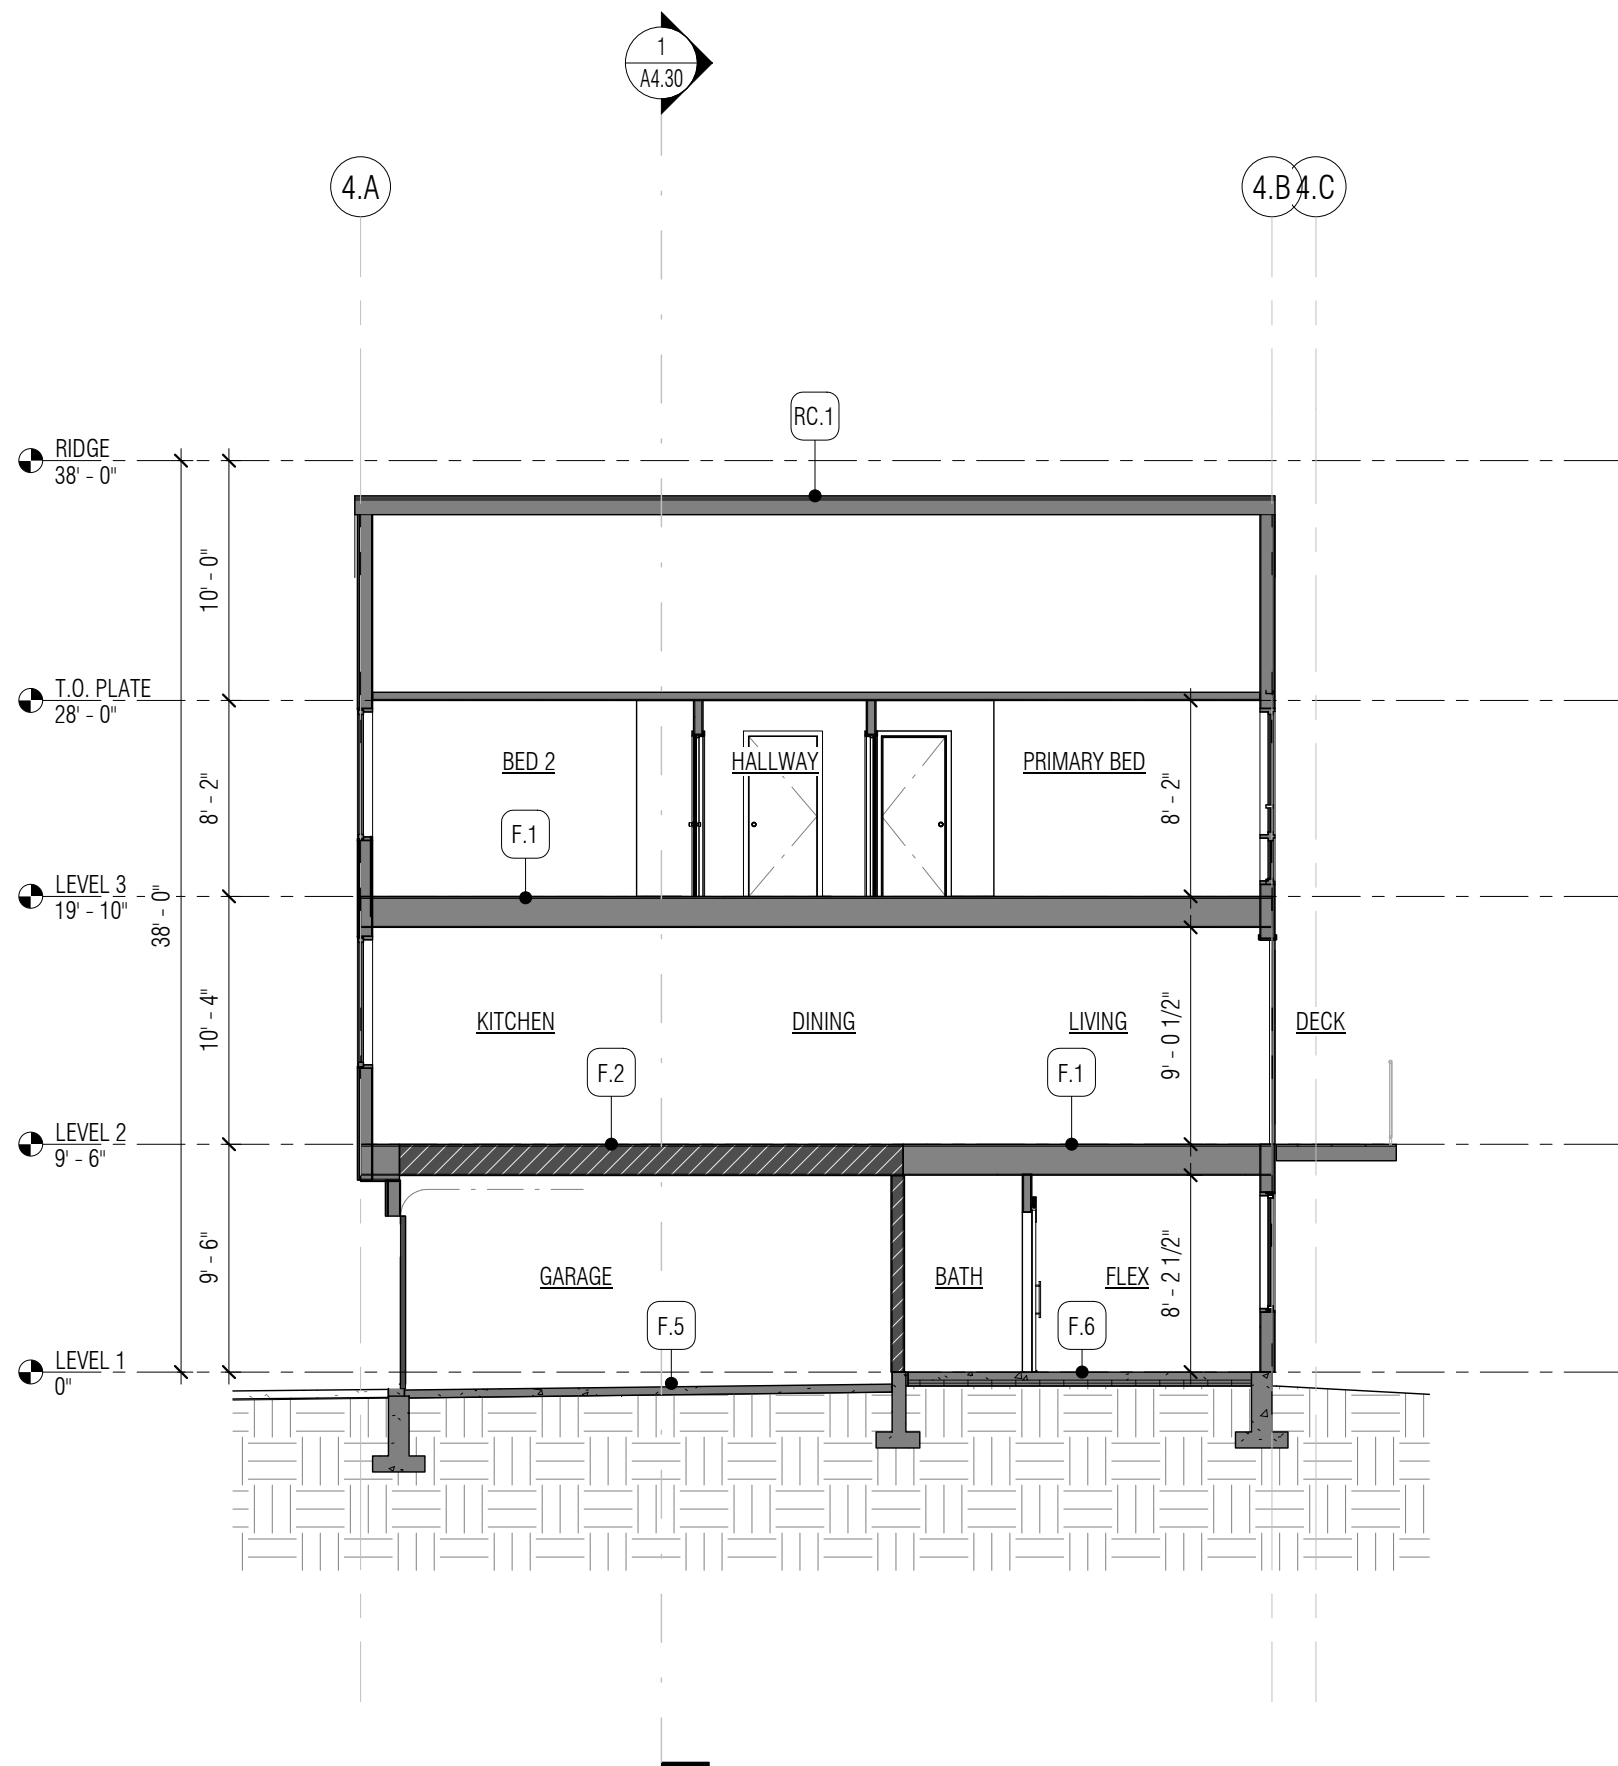

3 4-PACK TOWNHOUSE "A-B-A-B" - SHORT SECTION THROUGH UNIT B.2
1/8" = 1'-0"

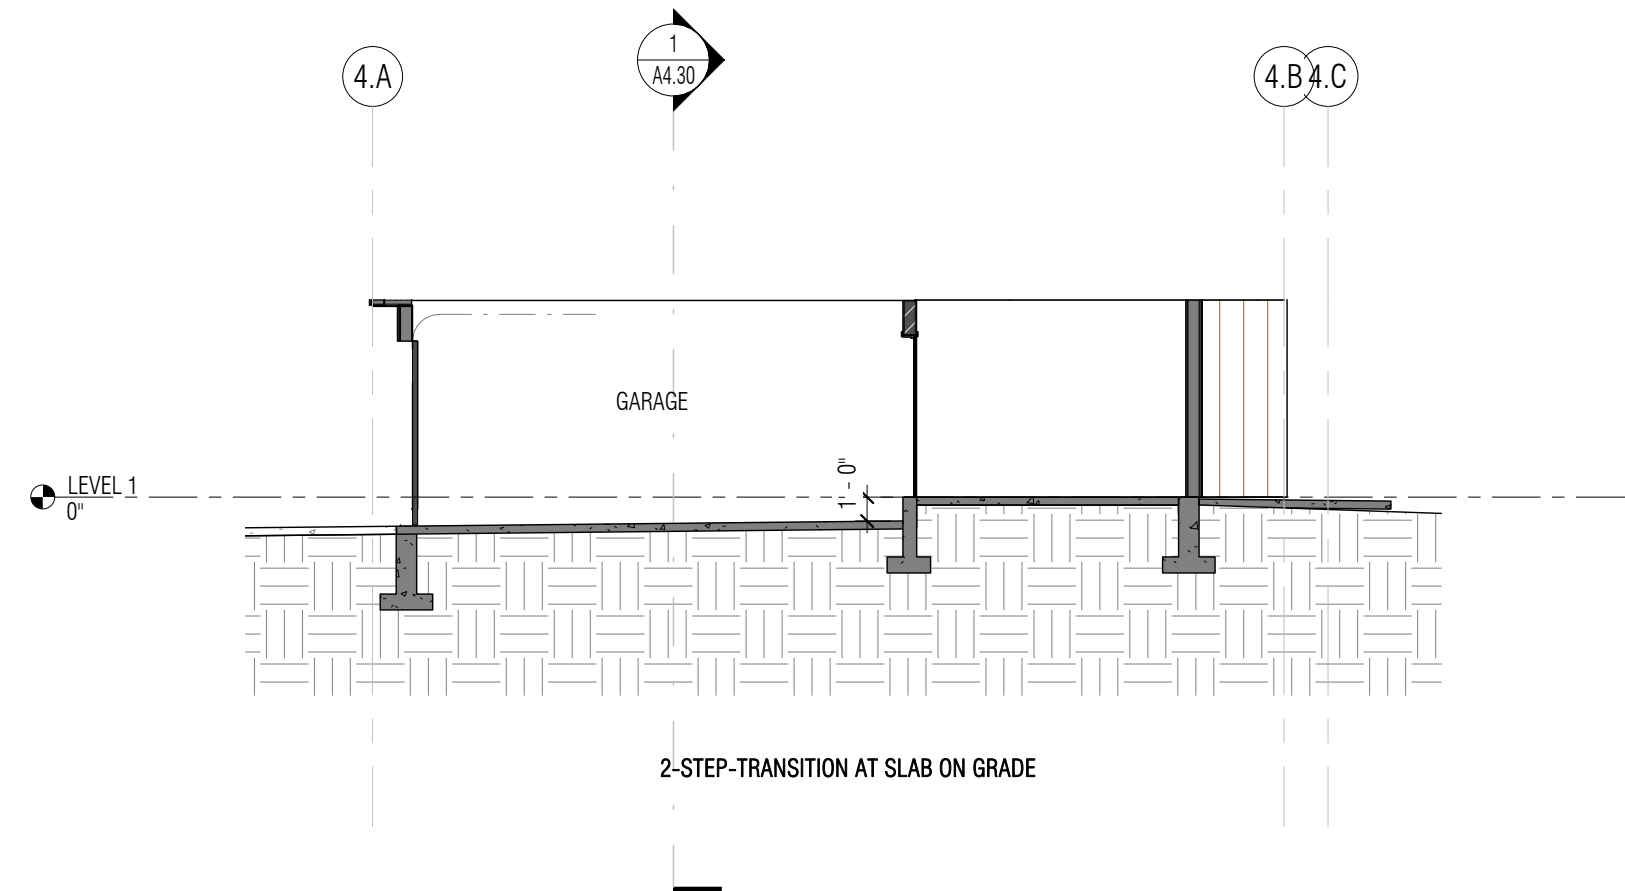



4 4-PACK TOWNHOUSE "A-B-A-B" - SHORT SECTION THRU GARAGE AT INTERIOR TRANSITION
1/8" = 1'-0"


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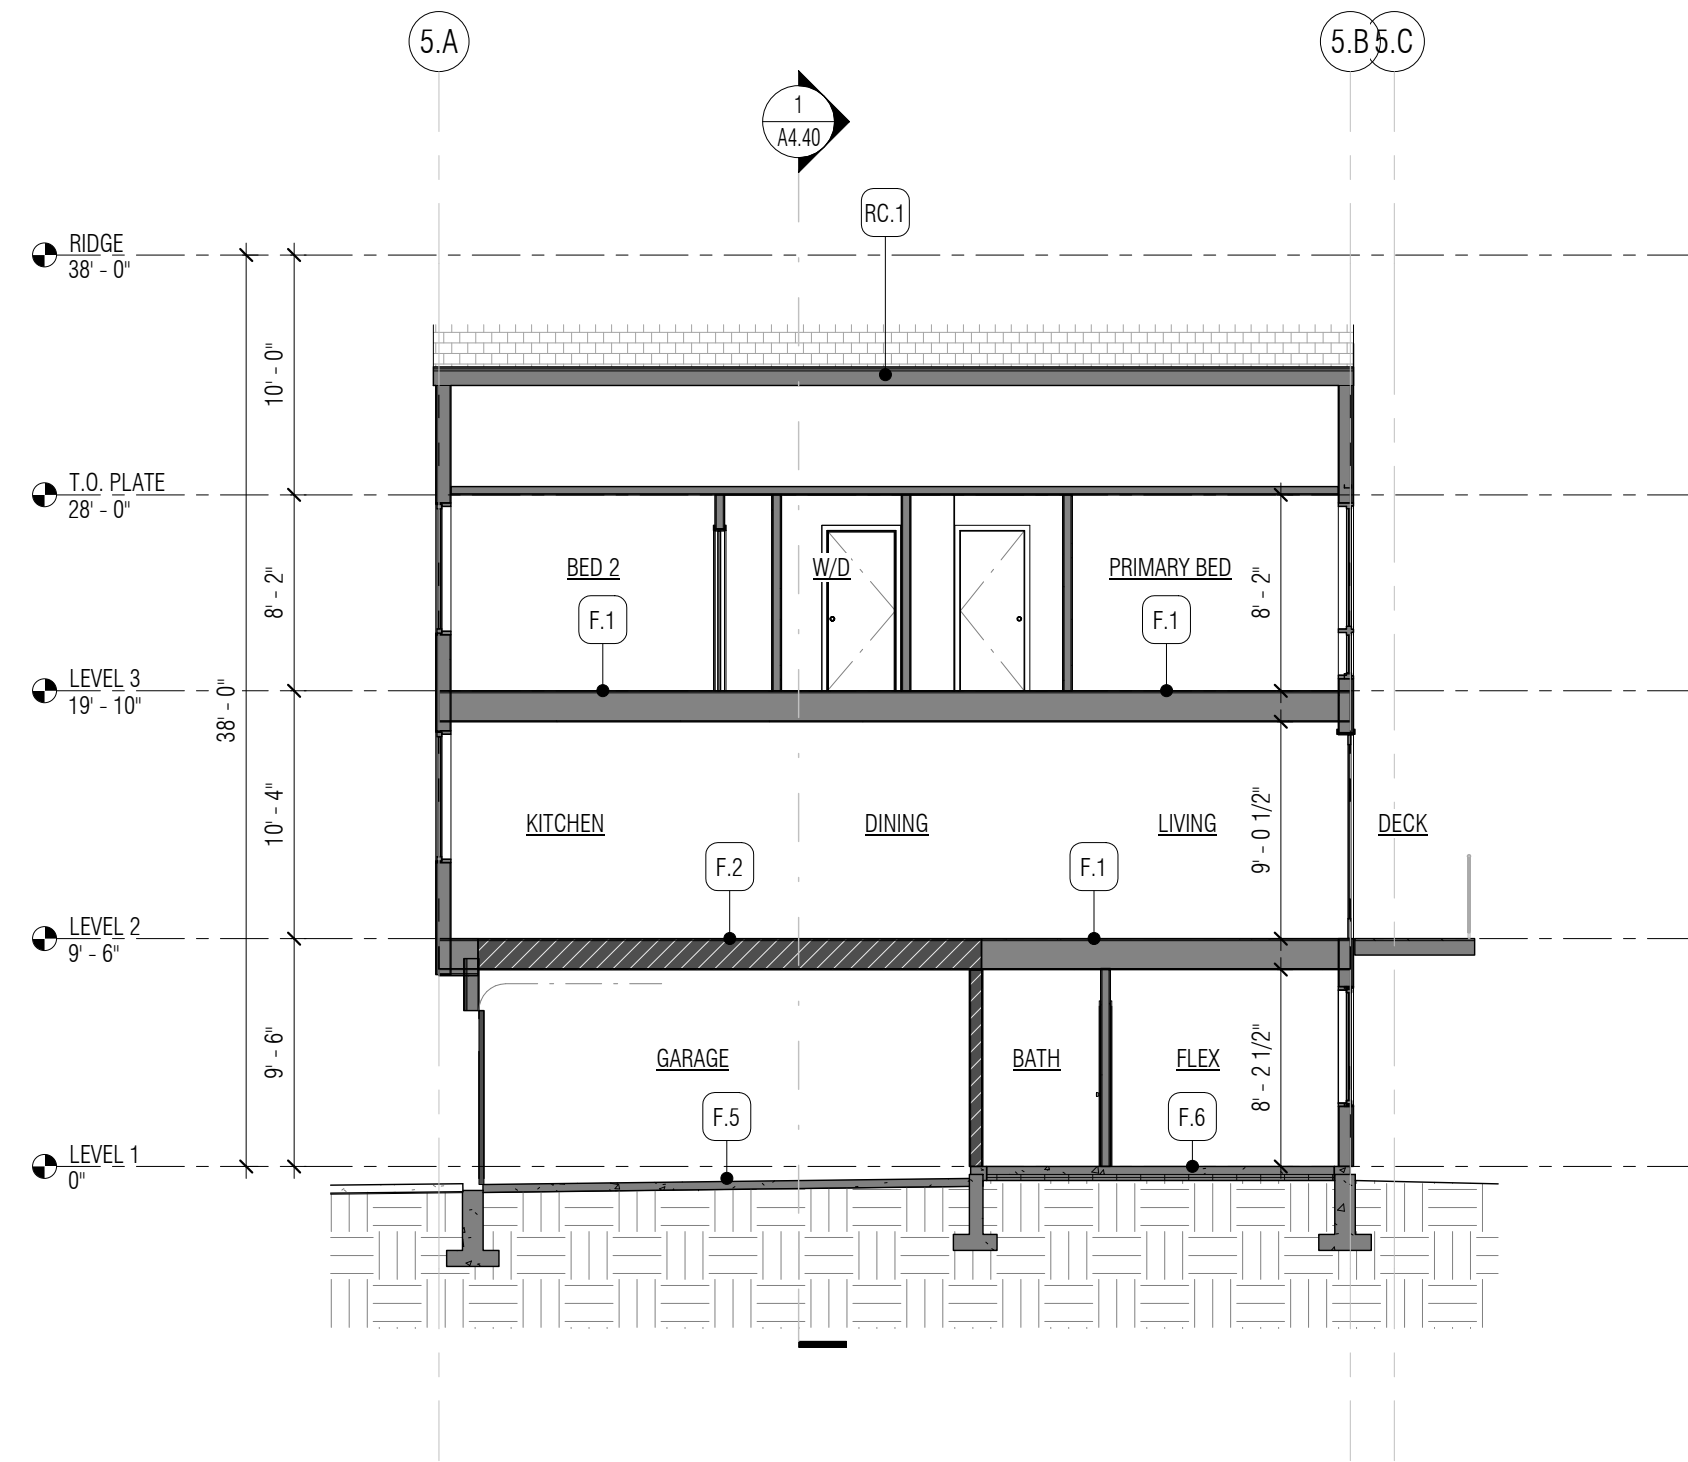
WALL LEGEND

- NEW WALL
- NEW CONC WALL
- 1-HR RATED ASSEMBLY




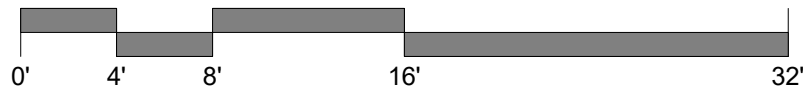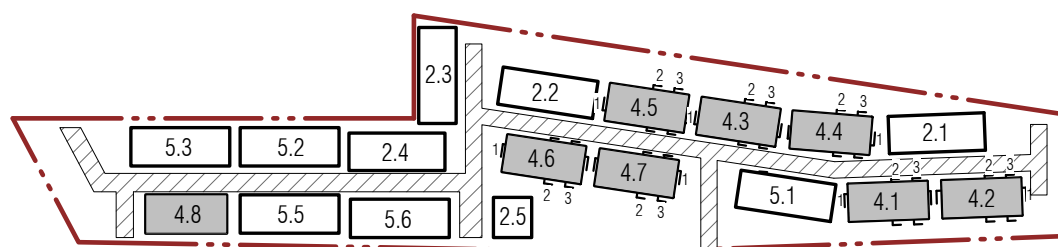




1 5-PACK TOWNHOUSE "A-B-A-B-A" - LONG SECTION
1/8" = 1'-0"

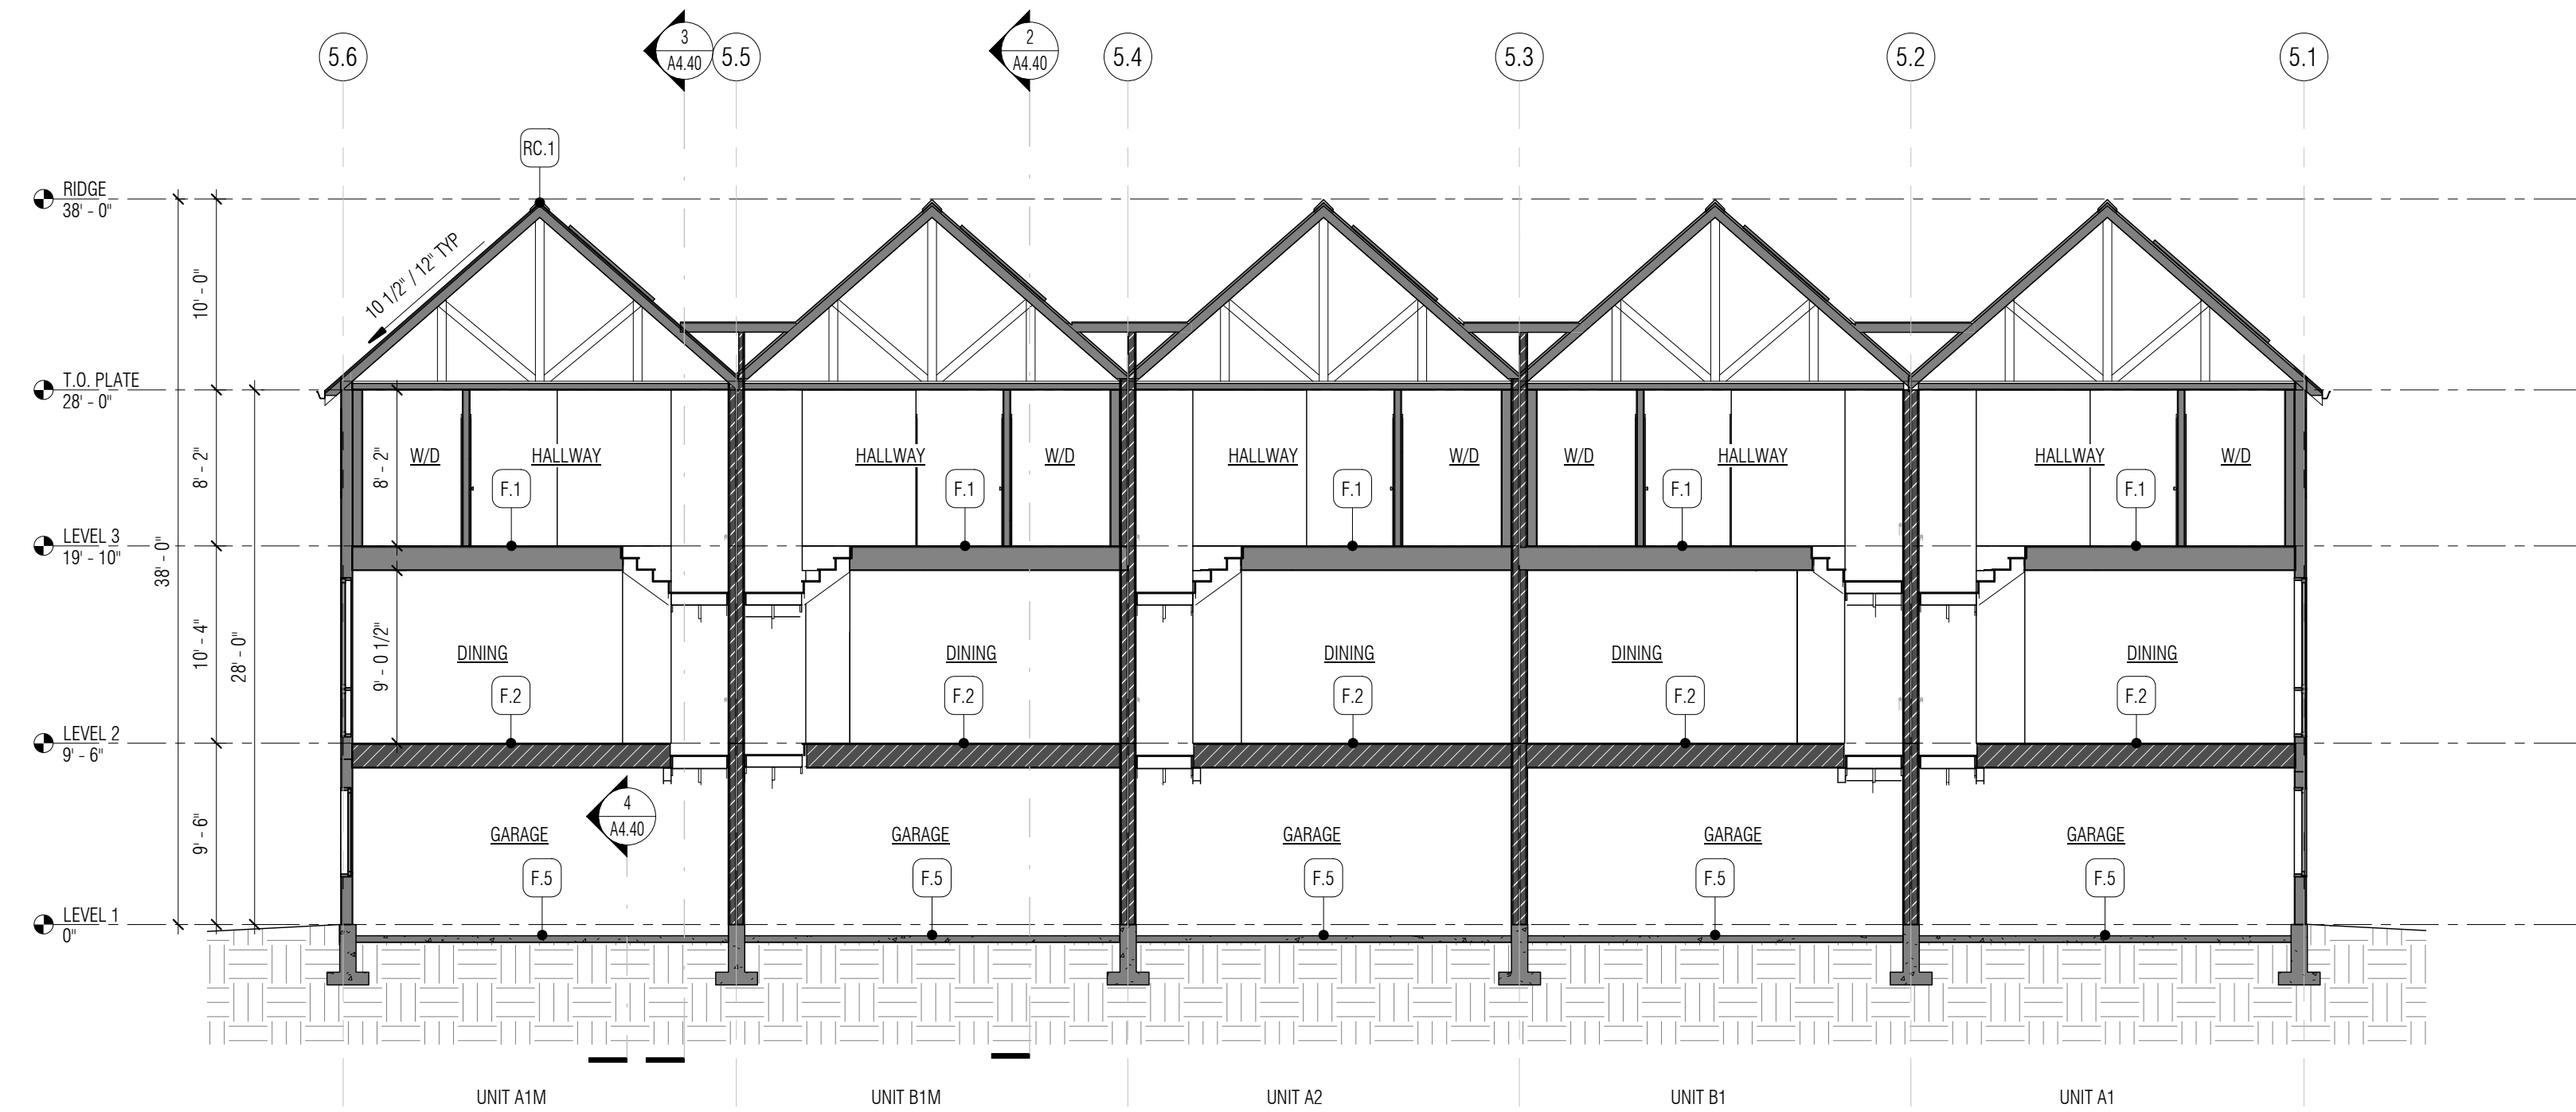


2 5-PACK TOWNHOUSE "A-B-A-B-A" - SHORT SECTION THROUGH UNIT B.1
1/8" = 1'-0"

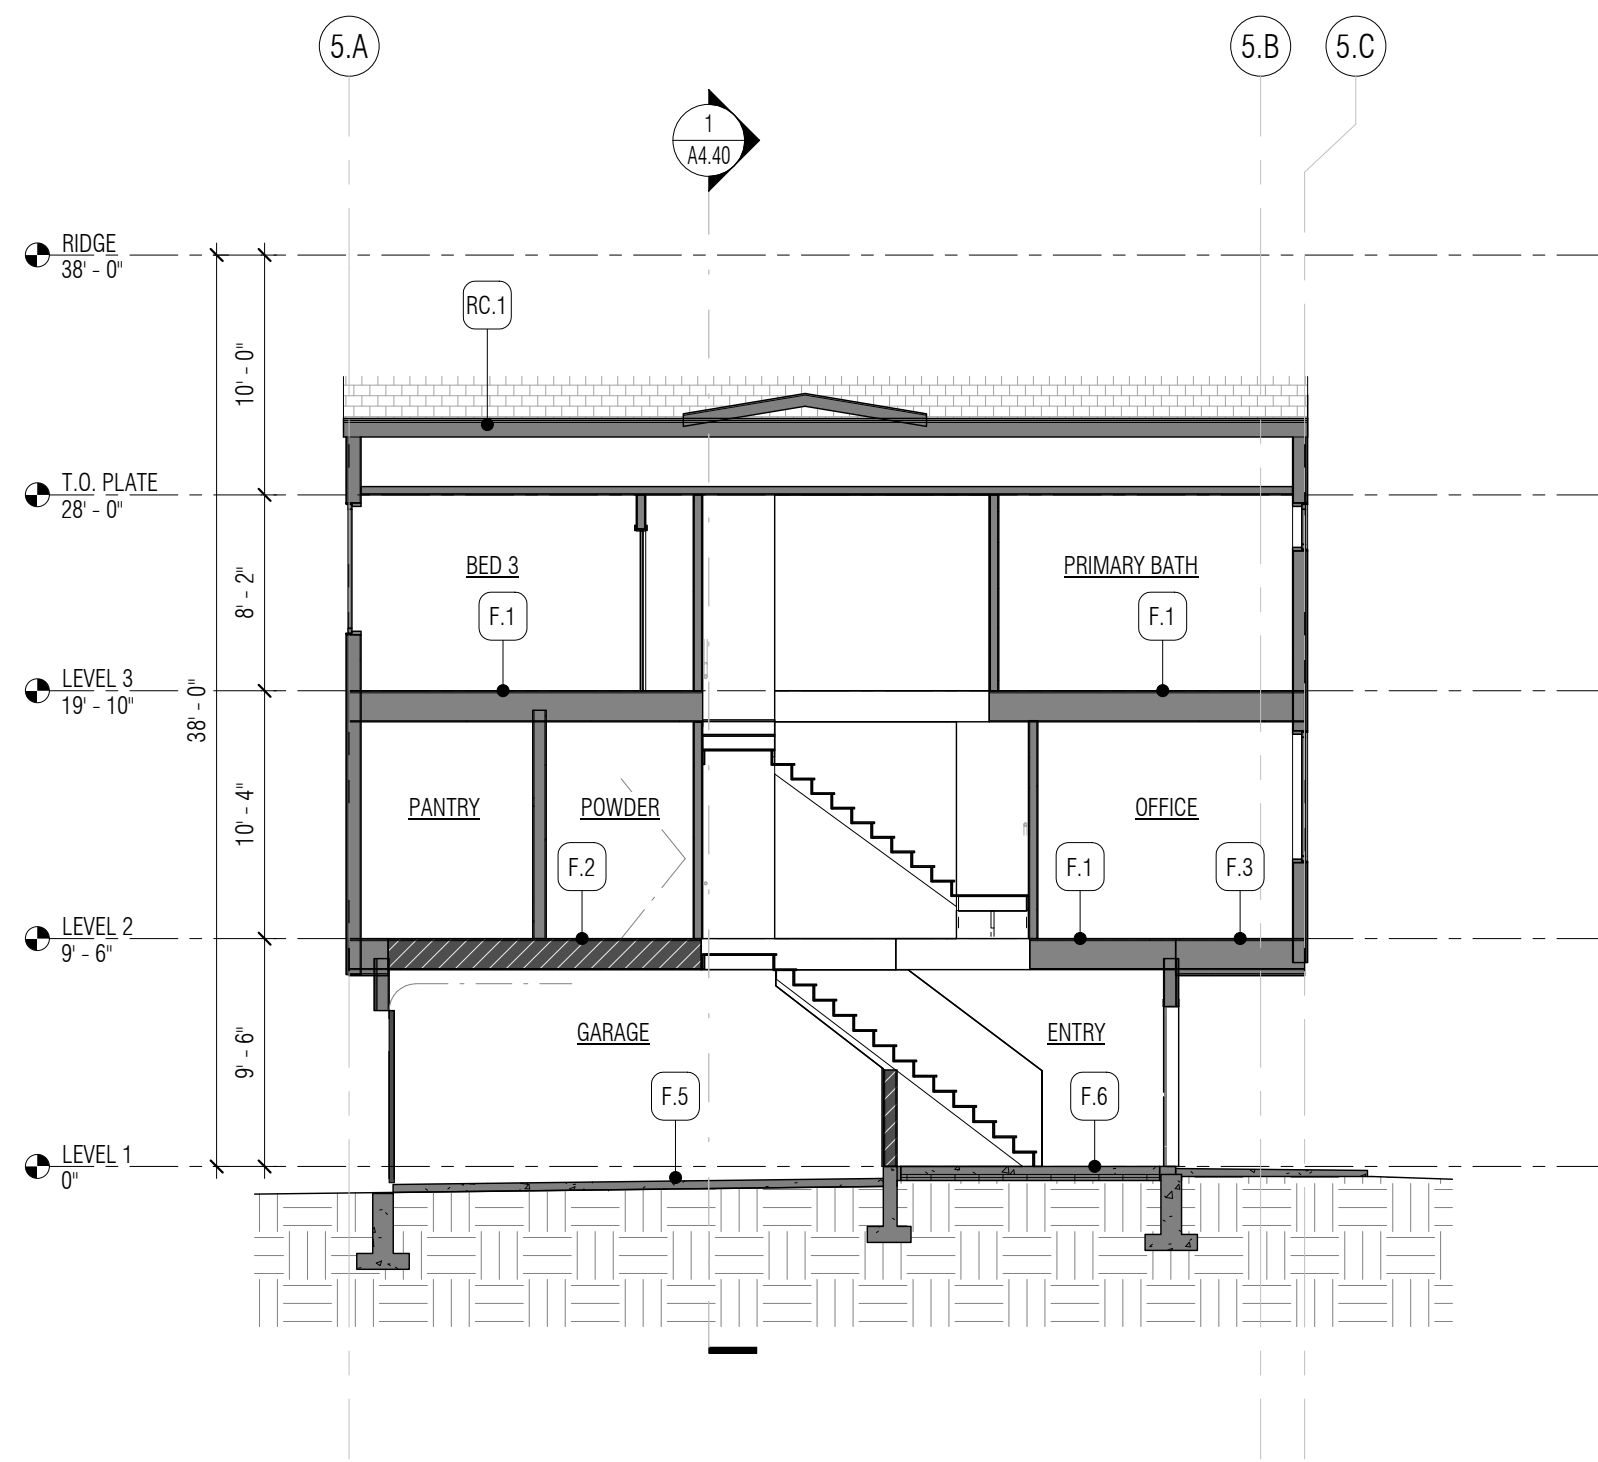

3 5-PACK TOWNHOUSE "A-B-A-B-A" - SHORT SECTION THROUGH UNIT A1.M
1/8" = 1'-0"

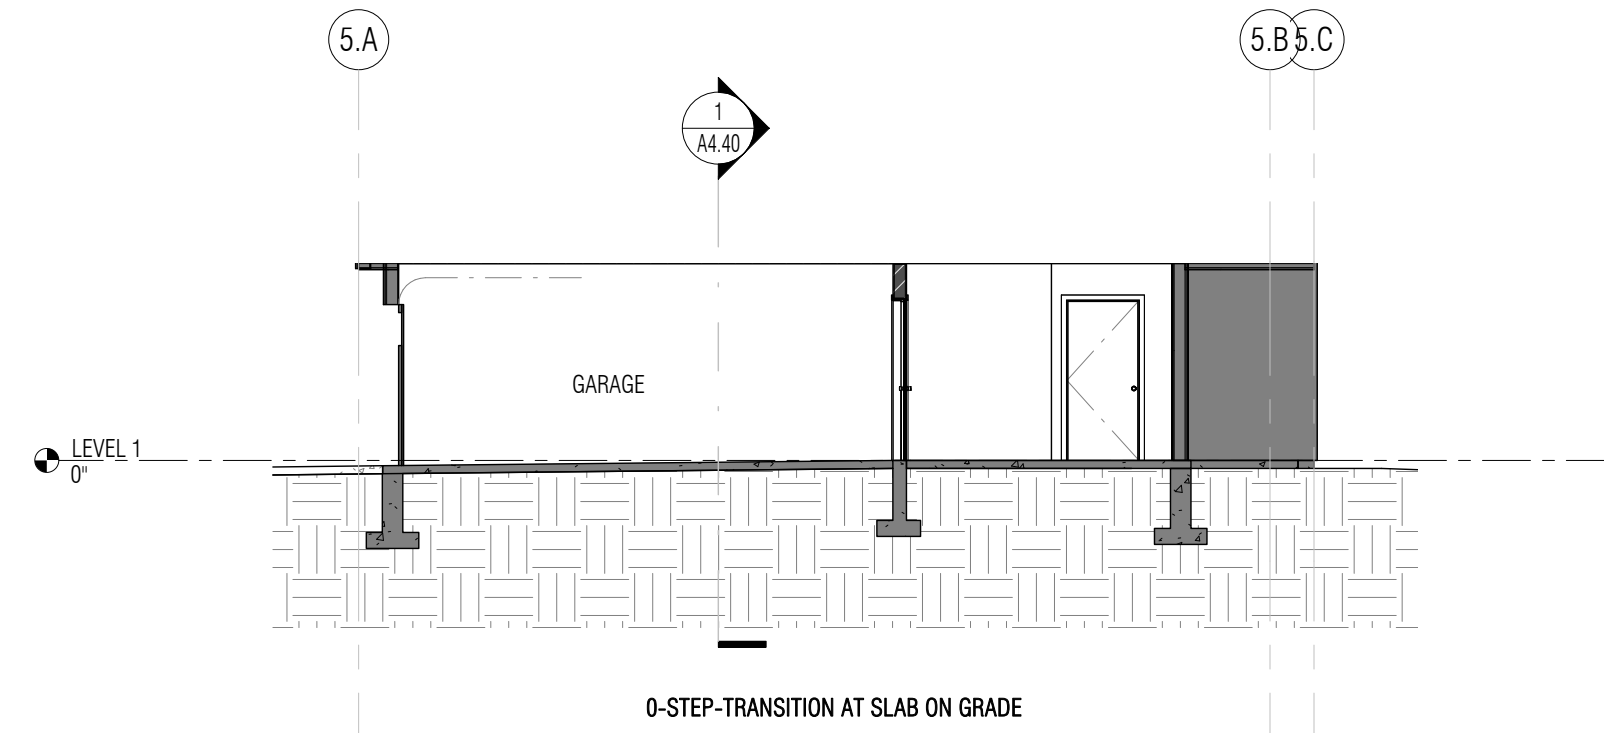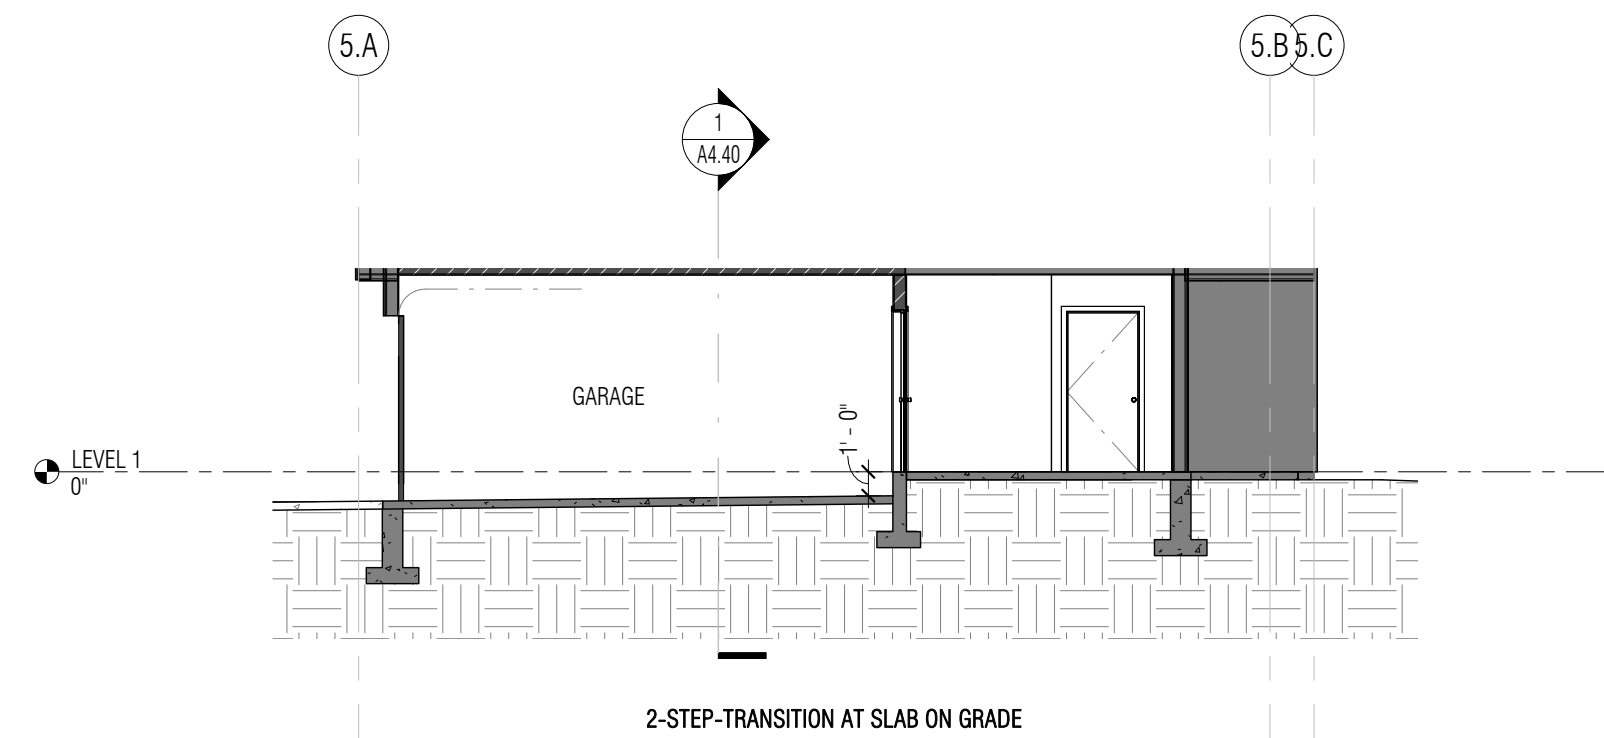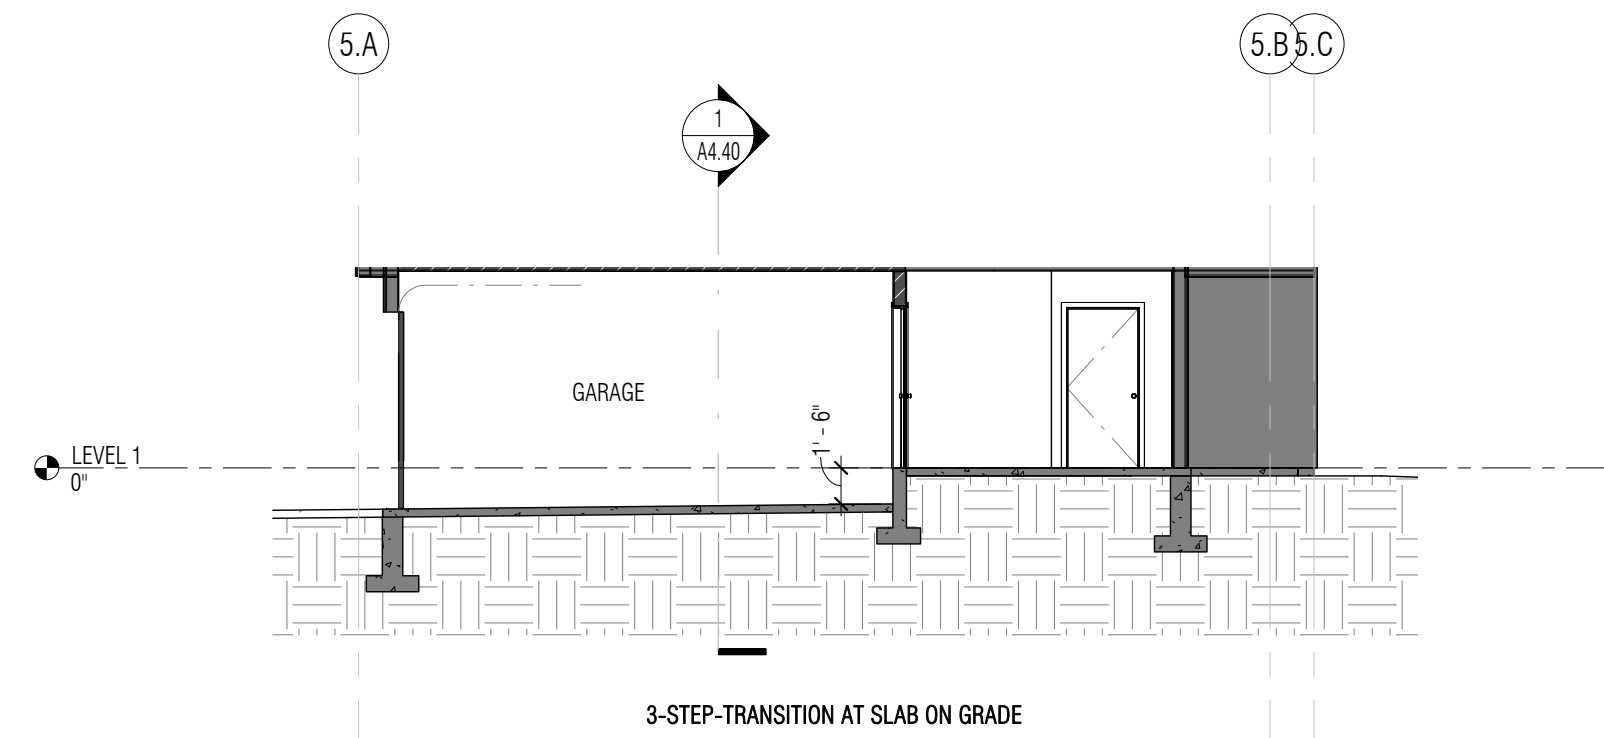

4 5-PACK TOWNHOUSE "A-B-A-B-A" - SHORT SECTION THRU GARAGE AT INTERIOR TRANSITION
1/8" = 1'-0"

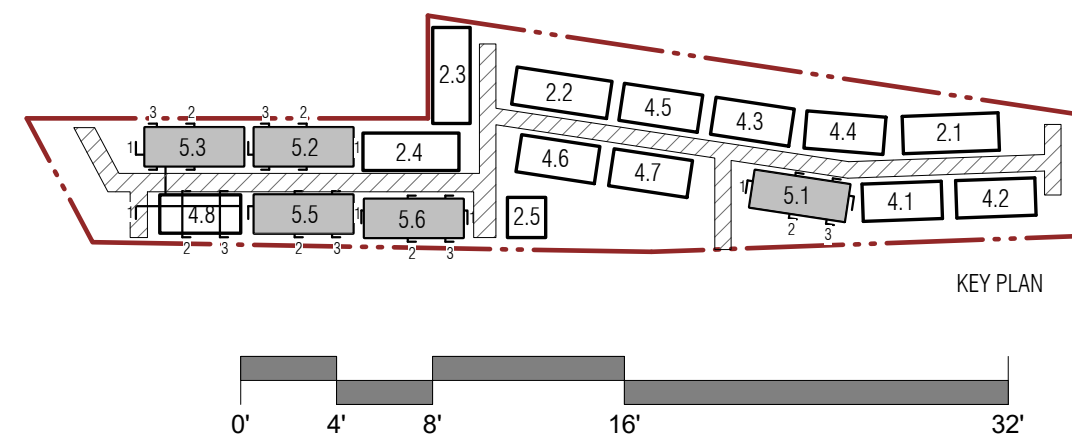


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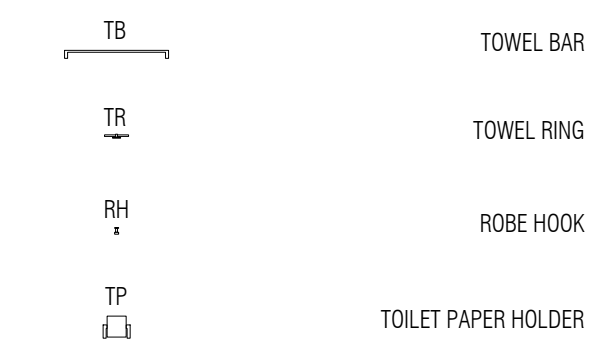
WALL LEGEND

- NEW WALL
- NEW CONC WALL
- 1-HR RATED ASSEMBLY

FLOOR PLAN KEY




UNIT PLAN KEY

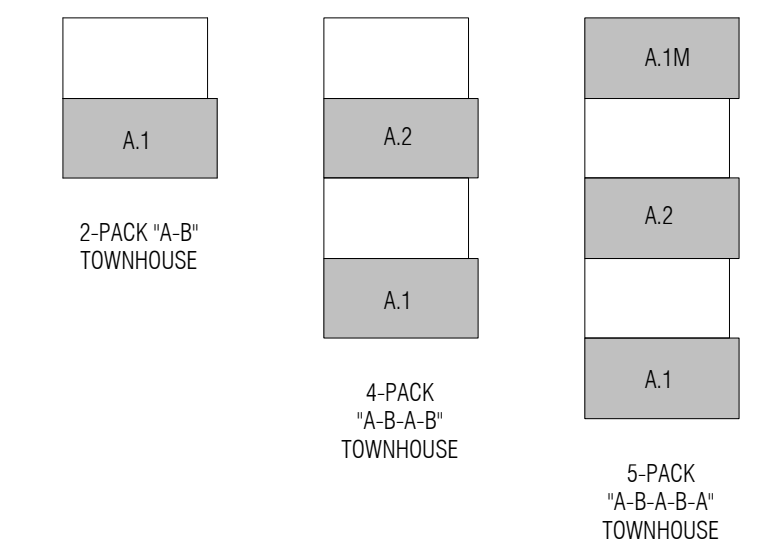


GENERAL NOTES - UNIT PLANS


- ALL INTERIOR WALLS ARE 1.0 UNO. PROVIDE 3-1/2" SOUND INSULATION IN COMMON PARTY WALLS.
- ALL EXTERIOR WALLS ARE E.1 UNO.
- ALL EXTERIOR DIMENSIONS ARE MEASURED FROM GRID LINE TO GRID LINE OR FACE OF FRAMING. ALL INTERIOR DIMENSIONS ARE FROM FACE OF STUD.
- GRIDS ARE ALIGNED WITH THE EXTERIOR FACE OF FRAMING AT EXTERIOR WALLS AND ALIGNED WITH THE CENTER OF THE PARTY WALLS.
- WINDOW DIMENSIONS ARE GIVEN AS NOMINAL MEASUREMENTS.
- DOOR ROUGH OPENINGS ARE 4" OFF STUD FACE OF PERP. WALL (TO HINGED SIDE OF THE DOOR) UNO
- ALL FINISH FLOOR MATERIALS TO ALIGN WITH ADJACENT FLOOR FINISH
- DIMENSIONS AT POSTS ARE TO CENTERLINES UNO - VERIFY ALL STRUCTURAL LOCATIONS WITH FRAMING PLANS
- SEE EXTERIOR ELEVATION SHEETS FOR WINDOW TAGS
- SEE SHEETS GENERAL SHEETS CODE, DIMENSIONING AND GENERAL NOTES
- SEE SHEET A7.00 SERIES FOR DOOR & WINDOW SCHEDULE
- THE MAIN ELECTRICAL SERVICE OR FEEDER PANEL FOR EACH DWELLING UNIT SHALL HAVE A RESERVED SPACE TO ALLOW INSTALLATION OF A DUAL POLE CIRCUIT BREAKER FOR FUTURE SOLAR ELECTRIC INSTALLATION AND SHALL BE LABELED FOR FUTURE SOLAR ELECTRIC.
- A PERMANENT CERTIFICATE, INDICATING THE BOUNDARIES AND STRUCTURAL PROVISIONS OF THE SOLAR-READY ZONE, SHALL BE POSTED NEAR THE ELECTRICAL DISTRIBUTION PANEL, WATER HEATER OF OTHER CONSPICUOUS LOCATION.

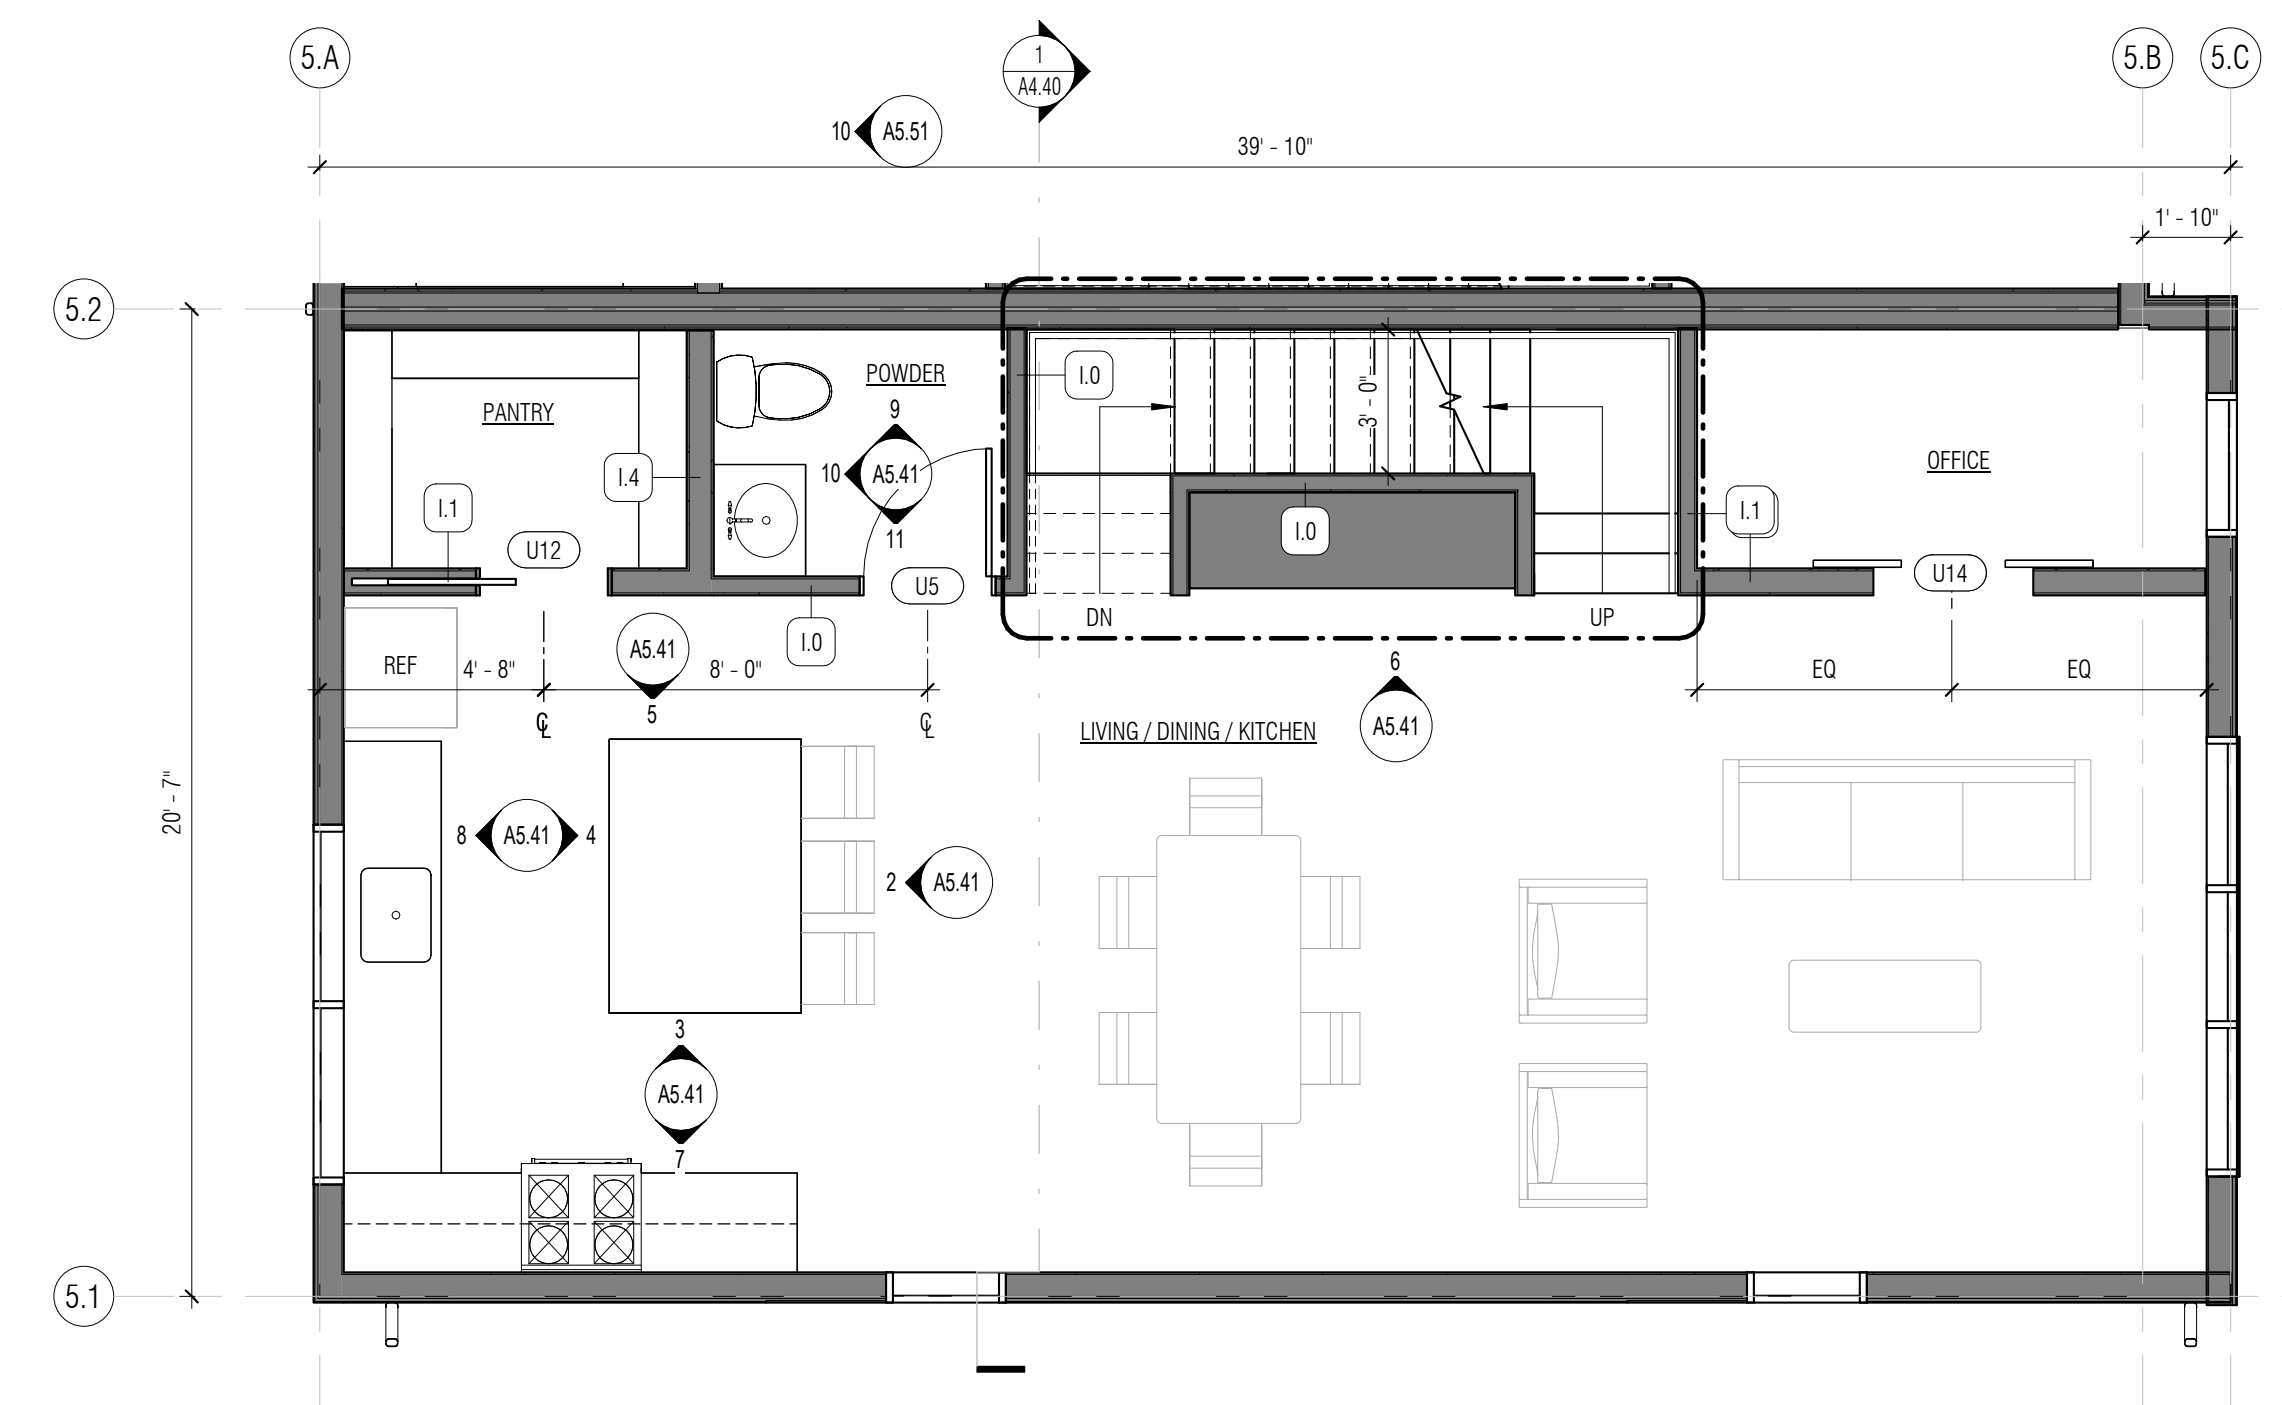


2 FLOOR PLAN - LEVEL 2
1/4" = 1'-0"

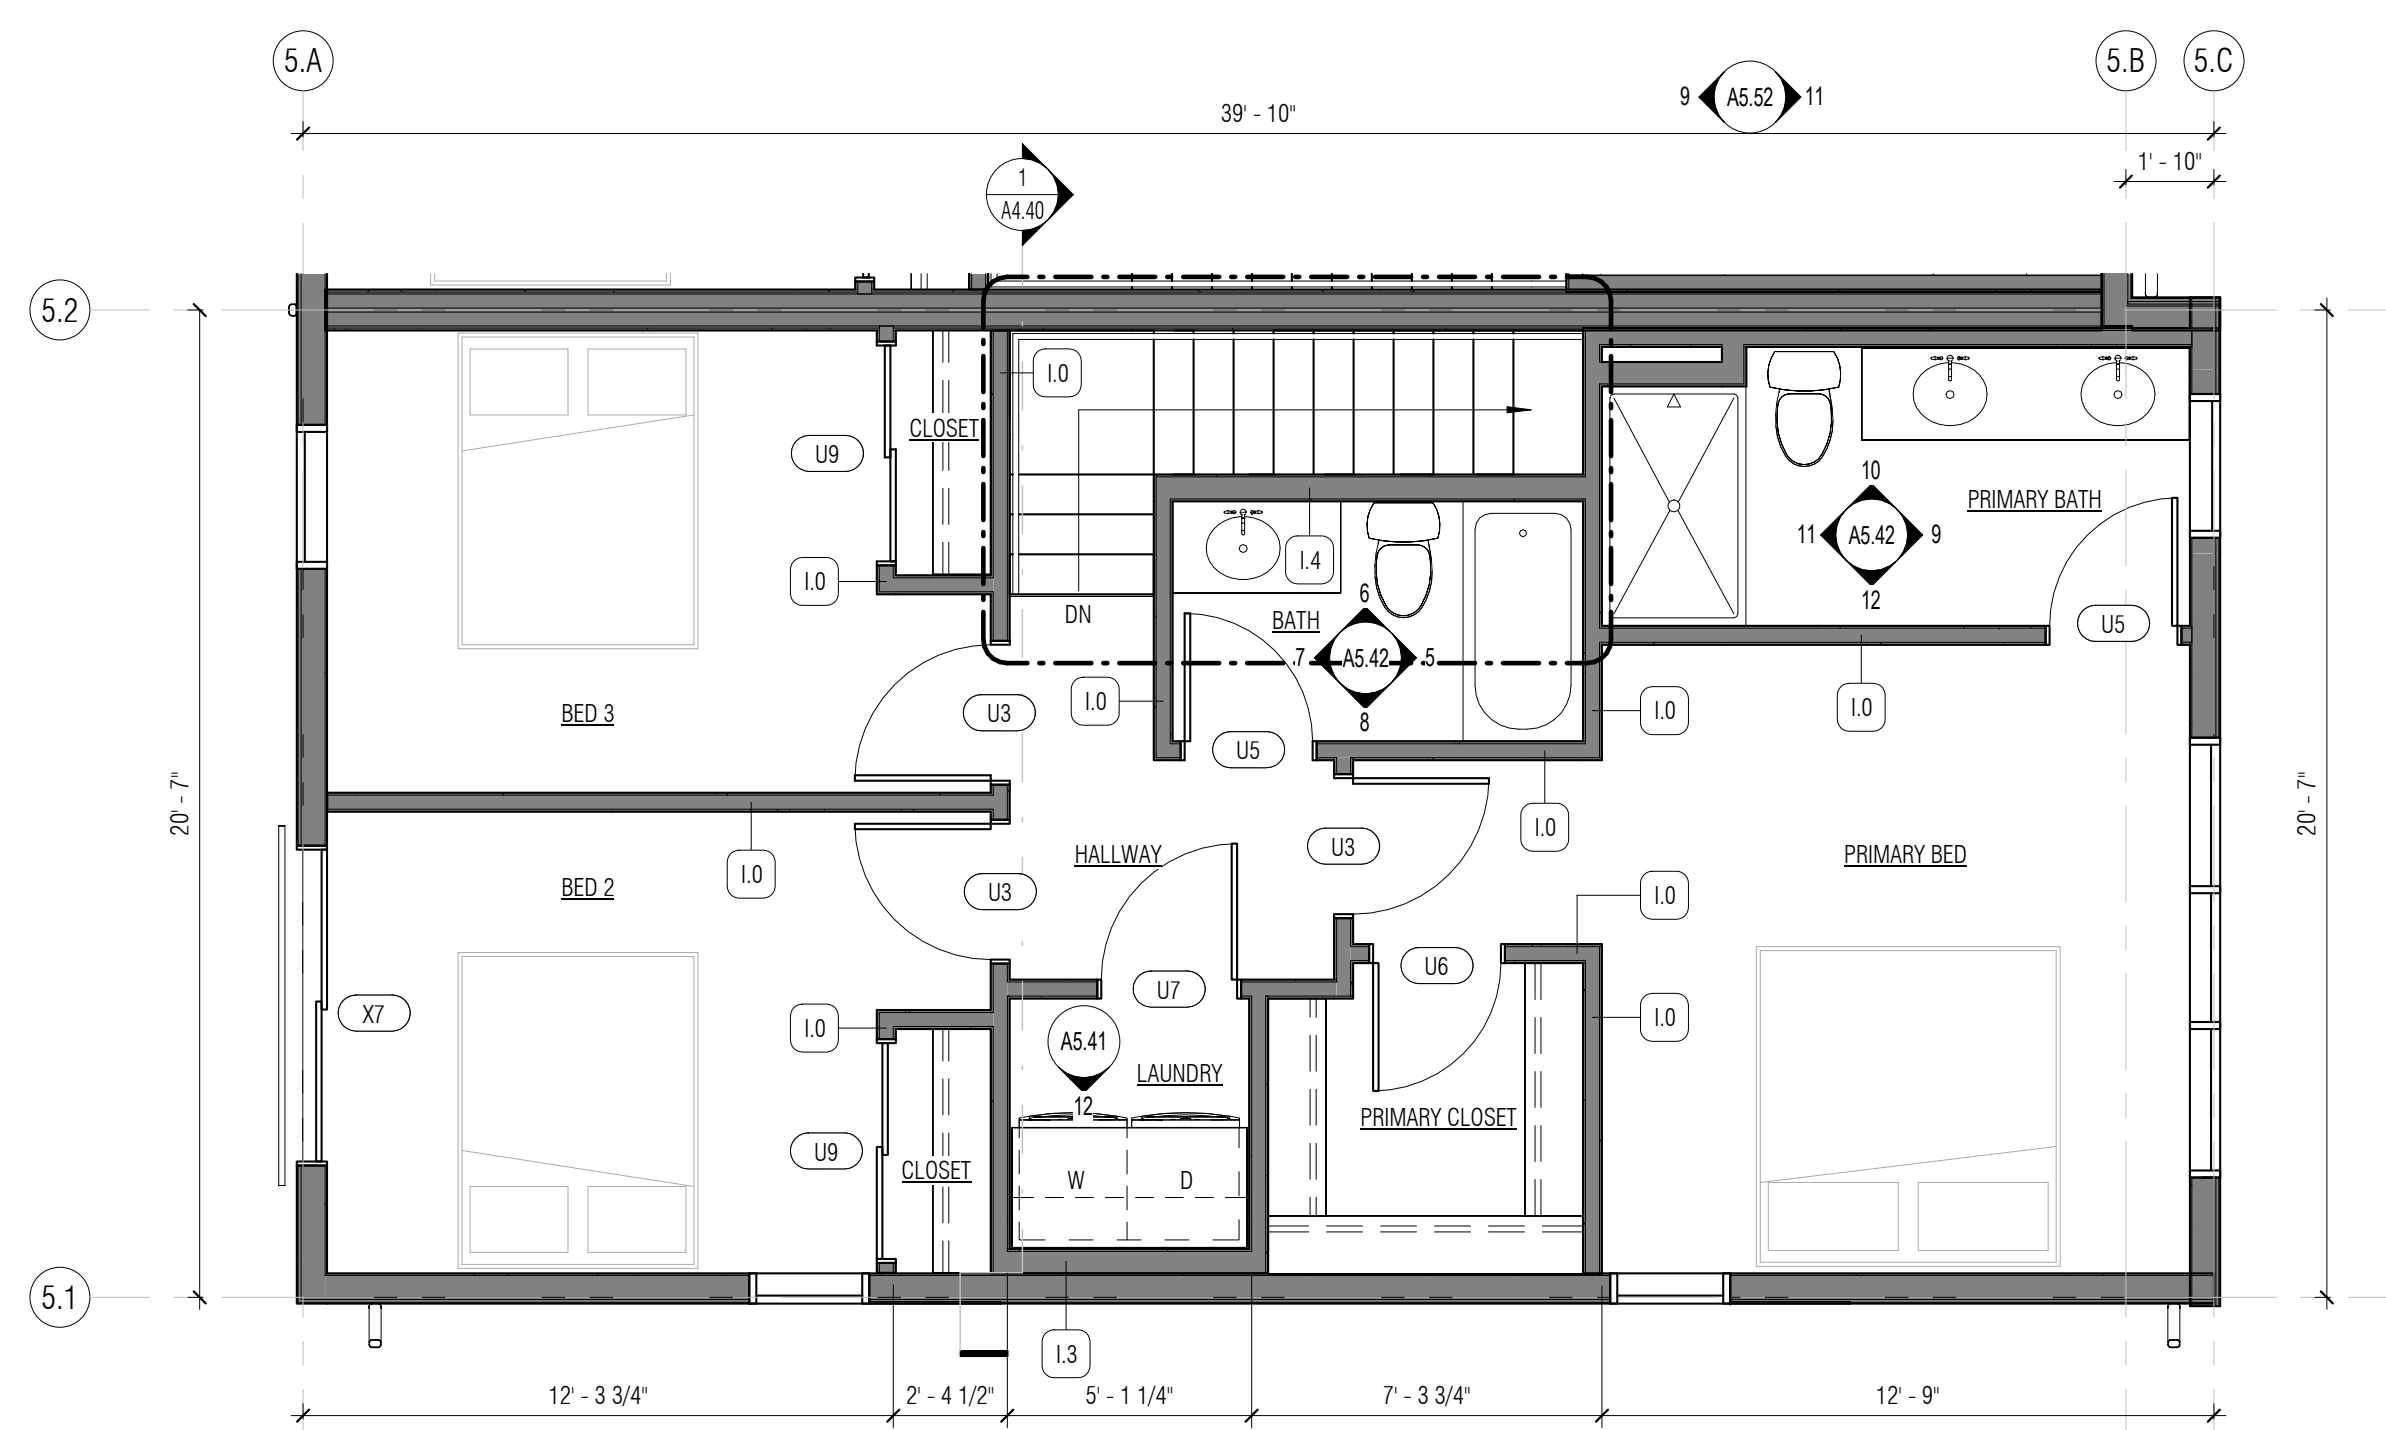


3 FLOOR PLAN - LEVEL 3
1/4" = 1'-0"

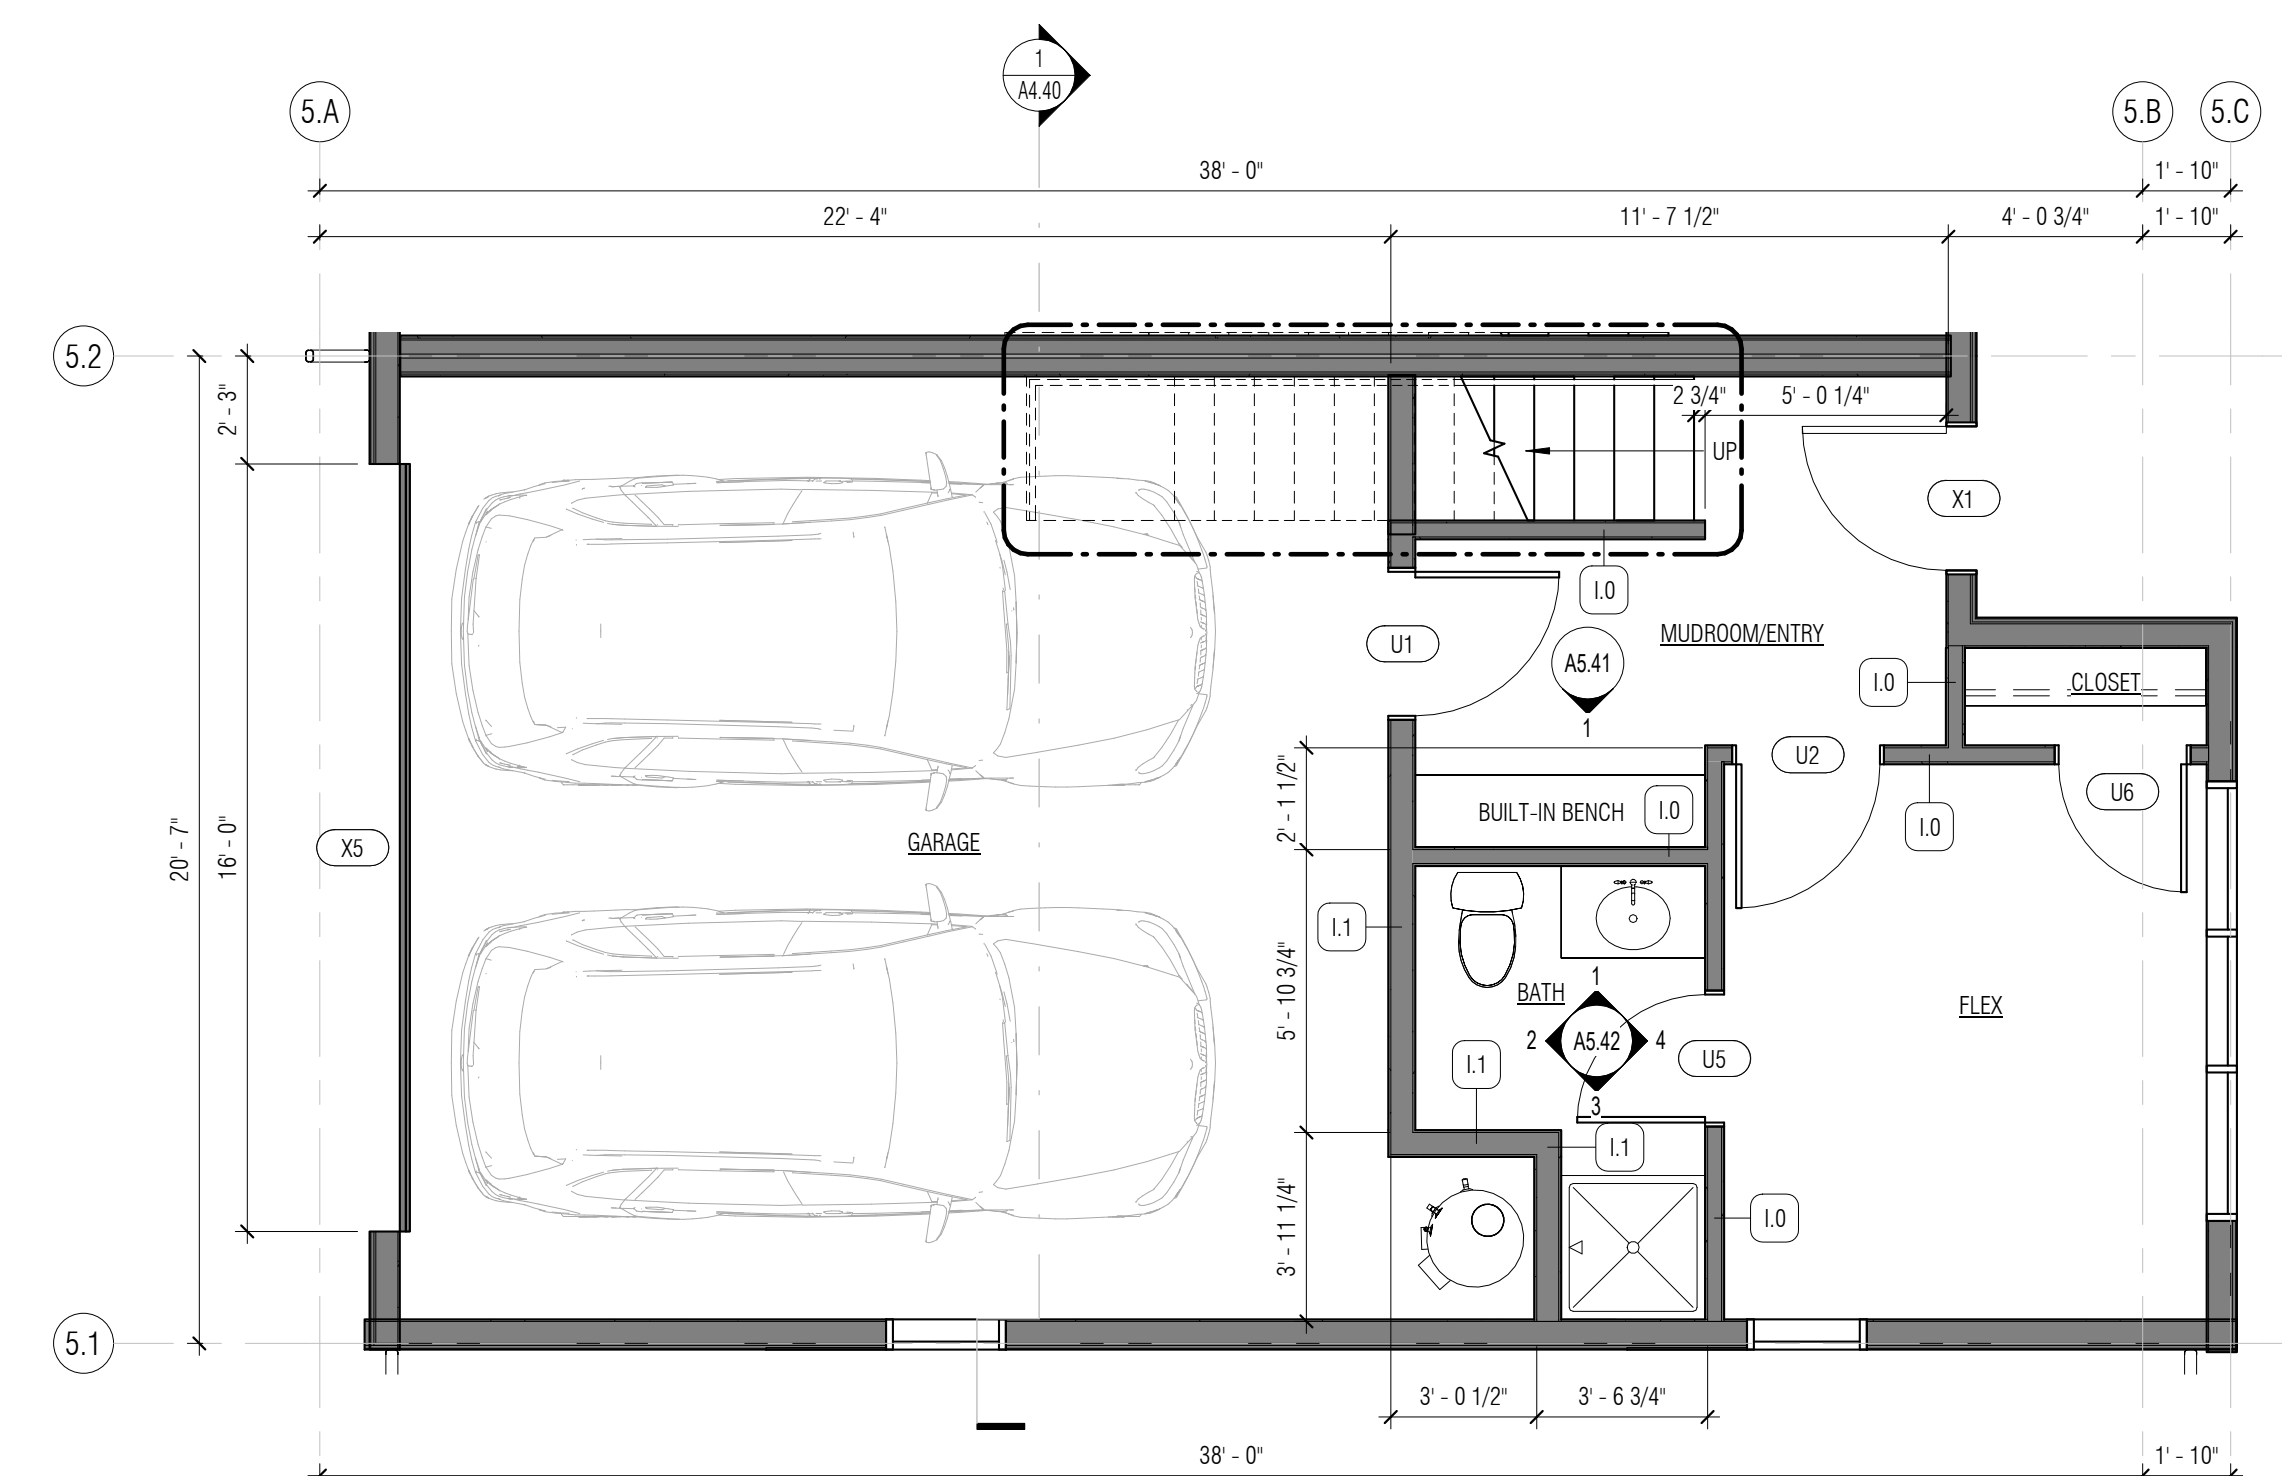


1 UNIT PLAN - LEVEL 1
1/4" = 1'-0"

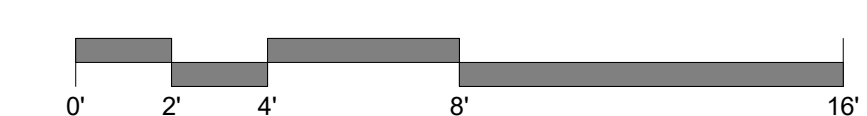

FLOOR PLAN KEY

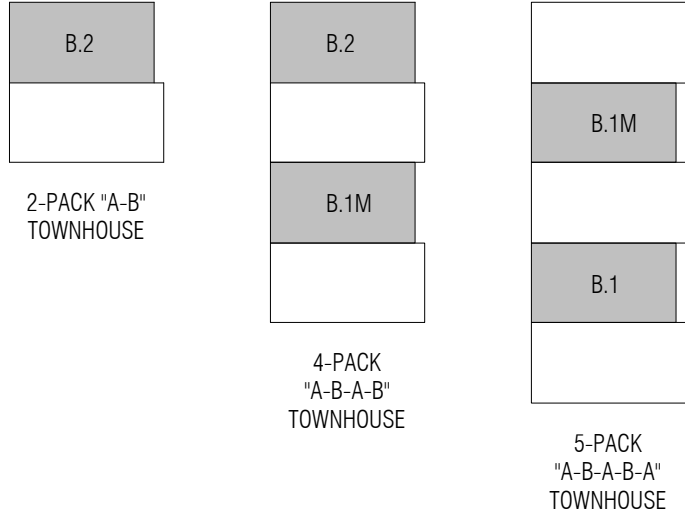


UNIT PLAN KEY

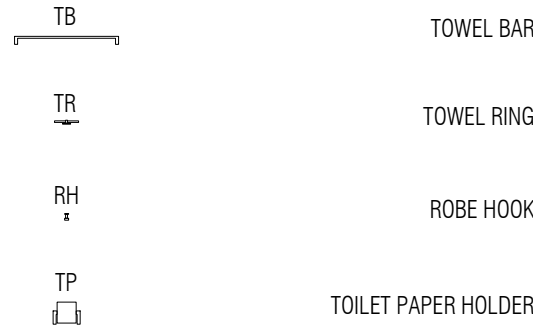


GENERAL NOTES - UNIT PLANS


- 1. ALL INTERIOR WALLS ARE I.O UNO. PROVIDE 3-1/2" SOUND INSULATION IN COMMON PARTY WALLS.
- 2. ALL EXTERIOR WALLS ARE E.I UNO.
- 3. ALL EXTERIOR DIMENSIONS ARE MEASURED FROM GRID LINE TO GRID LINE OR FACE OF FRAMING. ALL INTERIOR DIMENSIONS ARE FROM FACE OF STUD.
- 4. GRIDS ARE ALIGNED WITH THE EXTERIOR FACE OF FRAMING AT EXTERIOR WALLS AND ALIGNED WITH THE CENTER OF THE PARTY WALLS.
- 5. WINDOW DIMENSIONS ARE GIVEN AS NOMINAL MEASUREMENTS.
- 6. DOOR ROUGH OPENINGS ARE 4" OFF STUD FACE OF PERP. WALL (TO HINGED SIDE OF THE DOOR) UNO
- 7. ALL FINISH FLOOR MATERIALS TO ALIGN WITH ADJACENT FLOOR FINISH
- 8. DIMENSIONS AT POSTS ARE TO CENTERLINES UNO - VERIFY ALL STRUCTURAL LOCATIONS WITH FRAMING PLANS
- 9. SEE EXTERIOR ELEVATION SHEETS FOR WINDOW TAGS
- 10. SEE SHEETS GENERAL SHEETS CODE, DIMENSIONING AND GENERAL NOTES
- 11. SEE SHEET A7.00 SERIES FOR DOOR & WINDOW SCHEDULE
- 12. THE MAIN ELECTRICAL SERVICE OR FEEDER PANEL FOR EACH DWELLING UNIT SHALL HAVE A RESERVED SPACE TO ALLOW INSTALLATION OF A DUAL POLE CIRCUIT BREAKER FOR FUTURE SOLAR ELECTRIC INSTALLATION AND SHALL BE LABELED FOR FUTURE SOLAR ELECTRIC.
- 13. A PERMANENT CERTIFICATE, INDICATING THE BOUNDARIES AND STRUCTURAL PROVISIONS OF THE SOLAR-READY ZONE, SHALL BE POSTED NEAR THE ELECTRICAL DISTRIBUTION PANEL, WATER HEATER OF OTHER CONSPICUOUS LOCATION.

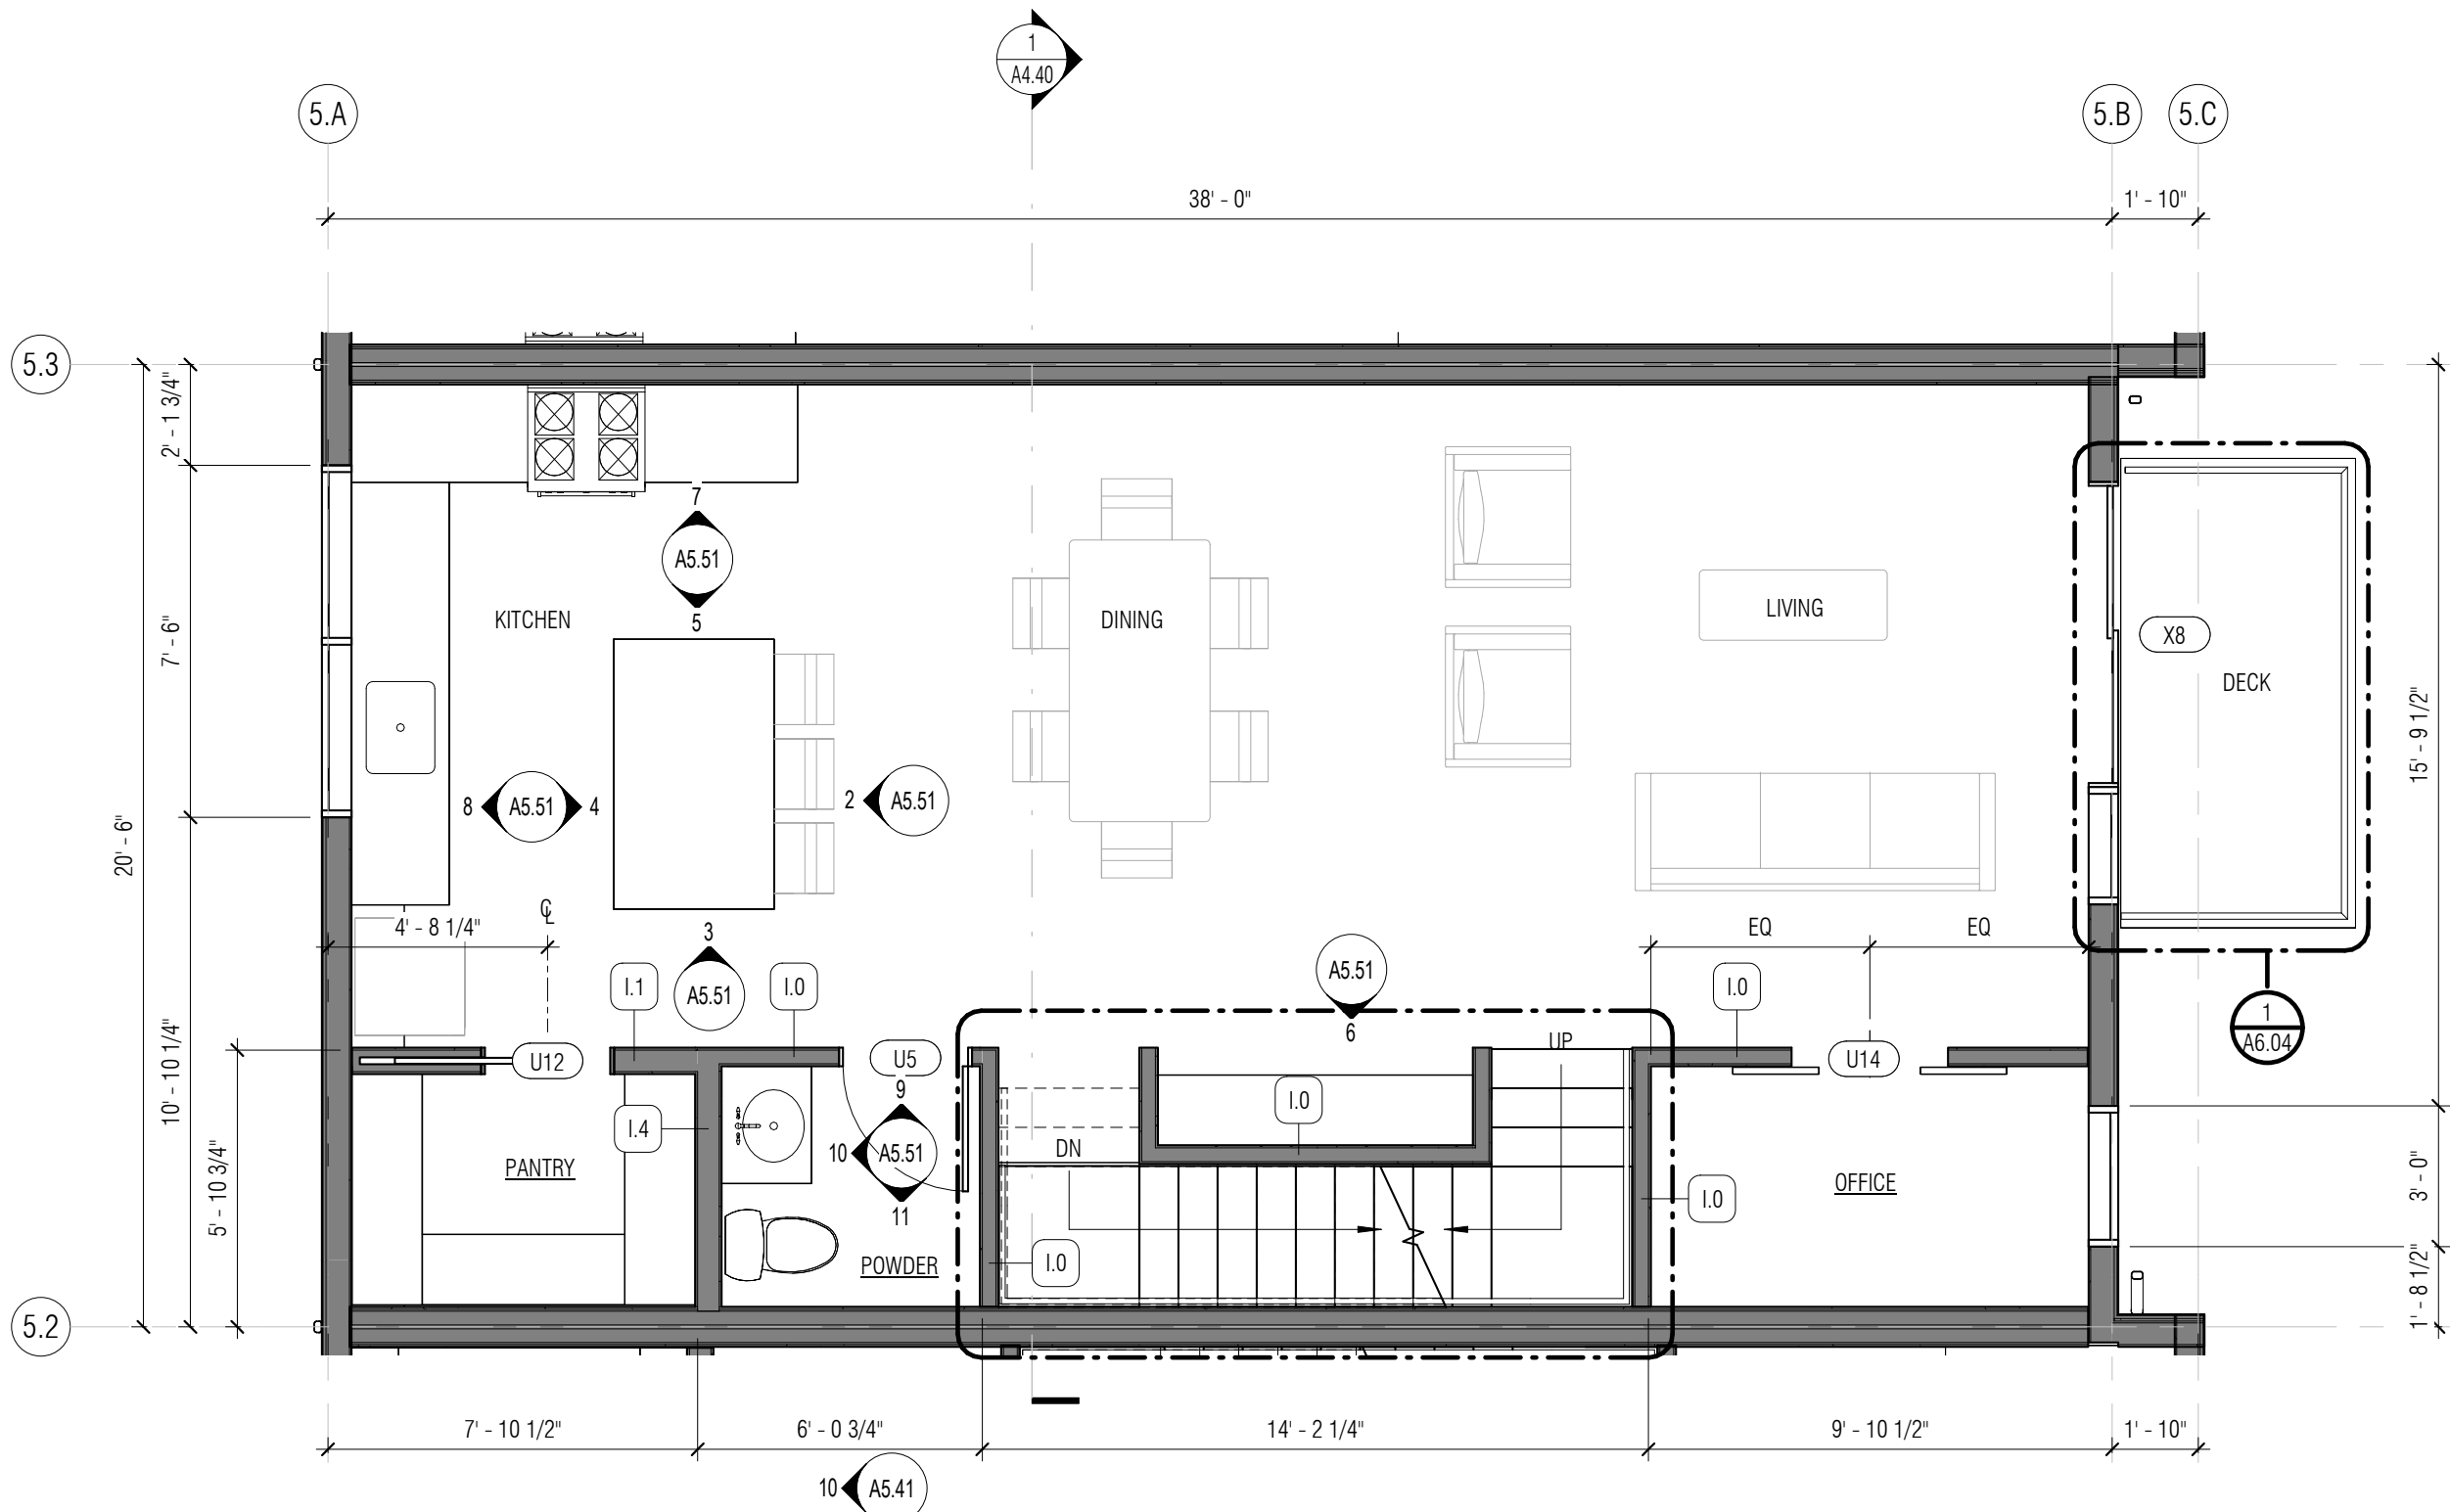


2 FLOOR PLAN - LEVEL 2
1/4" = 1'-0"

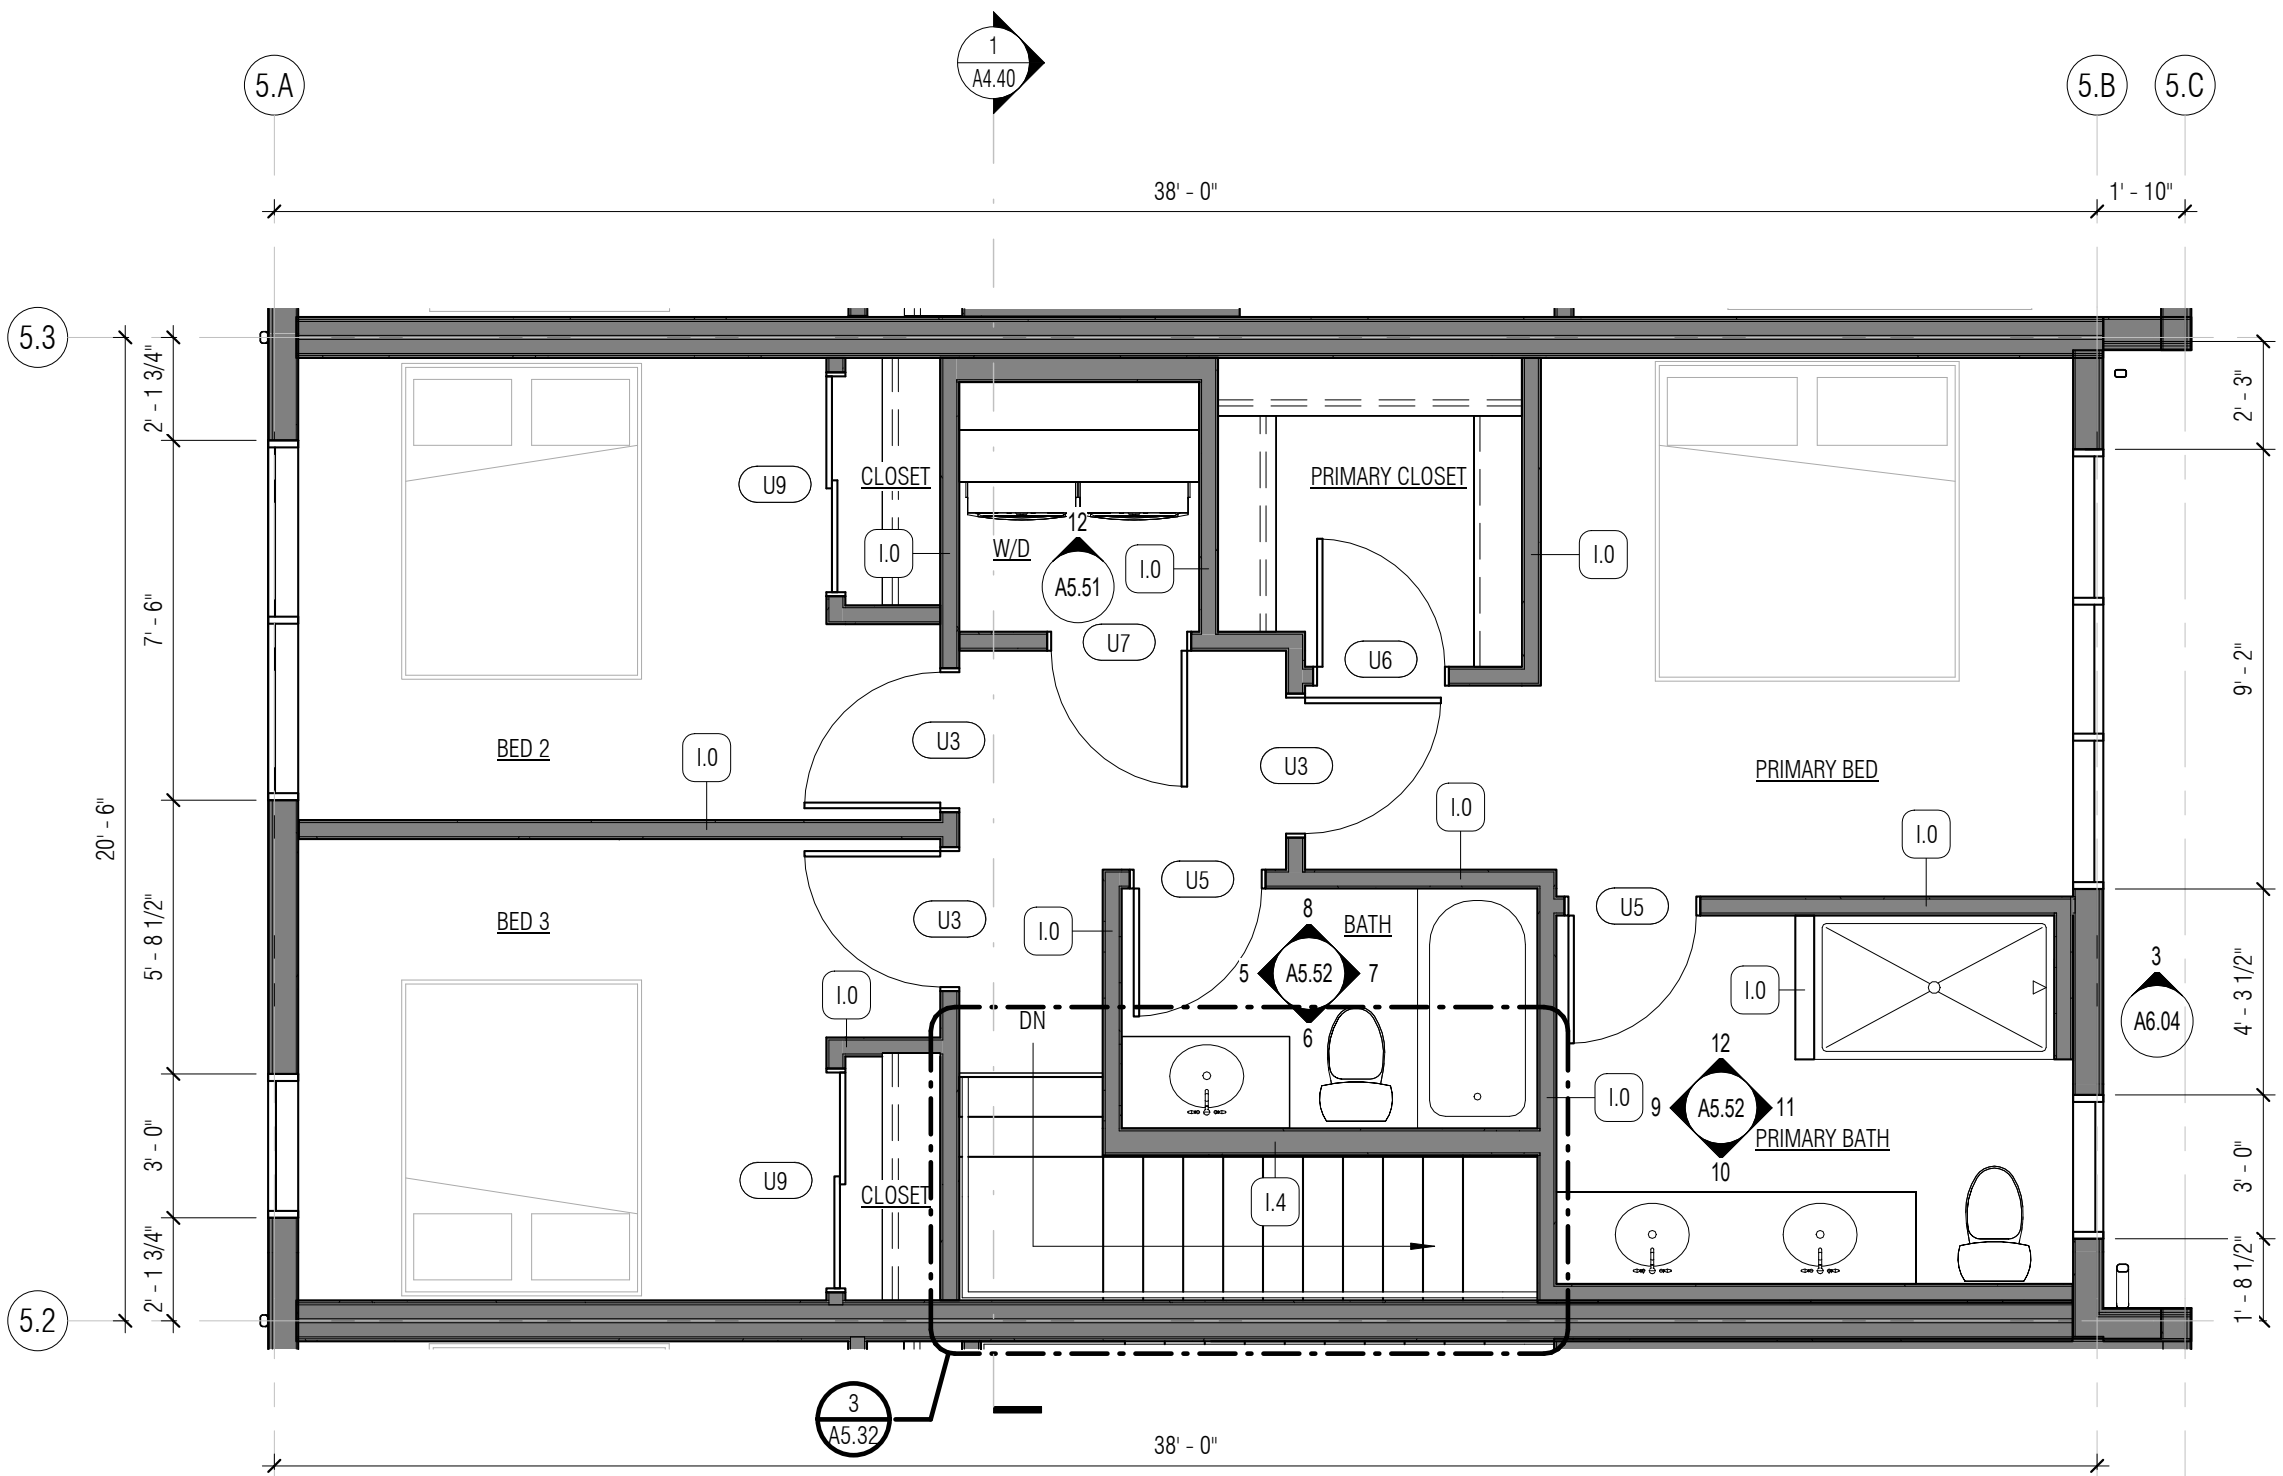

3 FLOOR PLAN - LEVEL 3
1/4" = 1'-0"

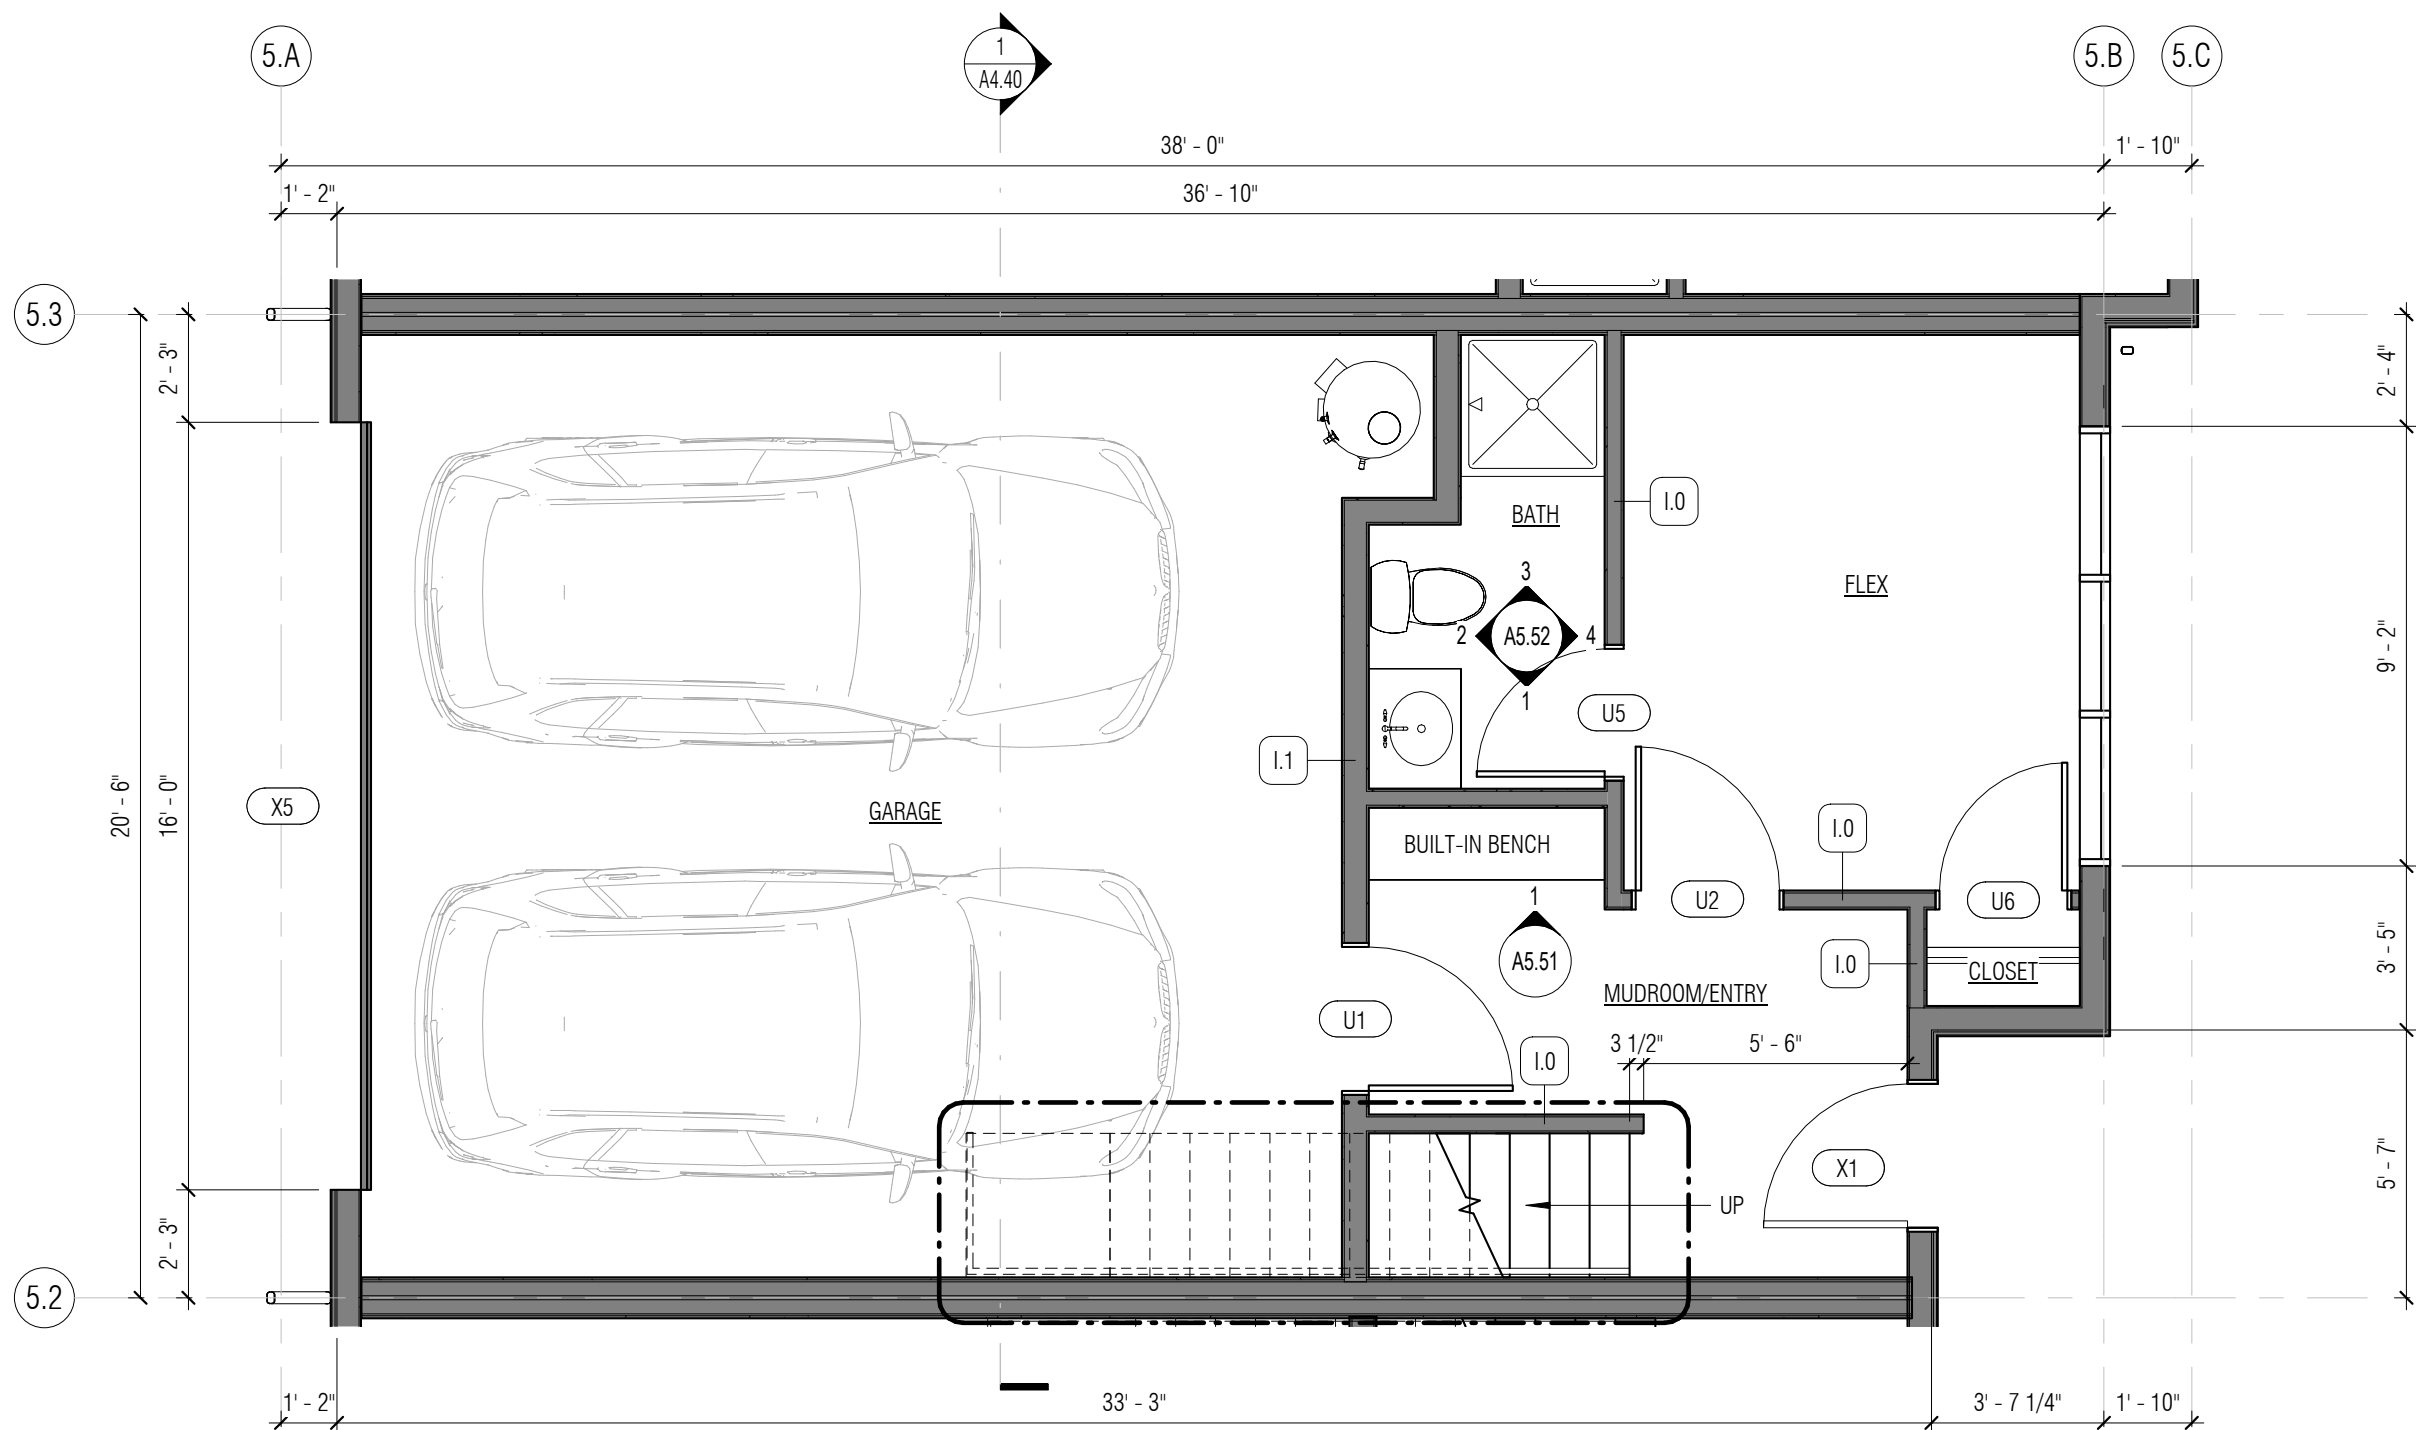

1 FLOOR PLAN - LEVEL 1
1/4" = 1'-0"

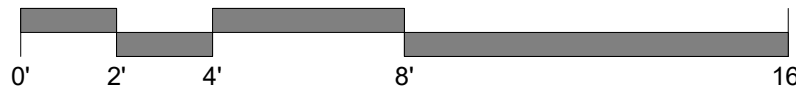

ISSUANCES

DATE	DESCRIPTION
7/29/2022	LAND USE APPLICATION
1/13/2023	LAND USE APP RESUBMITTAL
4/14/2023	LAND USE APP RESUBMITTAL


COPYRIGHT BOARD AND VELLUM, LLC. ALL RIGHTS RESERVED.
ORIGINAL SHEET SIZE IS 24"x36"

BOARD & VELLUM PROJECT #: 2021170.00
COB PROJECT #: 2021-0105

PLOT DATE: 04.12.2023


UNIT PLANS - TYPE B.1 & B.2
(B.1M OPP)

SHEET NO.:

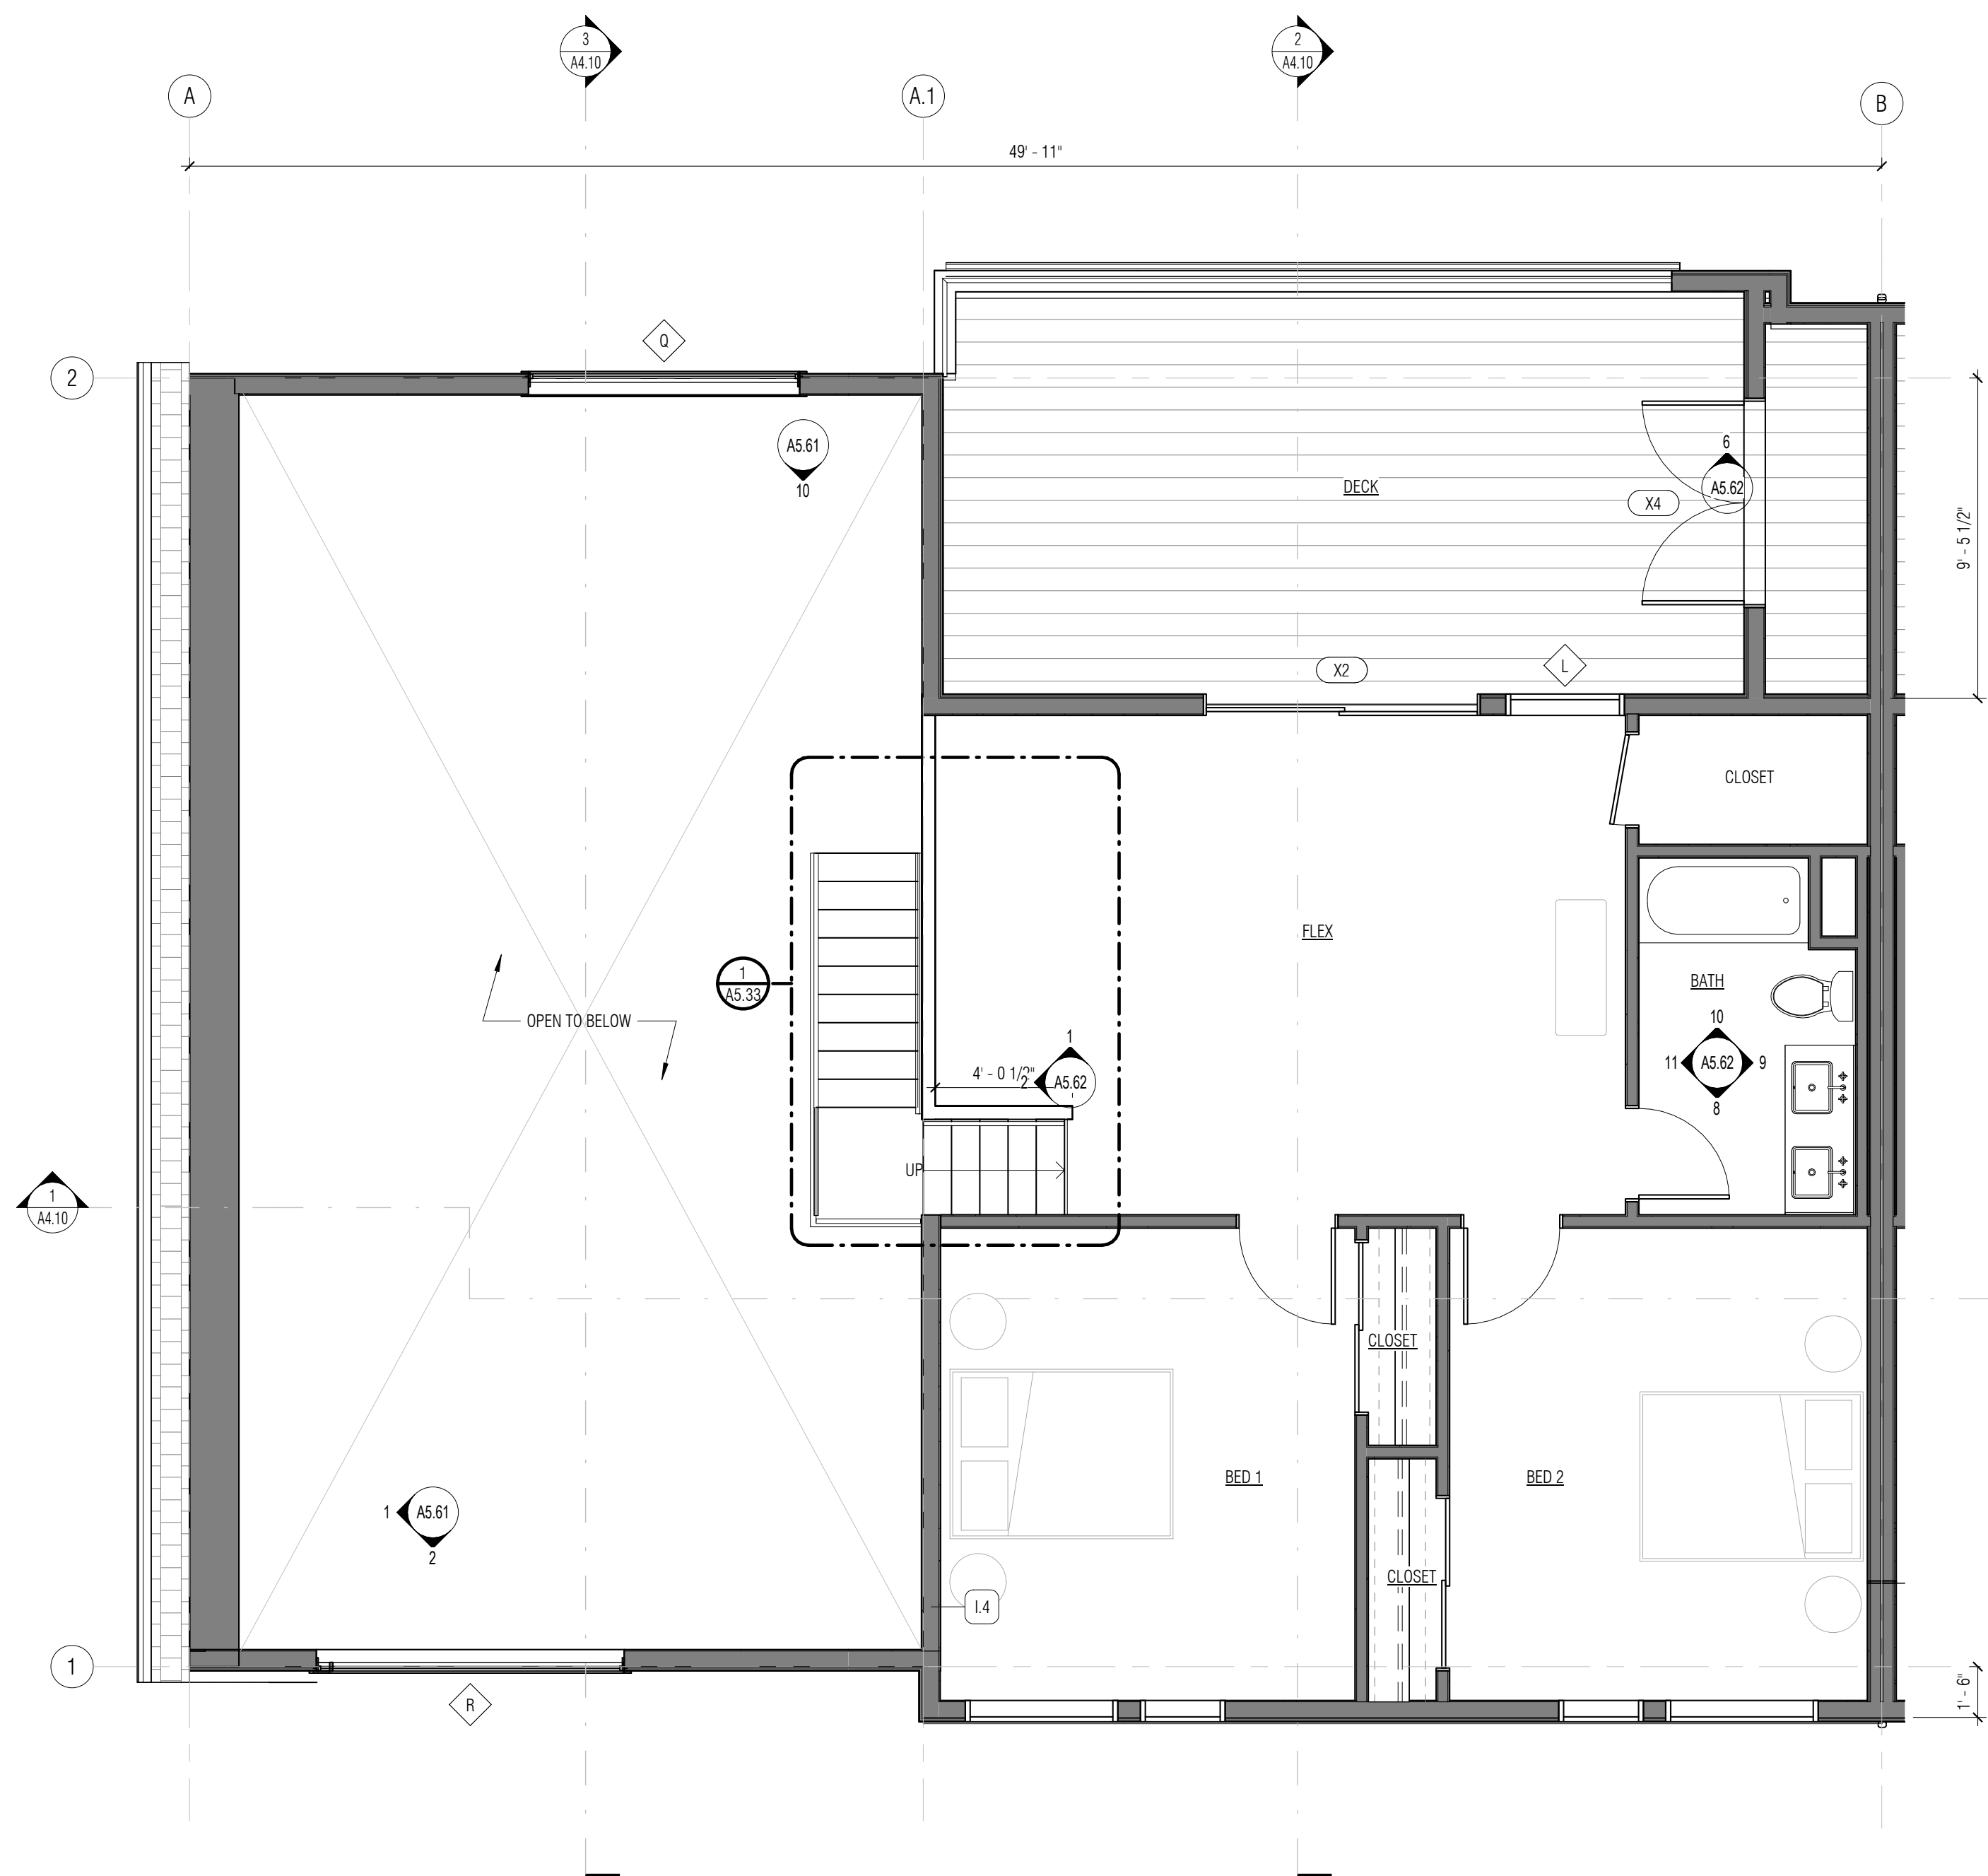

2 FLOOR PLAN - LEVEL 2
1/4" = 1'-0"

FLOOR PLAN KEY

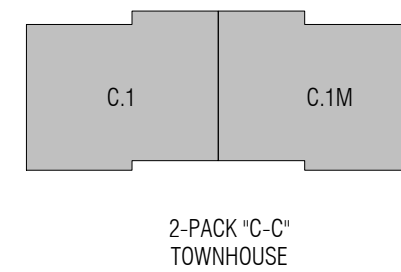

UNIT PLAN KEY




GENERAL NOTES - UNIT PLANS

- ALL INTERIOR WALLS ARE 1.0 UNO. PROVIDE 3-1/2" SOUND INSULATION IN COMMON PARTY WALLS.
- ALL EXTERIOR WALLS ARE E.1 UNO.
- ALL EXTERIOR DIMENSIONS ARE MEASURED FROM GRID LINE TO GRID LINE OR FACE OF FRAMING. ALL INTERIOR DIMENSIONS ARE FROM FACE OF STUD.
- GRIDS ARE ALIGNED WITH THE EXTERIOR FACE OF FRAMING AT EXTERIOR WALLS AND ALIGNED WITH THE CENTER OF THE PARTY-WALLS.
- WINDOW DIMENSIONS ARE GIVEN AS NOMINAL MEASUREMENTS.
- DOOR ROUGH OPENINGS ARE 4" OFF STUD FACE OF PERP. WALL (TO HINGED SIDE OF THE DOOR) UNO
- ALL FINISH FLOOR MATERIALS TO ALIGN WITH ADJACENT FLOOR FINISH
- DIMENSIONS AT POSTS ARE TO CENTERLINES UNO - VERIFY ALL STRUCTURAL LOCATIONS WITH FRAMING PLANS
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1 FLOOR PLAN - LEVEL 1
1/4" = 1'-0"



INFILL TOOLKIT LONG PLAT

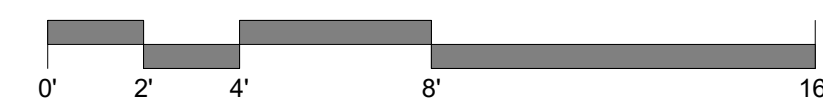

FREELAND
ASSOCIATES



Map showing the location of the Project Site in North St. Louis. The site is located south of McLeod Rd and west of Meridian St, near the intersection of Northwest Ave and Birchwood Ave. The map includes labels for Interstate 5, Baker St, W Orchard Dr, and a north arrow.

- C1 COVER SHEET**
- C1.1 EXISTING CONDITIONS - SOUTH**
- C1.2 EXISTING CONDITIONS - NORTH**
- C2.1 SITE PLAN - SOUTH**
- C2.2 SITE PLAN - NORTH**
- C2.3 NORTH FRONTAGE IMPROVEMENTS**
- C3.1 GRADING & DRAINAGE PLAN - SOUTH**
- C3.2 GRADING & DRAINAGE PLAN - NORTH**
- C4.1 UTILITY PLAN - SOUTH**
- C4.2 UTILITY PLAN - NORTH**
- C5.1 PLAT MAP - SOUTH**
- C5.2 PLAT MAP - NORTH**
- C6.1 TREE & UTILITY PLAN - SOUTH**
- C6.2 TREE & UTILITY PLAN - NORTH**

KIM ROONEY LANDSCAPE ARCHITECTURE
KIM ROONEY
2307 VIEWMONT WY W
SEATTLE, WA 98199
(206) 920-1323
kim@kimrooneyinc.com

	= FOUND BRASS MON		= GP		= EXISTING OVERHEAD ELECTRIC LINES
	= FOUND ALUMINUM CAP MON		= FQ		= EXISTING FIBER OPTIC LINE
	= FOUND CONC MON		= P		= EXISTING UNDERGROUND POWER
	= FOUND SQUARE CONC MON		= OT		= EXISTING OVERHEAD PHONE
	= FOUND REBAR AND CAP		= T		= EXISTING UNDERGROUND PHONE
	= SET 1/2" REBAR W/ PLASTIC CAP		= OH		= EXISTING OVERHEAD UTILITIES (UNKNOWN)
	= FOUND IRON PIPE		= TV		= EXISTING UNDERGROUND TV CABLE
	= FOUND HUB AND TACK		= G		= EXISTING GAS MAIN
	= FOUND PK NAIL		= G		= PROPOSED GAS LINE
	= FOUND PK NAIL AND TAG/SHINER		= W		= EXISTING WATER LINE
	= FOUND RR SPIKE		= FIRE		= EXISTING FIRE MAIN
	= EXISTING STORM DRAIN CATCH BASIN (TYPE 1)		= W		= PROPOSED WATER LINE
	= EXISTING STORM DRAIN CATCH BASIN (TYPE 2)		= IRG		= PROPOSED IRRIGATION LINE
	= EXISTING STORM DRAIN MANHOLE (TYPE 2) (SOLID LID)		= S		= EXISTING SANITARY SEWER LINE
	= EXISTING STORM DRAIN AREA DRAIN		= SPM		= EXISTING SEWER FORCE MAIN
	= EXISTING STORM DRAIN CLEANOUT		= SS		= PROPOSED SANITARY SEWER LINE
	= EXISTING STORM DRAIN SERVICE		= SPM		= PROPOSED SANITARY SEWER FORCE LINE
	= PROPOSED RAINLAD/DOWNSPOUT		= D		= EXISTING FLOW LINE & DIRECTION
	= PROPOSED AREA DRAIN		= SD		= EXISTING STORM DRAIN LINE
	= PROPOSED STORM DRAIN SERVICE		= SD		= PROPOSED STORM DRAIN LINE (SOLID WALL)
	= PROPOSED STORM DRAIN CLEANOUT		=		= PROPOSED STORM DRAIN LINE (PERFORATED)
	= PROPOSED STORM DRAIN CATCH BASIN		=		= PROPOSED FOUNDATION DRAIN
	= PROPOSED STORM DRAIN MANHOLE (TYPE 2)		=		= PROPOSED ROOF DRAIN
	= EXISTING SANITARY SEWER MANHOLE		=		= EXISTING CHAIN LINK FENCE
	= EXISTING SANITARY SEWER CLEANOUT		=		= PROPOSED CHAIN LINK FENCE
	= EXISTING SANITARY SEWER SERVICE		=		= EXISTING BARBED WIRE FENCE
	= PROPOSED SANITARY SEWER SERVICE		=		= PROPOSED BARBED WIRE FENCE
	= PROPOSED SEWER CLEANOUT		=		= EXISTING FENCE TYPE:
	= PROPOSED SEWER MANHOLE		=		= EXISTING FENCE TYPE:
	= EXISTING WATER SERVICE CONNECT		=		= EXISTING CONC. FENCE OR RET. WALL
	= EXISTING FIRE STAND PIPE		=		= EXISTING STONE WALL
	= EXISTING WATER BLOW-OFF VALVE		=		= EXISTING ORDINARY HIGH WATER LINE
	= EXISTING WATER METER BOX		=		= EXISTING TOP OF BANK
	= EXISTING FIRE HYDRANT		=		= EXISTING TOE OF BANK
	= EXISTING WATER VALVE		=		= PROPOSED TOP OF BANK
	= EXISTING WATER VALVE BOXES		=		= PROPOSED TOE OF BANK
	= PROPOSED WATER SERVICE CONNECT		=		= EXISTING CONTOUR (INDEX)
	= PROPOSED WATER METER BOX		=		= EXISTING CONTOUR (NORMAL)
	= PROPOSED WATER VALVE		=		= PROPOSED CONTOUR (INDEX)
	= PROPOSED WATER BLOW-OFF		=		= PROPOSED CONTOUR (NORMAL)
	= PROPOSED FIRE HYDRANT		=		= PROPOSED DAYLIGHT FILL LINE
	= PROPOSED FIRE DEPARTMENT CONNECTION		=		= PROPOSED DAYLIGHT CUT LINE
	= PROPOSED POST INDICATOR VALVE		=		= EXISTING SPOT ELEV @ TOP OF PAVEMENT
	= PROPOSED WATER BEND				

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**STREAM BELLINGHAM
TOWNHOMES**
3729 MERIDIAN ST
BELLINGHAM, WA 98225

LOCATION

DRAWING
21185SP7

DESIGNED

COVER SHEET

CONTENTS:



DB #:	DATE:
21185	4-15-2023

SHEET: _____

C1

1. DATA FOR THIS SURVEY WAS GATHERED BY FIELD TRAVERSE UTILIZING ELECTRONIC DATA COLLECTION IN APRIL, MAY, & OCTOBER, 2021.
2. EQUIPMENT USED: LEICA MS60: 00'01" \pm MM, \pm 1.5 PPM.
3. RELATIVE ACCURACY AND FIELD TRAVERSE CLOSURE EXCEEDS THE REQUIREMENTS OF WAC 332-130-085 AND WAC 332-130-090.
4. HORIZONTAL DATUM: NAD 83/98 AS PER CITY OF BELLINGHAM MONUMENTS
VERTICAL DATUM: NAVD 88 CITY BENCHMARK #5835
5. PURPOSE OF SURVEY: TOPOGRAPHIC AS-BUILT SURVEY.
6. CONTOUR INTERVALS ARE 1 FOOT AND ARE COMPUTER GENERATED FROM GROUND FIELD TOPOGRAPHY GATHERED FOR THIS SURVEY UTILIZING ELECTRONIC DATA COLLECTION.
7. ELEVATION ACCURACY OF SURVEYED POINTS AND DIGITAL TERRAIN MODELS EXCEEDS THE STANDARDS PUT FORTH BY THE US ARMY CORPS OF ENGINEERS FOR CONSTRUCTION LAYOUT: 0.10 FEET IN ELEVATION MULTIPLIED BY THE DISTANCE FROM BENCHMARK TRAVELED IN MILES, SQUARE-ROOTED, AND FOR WELL-DEFINED POINTS IN THE DIGITAL TERRAIN MODEL, PLUS OR MINUS HALF THE CONTOUR INTERVAL (0.5 FEET).

PER CHICAGO TITLE COMPANY ORDER NO. 245444100

BEGINNING AT A POINT ON THE SOUTH LINE OF THE MCLEOD ROAD, 1242 FEET EAST OF THE POINT OF INTERSECTION OF SAID SOUTH LINE WITH THE NORTHEASTERLY LINE OF THE NORTHWEST DIAGONAL ROAD IN SECTION 13, TOWNSHIP 38 NORTH, RANGE 2 EAST OF WILLAMETTE MERIDIAN; THENCE SOUTH 200 FEET; THENCE WEST 440 FEET; THENCE SOUTH 740 FEET; THENCE EAST 100 FEET; THENCE SOUTH 400 FEET; THENCE EAST 300 FEET; THENCE SOUTH 320 FEET; THENCE EAST 40 FEET; THENCE SOUTH 236.59 FEET; THENCE SOUTH 63°25' WEST 280.15 FEET TO THE NORTHEASTERLY LINE OF THE NORTHWEST DIAGONAL ROAD; THENCE SOUTH 28°07' EAST ALONG THE NORTHEASTERLY LINE OF SAID ROAD 80 FEET; THENCE SOUTH 63°25' EAST 240.8 FEET; THENCE SOUTH 28°35' EAST 597.1 FEET; THENCE NORTH 63°16' EAST 458.2 FEET; THENCE NORTH 53°48' EAST 304.14 FEET; THENCE 63°16' EAST, 500 FEET; THENCE SOUTH 57°03' EAST, 151.03 FEET TO BEGINNING OF CURVE; THENCE CURVING TO THE RIGHT 169.92 FEET RADIUS 480 FEET, ABOUT A CENTER LOCATED SOUTH 26°44' EAST AND 480 FEET DISTANT FROM THE BEGINNING OF CURVE; THENCE COMPOUNDING CURVING TO THE RIGHT 386.49 FEET, RADIUS 721.17 FEET, ABOUT A CENTER LOCATED 6°27' EAST AND 721.7 FEET DISTANT FROM THE POINT OF COMPOUND CURVE; THENCE SOUTH 65°46' EAST 63.3 FEET; THENCE TANGENTIALLY CURVING TO THE LEFT, RADIUS 488 FEET, A DISTANCE OF 727.27 FEET TO A POINT ON THE NORTHEASTERLY LINE OF THE MCLEOD ROAD; THENCE SOUTHWESTERLY AT RIGHT ANGLES FROM THE CENTER LINE OF THE BELLINGHAM AND NORTHERN RAILROAD;

THENCE NORTH 60°53' EAST 271.25 FEET TO THE WEST LINE OF THE GUIDE MERIDIAN ROAD, ALONG A LINE PARALLEL TO THE RAILROAD LINE AND 120 FEET DISTANT AND NORTHEASTERLY THEREFROM; THENCE NORTH 01° EAST ALONG THE WESTERLY LINE OF THE GUIDE MERIDIAN ROAD 193.82 FEET TO THE SOUTH LINE OF THE MCLEOD ROAD; THENCE WEST ALONG THE SOUTH LINE OF THE MCLEOD ROAD, 2594.2 FEET TO THE POINT OF BEGINNING. IN THIS DESCRIPTION, THE MCLEOD ROAD IS ASSUMED TO BE AN EAST AND WEST LINE AND NORTH AND SOUTH TO BE EXACTLY AT RIGHT ANGLES TO SAID MCLEOD ROAD;



EXCEPTING FROM THE ABOVE, THAT PORTION AS CONVEYED TO THE STATE OF WASHINGTON BY DEED
RECORDED MAY
17, 1957, UNDER RECORDING NO.: 837020;

ALSO EXCEPT THAT PORTION CONVEYED TO THE CITY OF BELLINGHAM, BY DEED RECORDED JUNE 19, 1970,
UNDER
RECORDING NO.: 1076506;

ALSO EXCEPT THAT PORTION CONVEYED TO CHARLES E. ZORNES AND RUTH D. ZORNES, RECORDED
NOVEMBER 6,
1980, UNDER RECORDING NO.: 1372558, TO ESTABLISH PROPERTY LINES;

AND EXCEPT THAT PORTION CONVEYED TO THE CITY OF BELLINGHAM BY DEED RECORDED APRIL 28, 1987,
UNDER
RECORDING NO.: 1570689, RECORDS OF WHATCOM COUNTY, WASHINGTON.

SITUATE IN WHATCOM COUNTY, WASHINGTON.

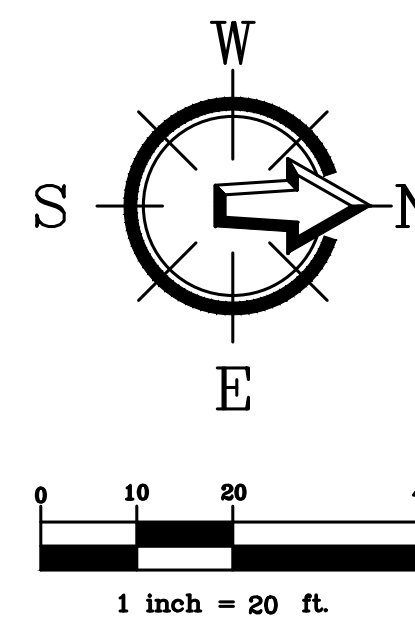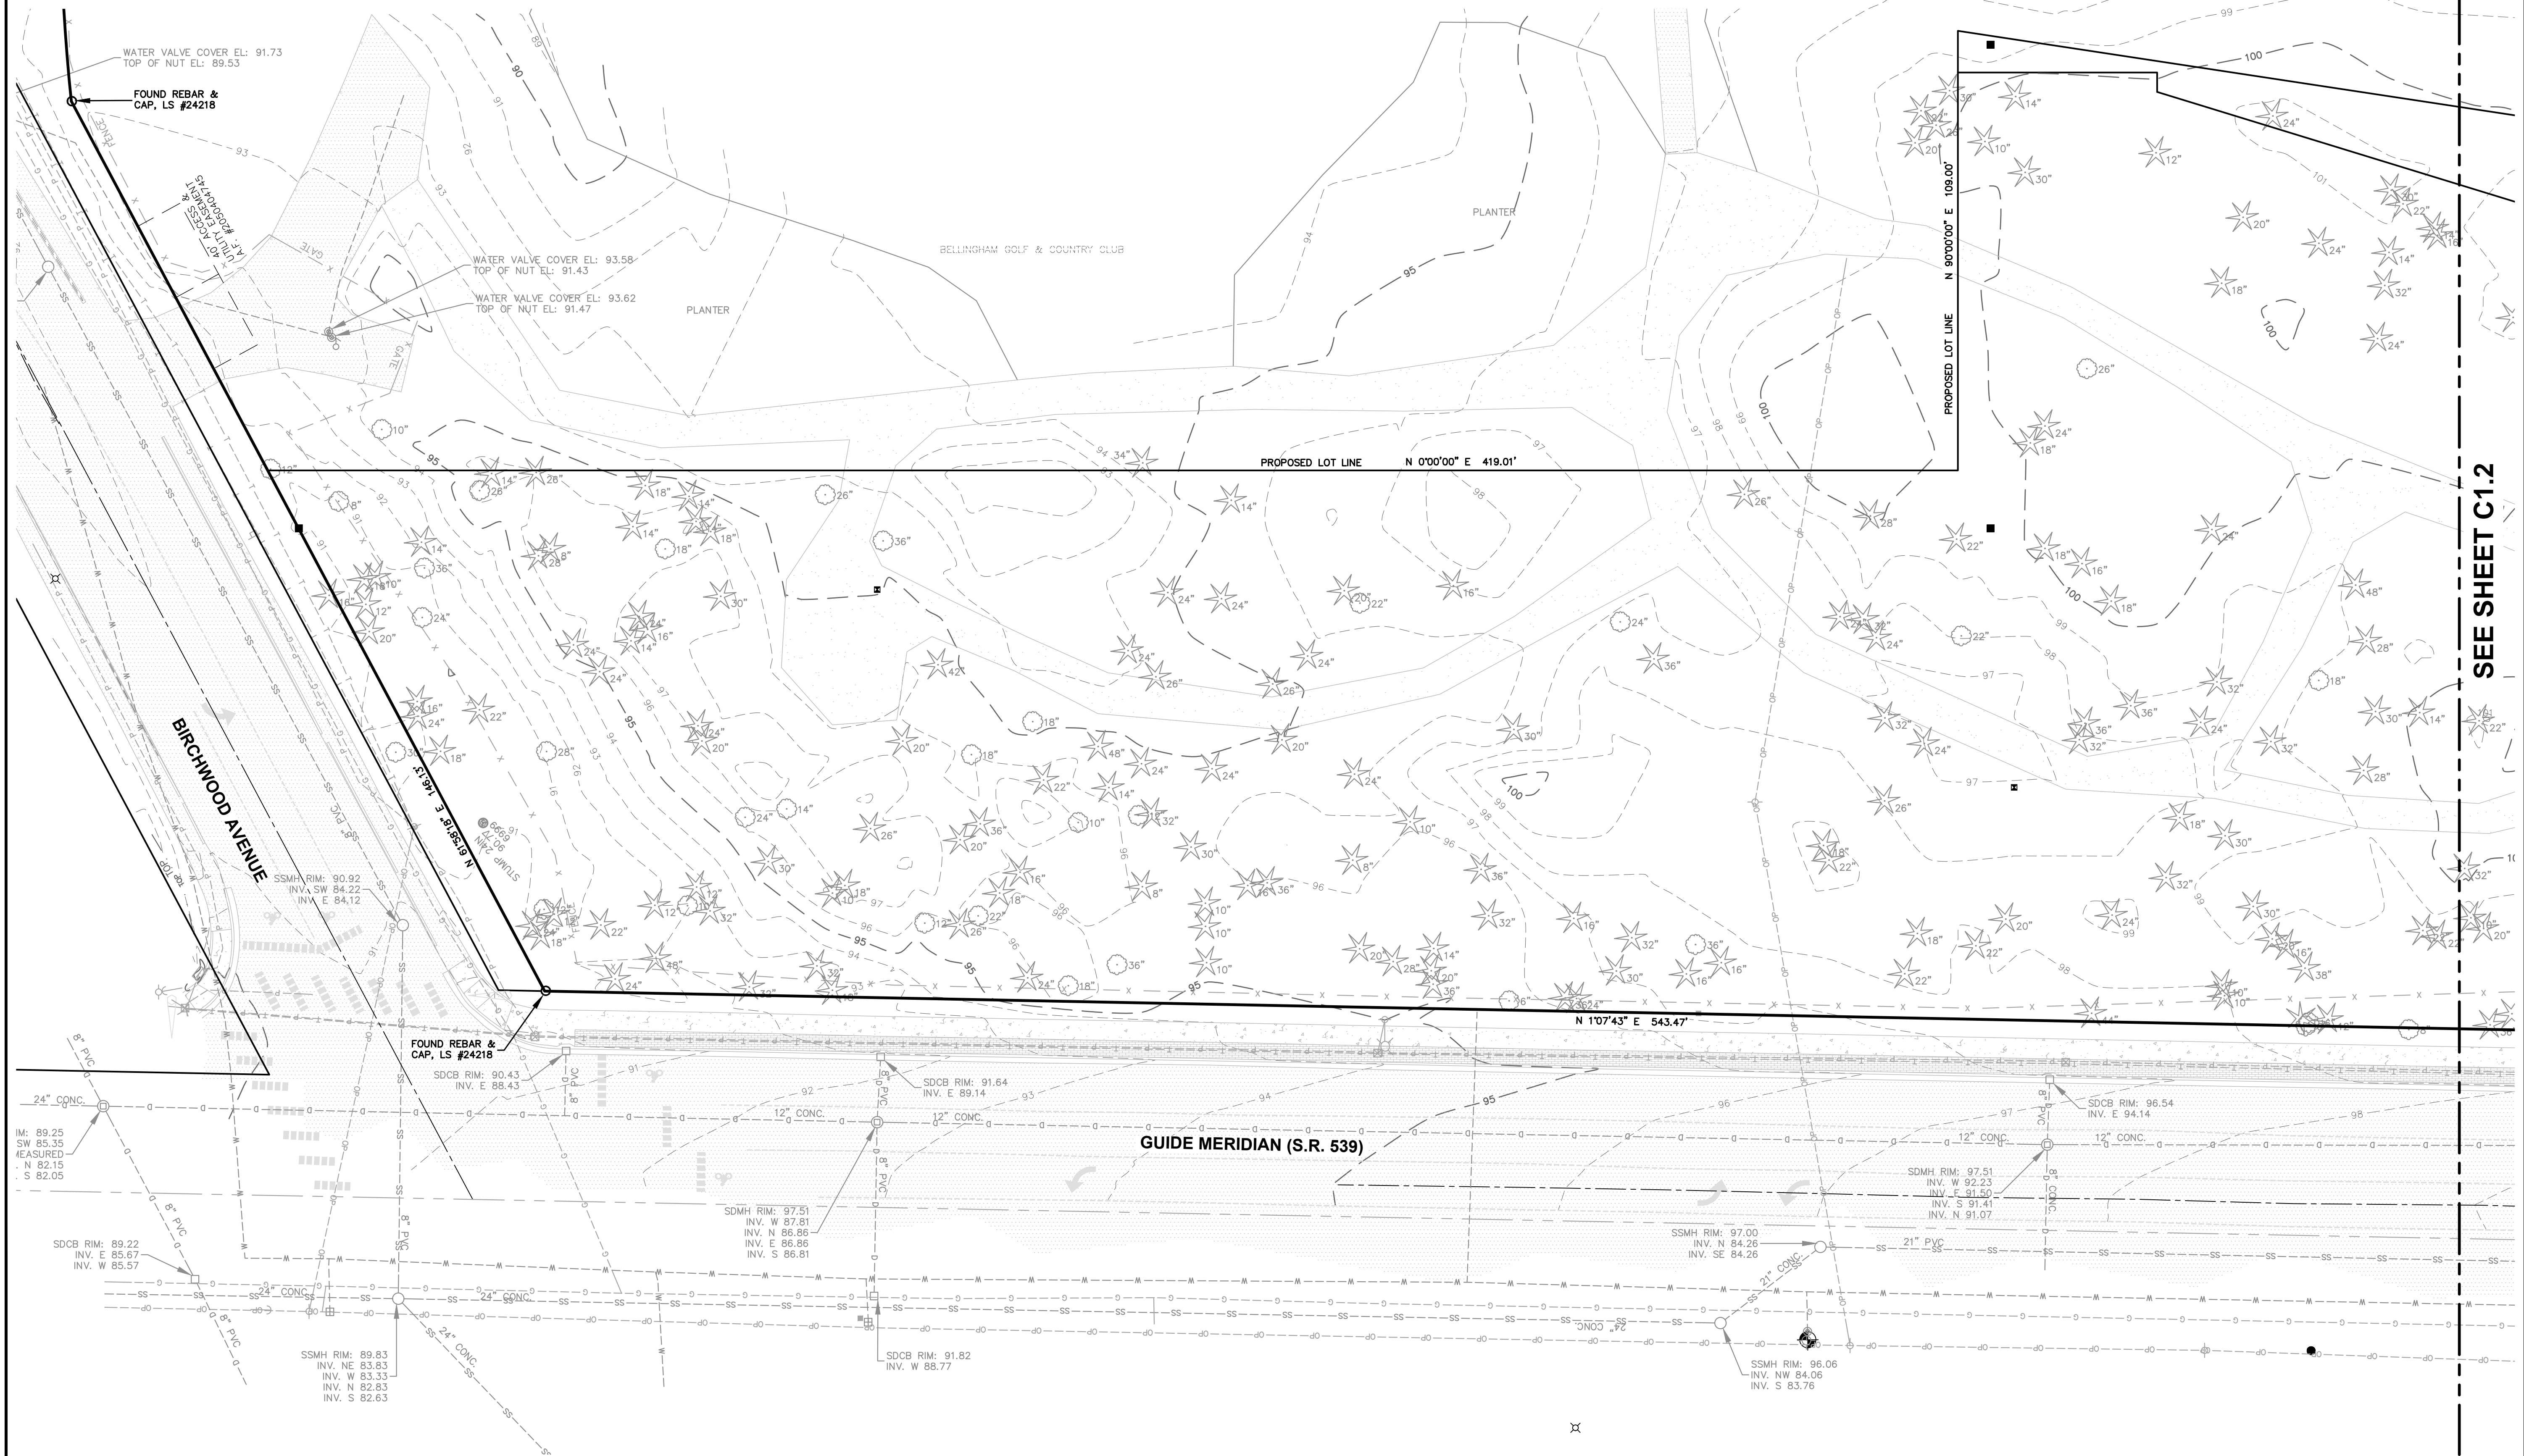

220 West Champion Street, Suite 200 t: 360.650.1400
Bellingham, WA 98225 f: 360.650.1401

F R E E L A N D
& A S S O C I A T E S

[illegible]

CLIENT:
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999 N NORTHLAKE WAY SUITE 200

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STREAM BELLINGHAM TOWNHOMES


DRAWING #:	DRAWN BY:
21185SP7.DWG	NSP
DESIGNED BY:	CHECKED BY:

EXISTING CONDITIONS SOUTH



JOB #: 21185	DATE: 4-15-2023
-----------------	--------------------

C1.1

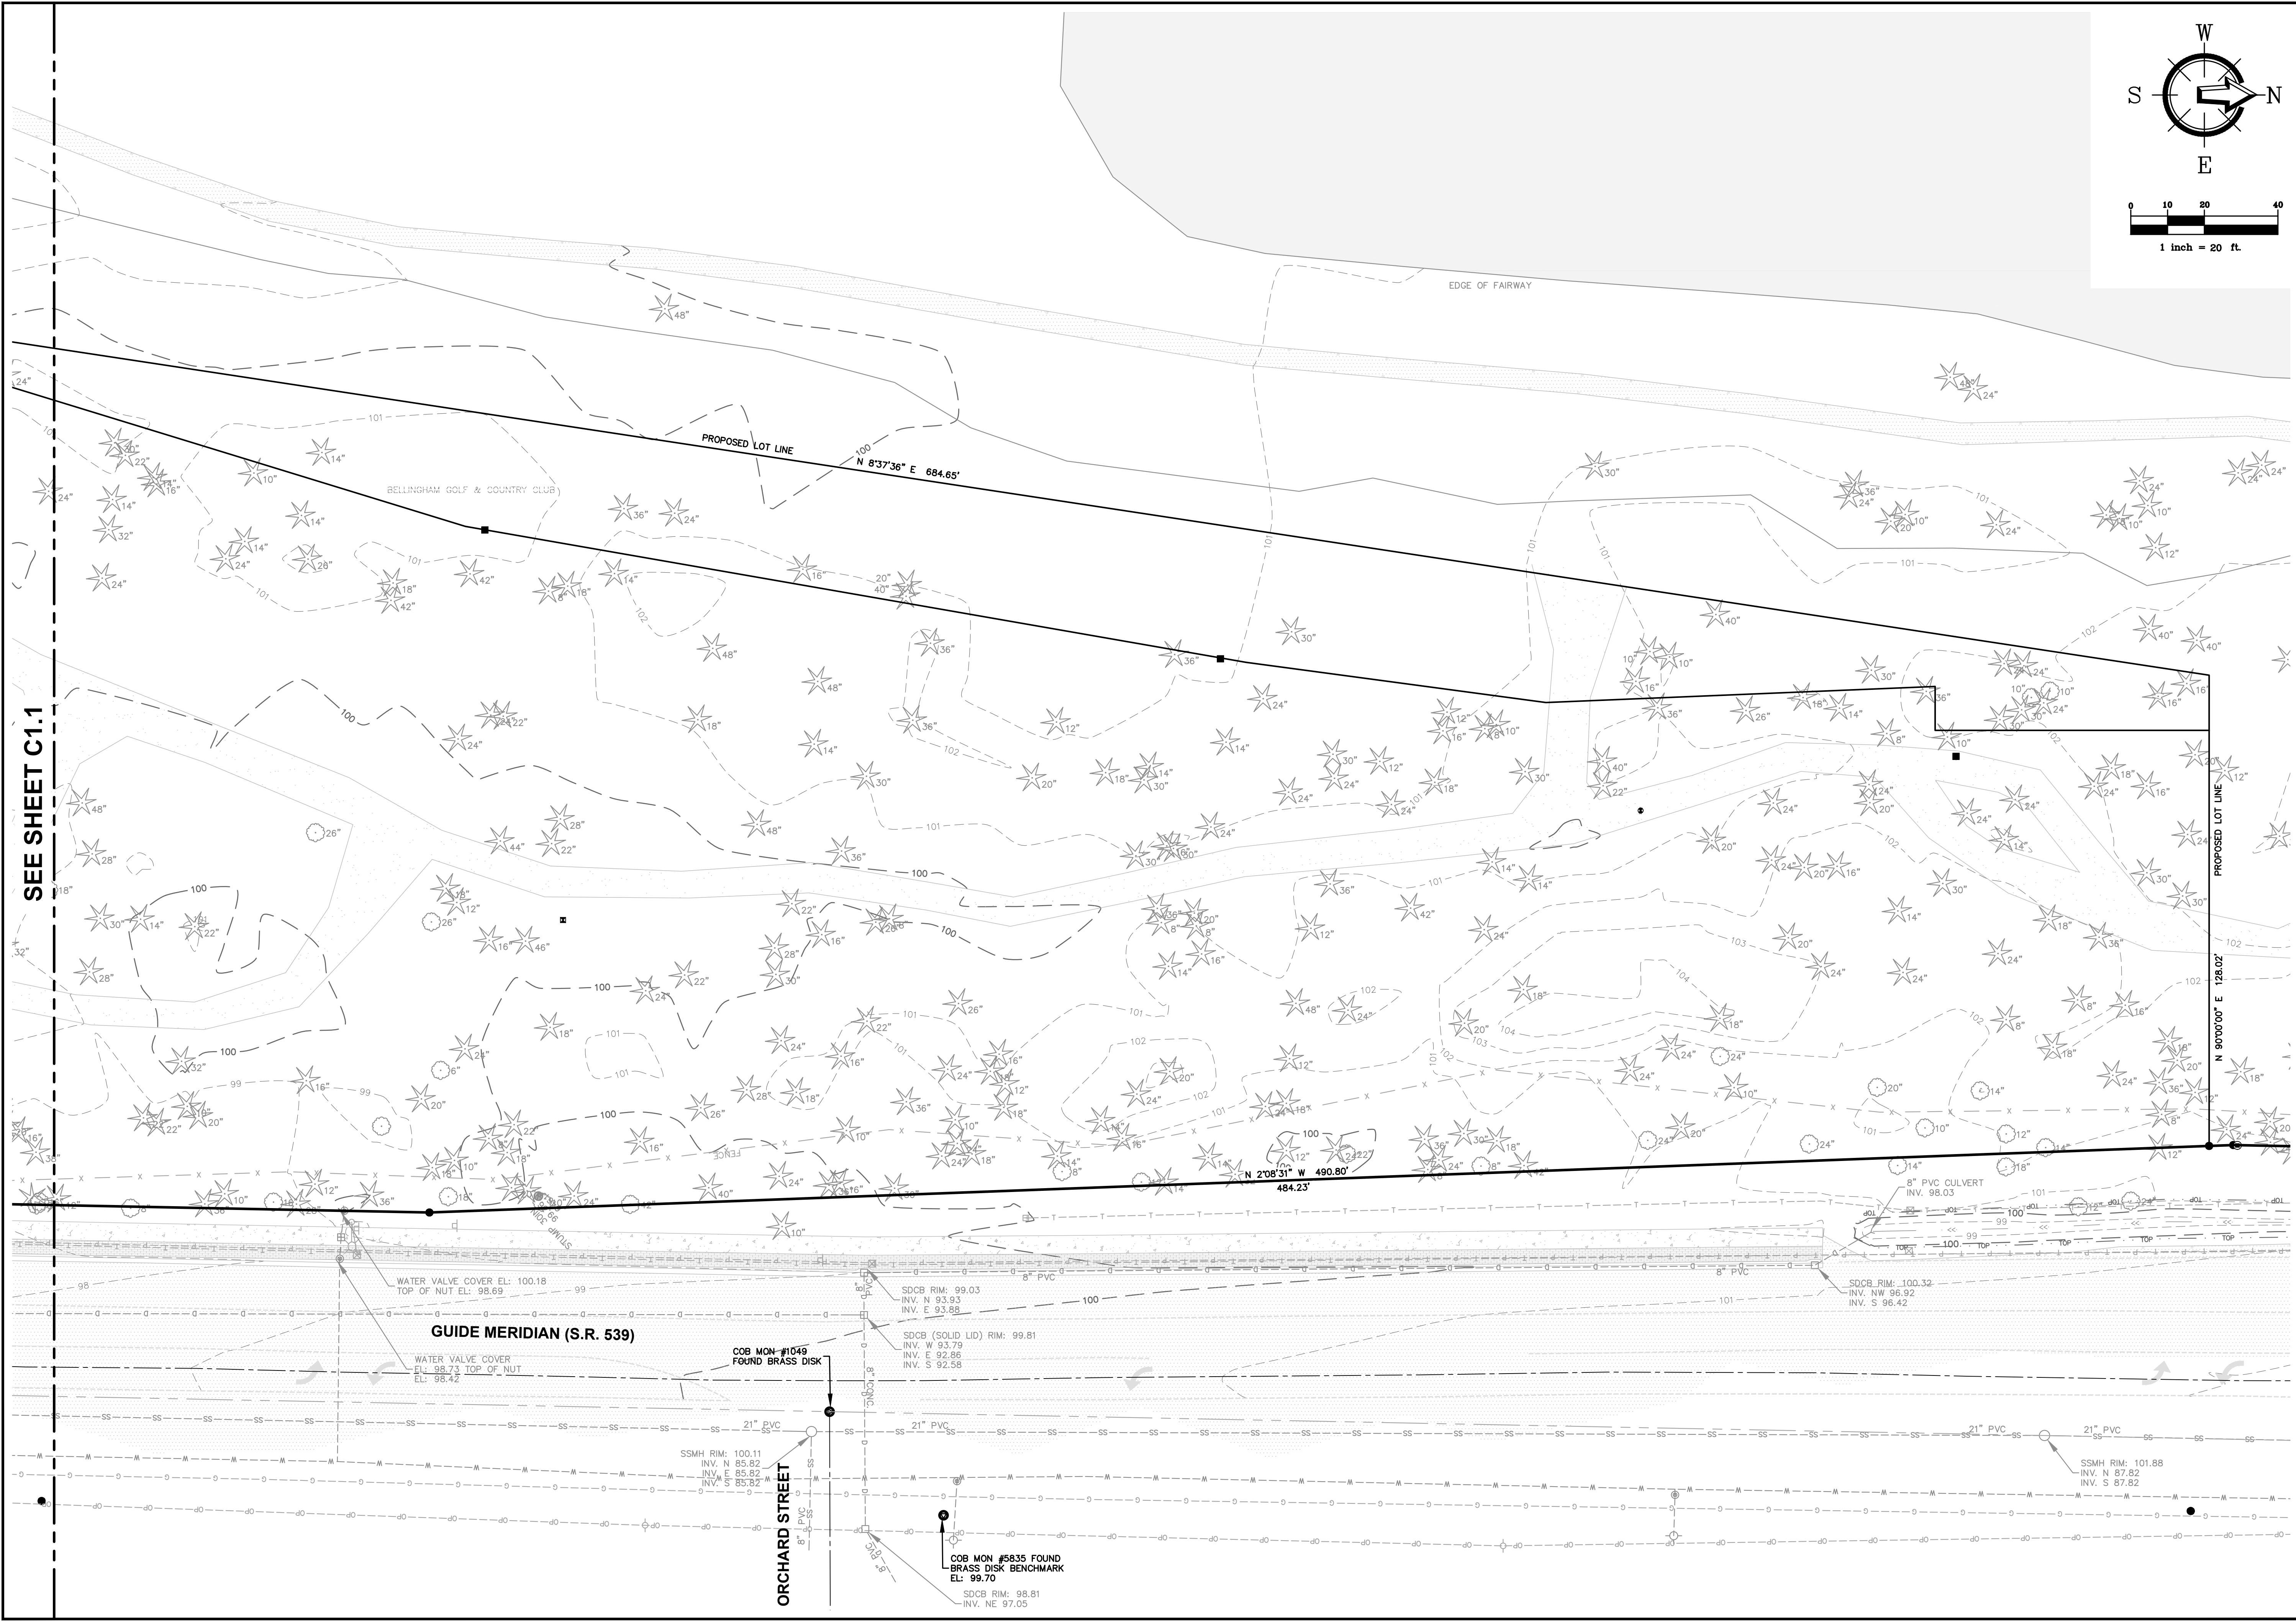

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Bellingham, WA 98225
t: 360.650.1408
f: 360.650.1401

FREELAND
& ASSOCIATES

REV.	DATE	DESCRIPTION

CLIENT: **STREAM REAL ESTATE DEVELOPMENT & INVESTMENT**
999 N NORTHLAKE WAY SUITE 200
SEATTLE, WA 98103

CALL BEFORE YOU DIG
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1-800-424-5655

PROJECT LOCATION: **STREAM BELLINGHAM TOWNHOMES**
3729 MERIDIAN ST
BELLINGHAM, WA 98225


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DESIGNED BY: NSP
DRAWN BY: NSP
CHECKED BY: JPS


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JOB #: 21185
DATE: 4-15-2023

SHEET: **C1.2**



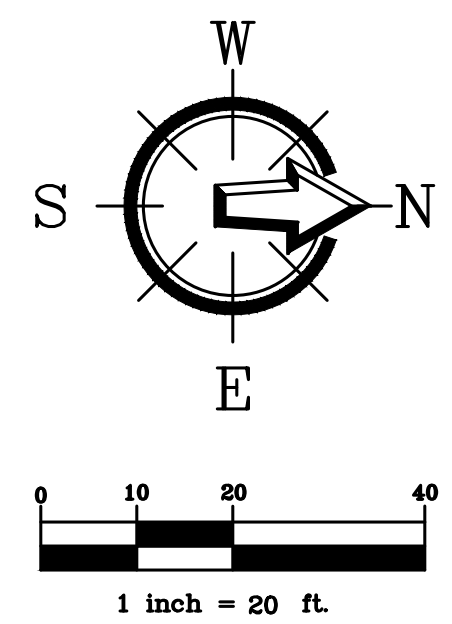


220 West Champion Street, Suite 200
Bellingham, WA 98225
t: 360.650.1408
f: 360.650.1401

FREELAND & ASSOCIATES

BY:									
DESCRIPTION:									
REV:									
DATE:									
CLIENT:	STREAM REAL ESTATE DEVELOPMENT & INVESTMENT 999 N NORTHLAKE WAY SUITE 200 SEATTLE, WA 98103 CALL BEFORE YOU DIG FOR BURIED UTILITY LOCATIONS 1-800-424-5655								
PROJECT LOCATION:	STREAM BELLINGHAM TOWNHOMES 3729 MERIDIAN ST BELLINGHAM, WA 98225								
DRAWING #:	21185SP7.DWG		DRAWN BY:	NSP		CHECKED BY:	JPS		
DESIGNED BY:	NSP								
SHEET CONTENTS:	SITE PLAN NORTH								
JOB #:	21185		DATE:	4-15-2023					
SHEET:	C2.2								



PRELIMINARY



F R E E L A N I
& A S S O C I A T E


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INVESTMENT**
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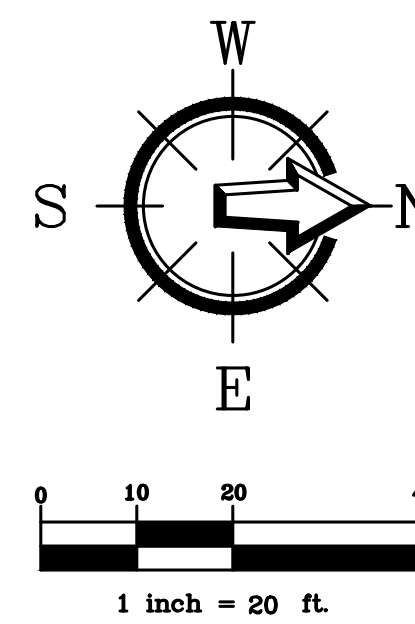
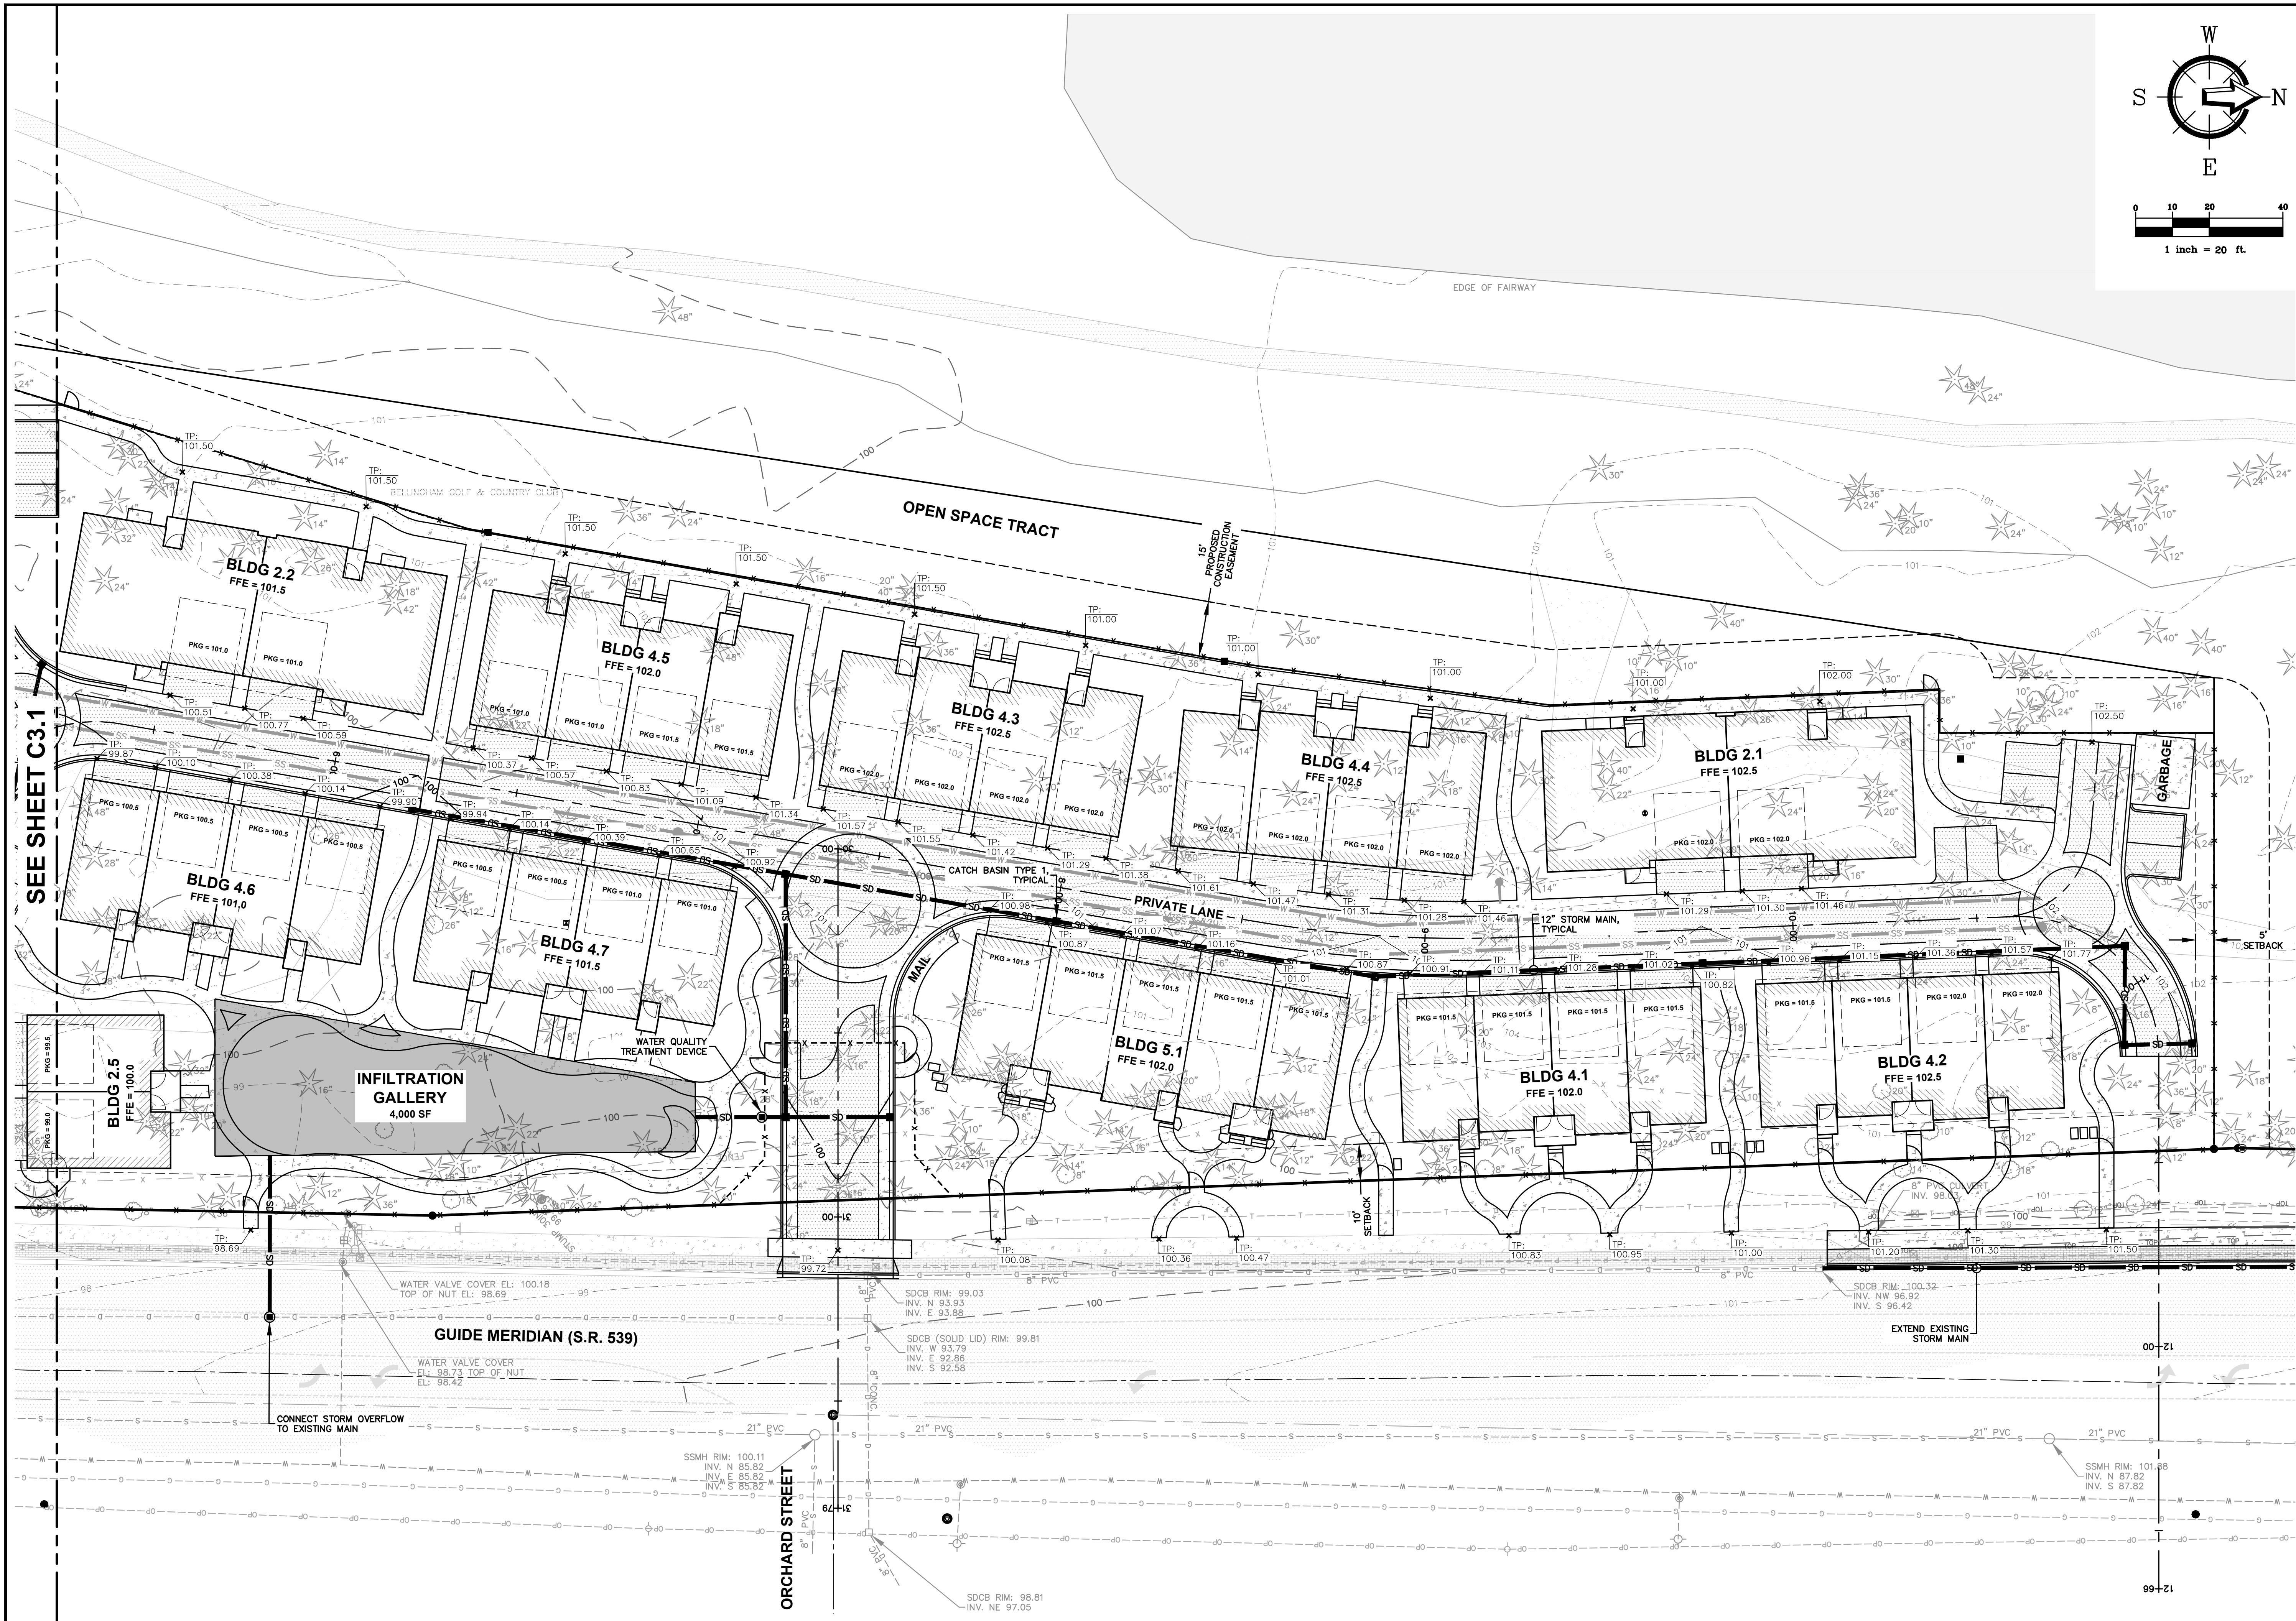
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DRAWING: #	21HCSPT.DWG	DRAWN BY: NSP
DESIGNED BY:		CHECKED BY:

SHEET **CONTENTS:**





JOB #: 21185	DATE: 4-15-2023
SHEET:	

C2.3

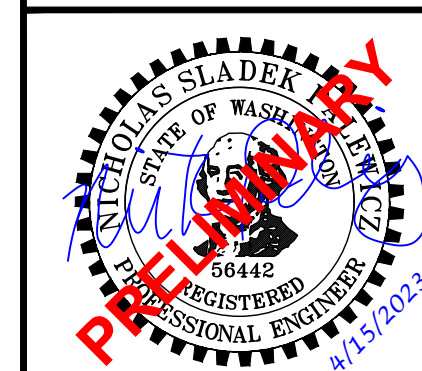

BY:	
DESCRIPTION:	
DATE:	
REV:	
CLIENT: STREAM REAL ESTATE DEVELOPMENT & INVESTMENT 999 N NORTH LAKE WAY SUITE 200 SEATTLE, WA 98103	CALL BEFORE YOU DIG FOR BURIED UTILITY LOCATIONS 1-800-424-5655
PROJECT LOCATION: STREAM BELLINGHAM TOWNHOMES 3729 MERIDIAN ST BELLINGHAM, WA 98225	DRAWN BY: NSP CHECKED BY: JPS
SHEET CONTENTS: GRADING & DRAINAGE PLAN NORTH	DRAWING #: 21185SP7.DWG DESIGNED BY: NSP
JOB #: 21185	DATE: 4-15-2023
SHEET:	C3.2

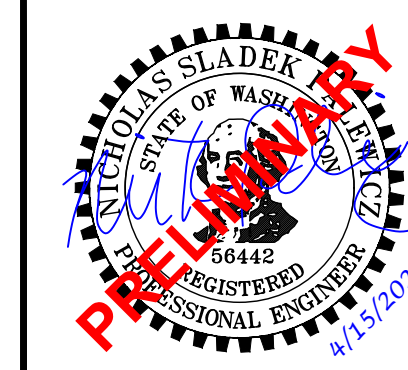

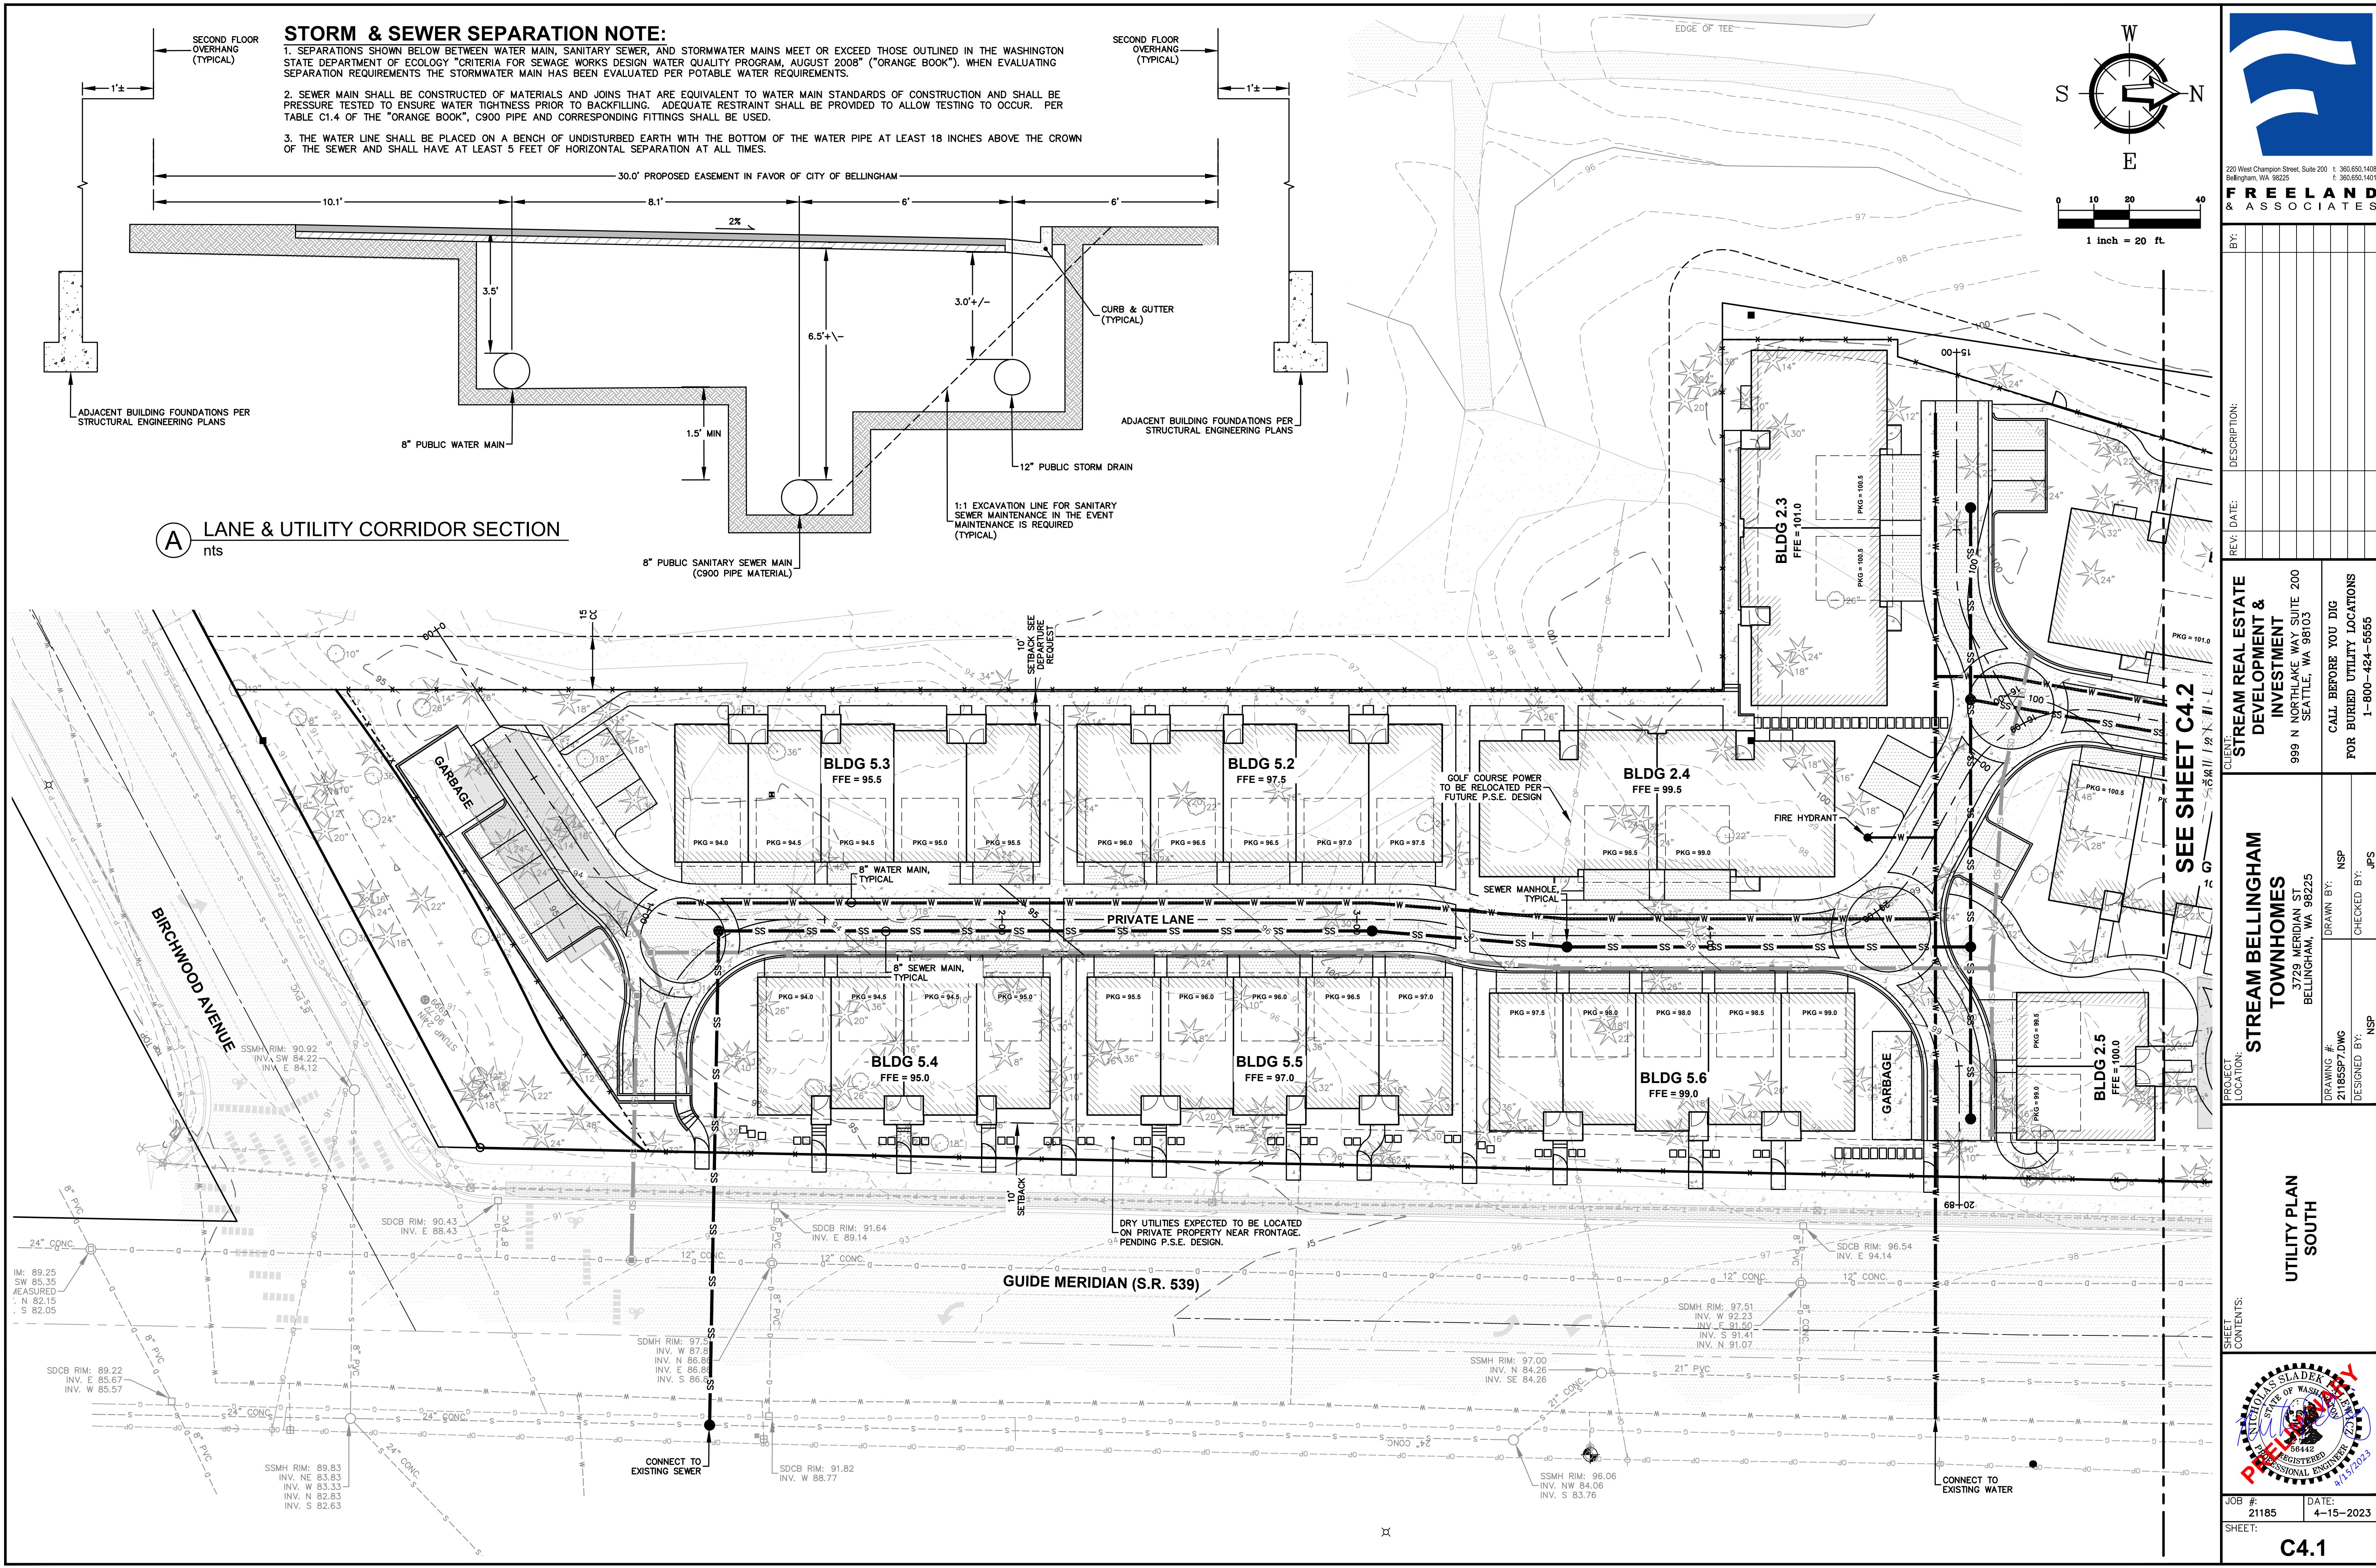

STORM & SEWER SEPARATION NOTE:

1. SEPARATIONS SHOWN BELOW BETWEEN WATER MAIN, SANITARY SEWER, AND STORMWATER MAINS MEET OR EXCEED THOSE OUTLINED IN THE WASHINGTON STATE DEPARTMENT OF ECOLOGY "CRITERIA FOR SEWAGE WORKS DESIGN WATER QUALITY PROGRAM, AUGUST 2008" ("ORANGE BOOK"). WHEN EVALUATING SEPARATION REQUIREMENTS THE STORMWATER MAIN HAS BEEN EVALUATED PER POTABLE WATER REQUIREMENTS.
2. SEWER MAIN SHALL BE CONSTRUCTED OF MATERIALS AND JOINS THAT ARE EQUIVALENT TO WATER MAIN STANDARDS OF CONSTRUCTION AND SHALL BE PRESSURE TESTED TO ENSURE WATER TIGHTNESS PRIOR TO BACKFILLING. ADEQUATE RESTRAINT SHALL BE PROVIDED TO ALLOW TESTING TO OCCUR. PER TABLE C1.4 OF THE "ORANGE BOOK", C900 PIPE AND CORRESPONDING FITTINGS SHALL BE USED.
3. THE WATER LINE SHALL BE PLACED ON A BENCH OF UNDISTURBED EARTH WITH THE BOTTOM OF THE WATER PIPE AT LEAST 18 INCHES ABOVE THE CROWN OF THE SEWER AND SHALL HAVE AT LEAST 5 FEET OF HORIZONTAL SEPARATION AT ALL TIMES.

A LANE & UTILITY CORRIDOR SECTION
nts



220 West Champion Street, Suite 200
Bellingham, WA 98225
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f: 360.650.1401
FREELAND & ASSOCIATES

BY:	
REV:	
DATE:	
DESCRIPTION:	


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DEVELOPMENT &
INVESTMENT
999 N NORTHLAKE WAY SUITE 200
SEATTLE, WA 98103
**CALL BEFORE YOU DIG
FOR BURIED UTILITY LOCATIONS**
1-800-424-5655

PROJECT LOCATION:
STREAM BELLINGHAM
TOWNHOMES
3729 MERIDIAN ST
BELLINGHAM, WA 98225
DRAWING #:
21185SP7.DWG
DESIGNED BY:
NSP
CHECKED BY:
JPS

SHEET CONTENTS:
UTILITY PLAN
SOUTH



JOB #:
21185
DATE:
4-15-2023
SHEET:

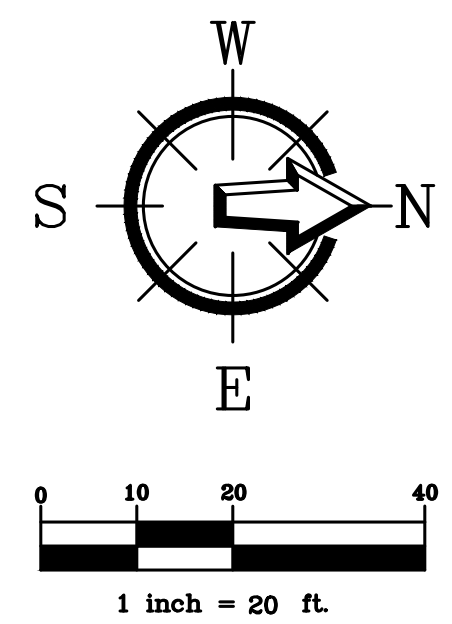

220 West Champion Street, Suite 200
Bellingham, WA 98225

t: 360.650.1408
f: 360.650.1401

REV.	DATE	DESCRIPTION

CLIENT: **STREAM REAL ESTATE DEVELOPMENT & INVESTMENT**
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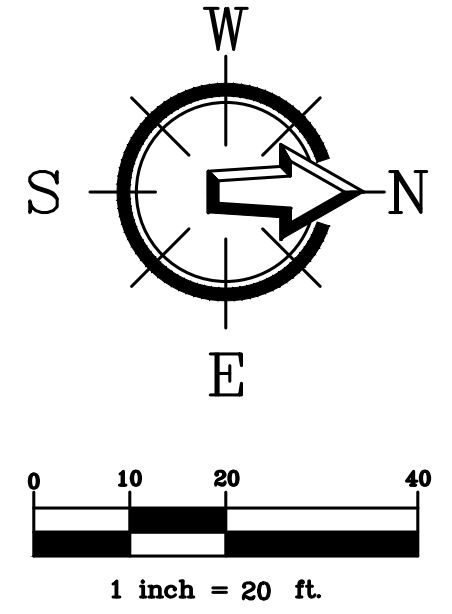
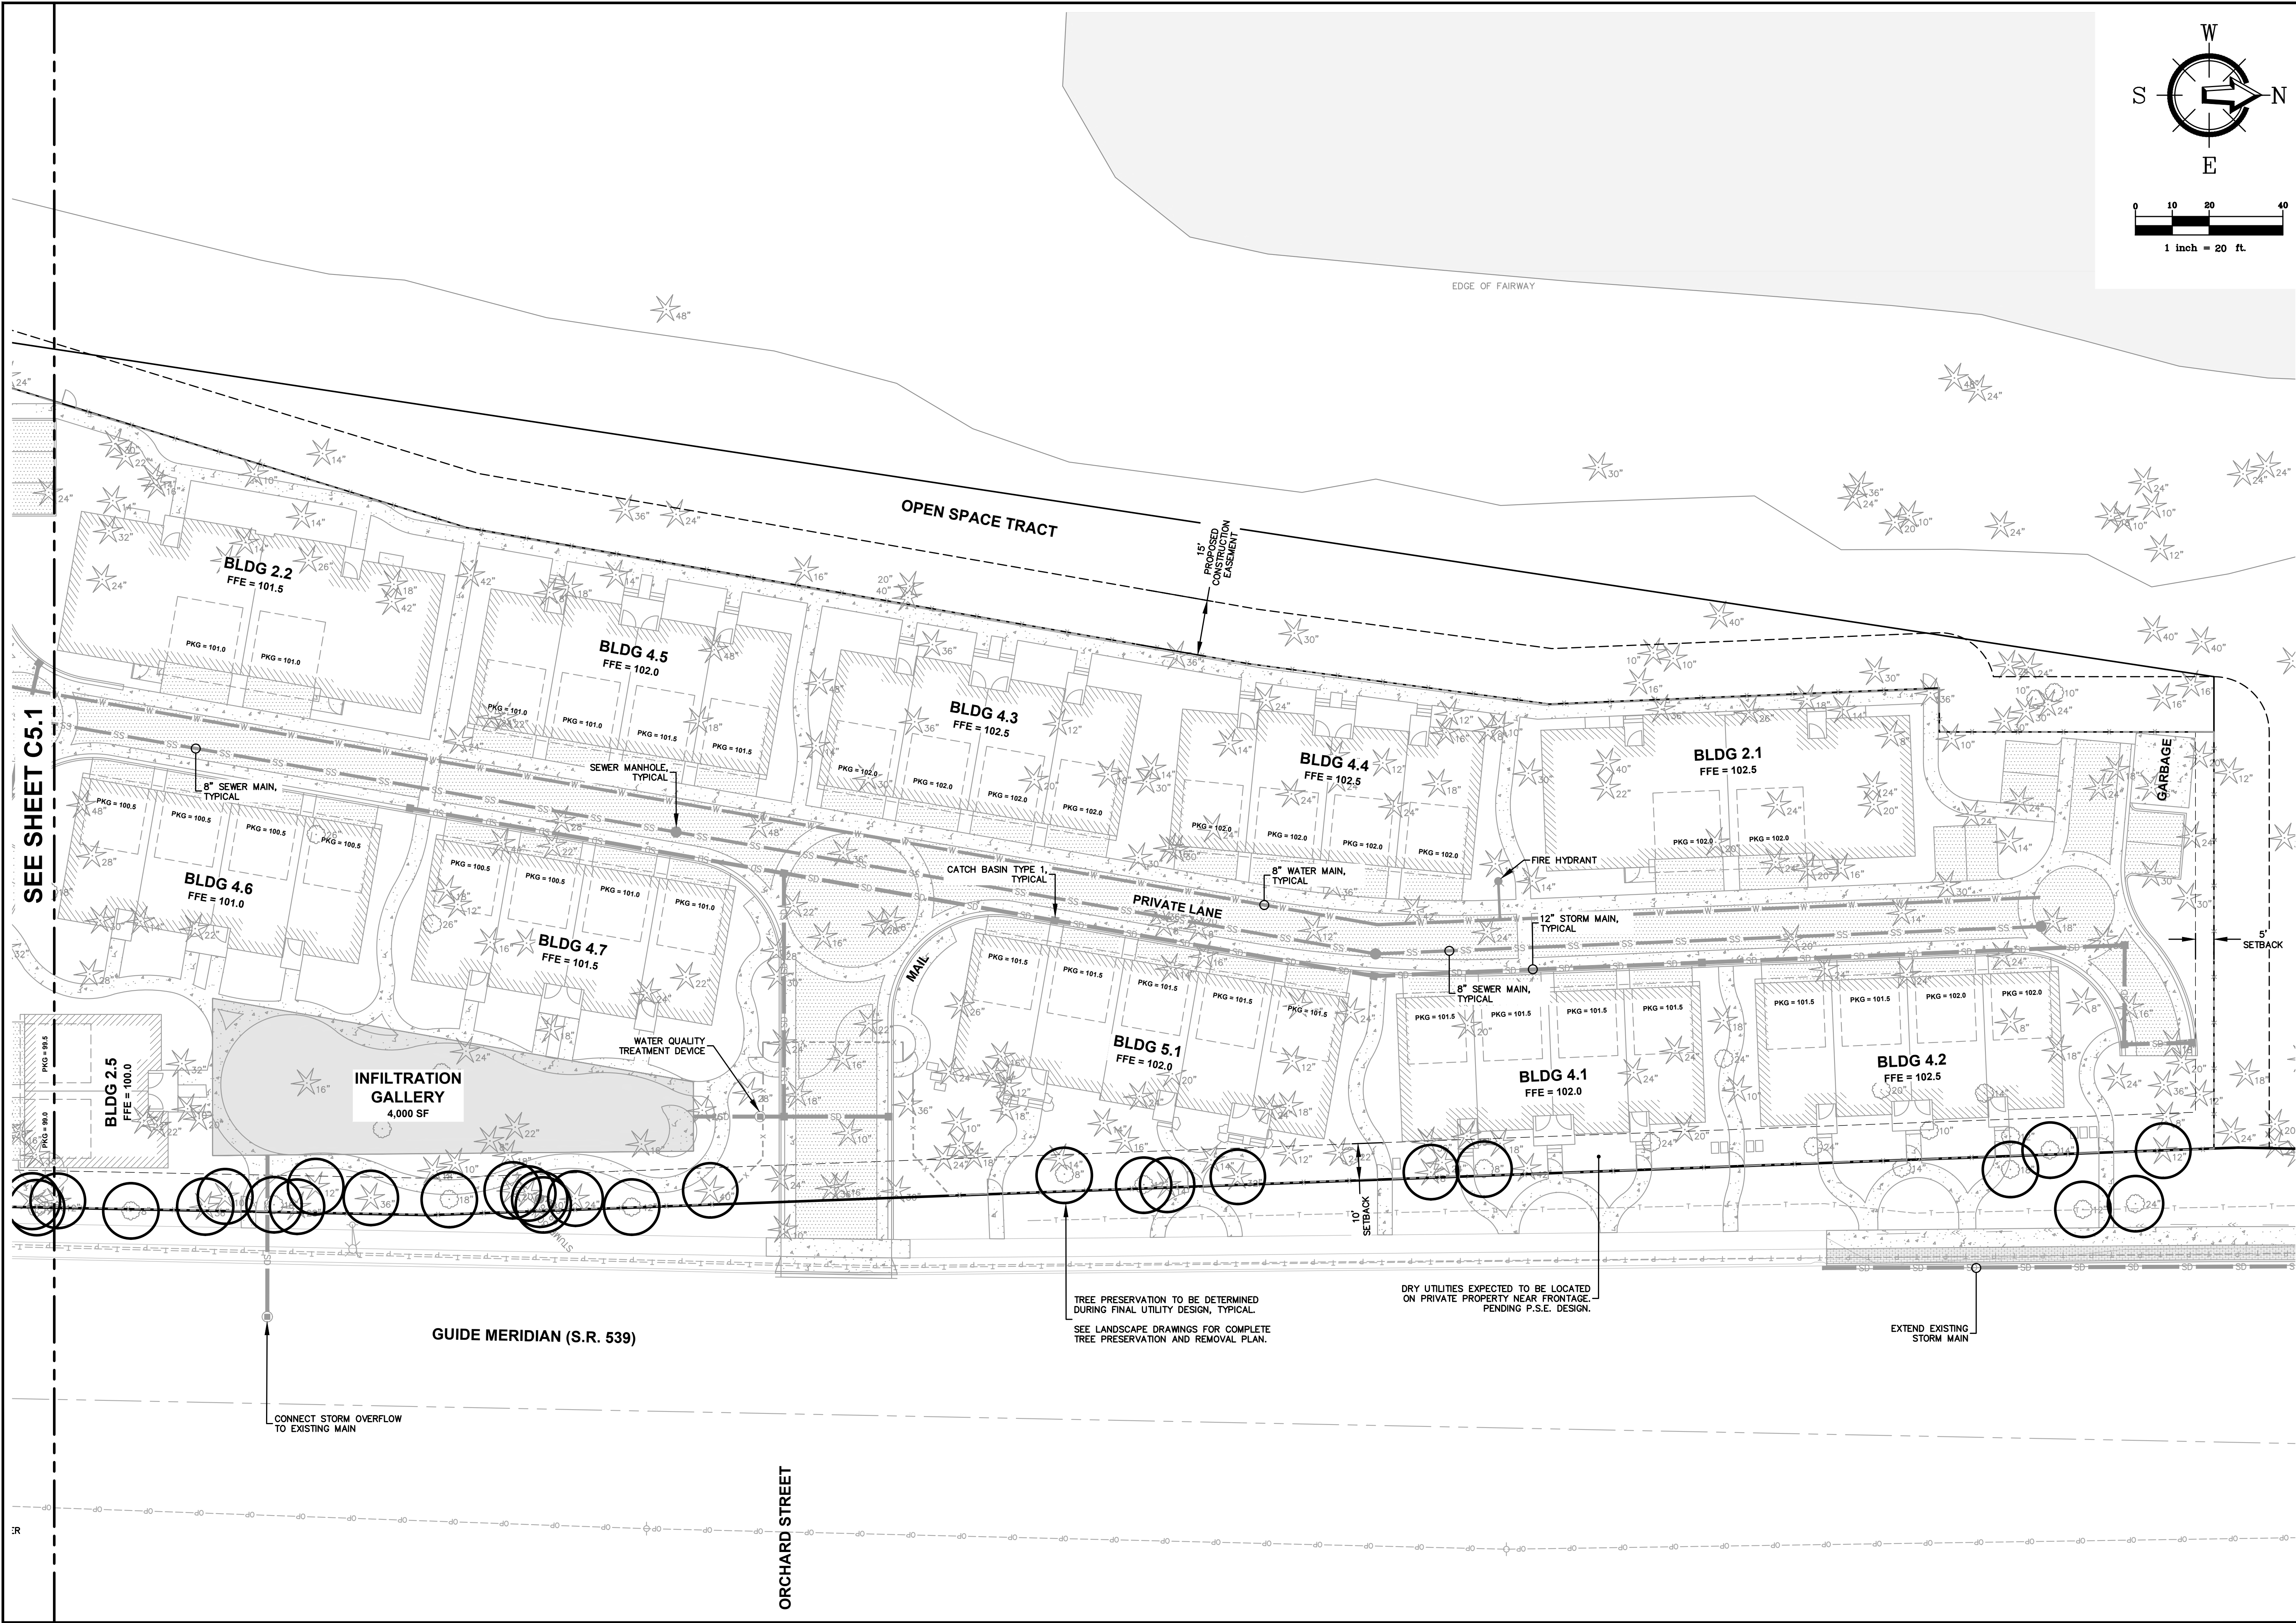
PROJECT LOCATION: **STREAM BELLINGHAM TOWNHOMES**
3729 MERIDIAN ST
BELLINGHAM, WA 98225
DRAWING #: 21185SP7.DWG
DESIGNED BY: NSP
DRAWN BY: NSP
CHECKED BY: JPS

SHEET CONTENTS: **PRELIMINARY PLAT MAP NORTH**



JOB #: 21185
DATE: 4-15-2023

SHEET: **C5.2**



REV.	DATE	DESCRIPTION

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PROJECT LOCATION: **STREAM BELLINGHAM TOWNHOMES NORTH**
3729 MERIDIAN ST
BELLINGHAM, WA 98225
DRAWING #: 21185SP7.DWG
DESIGNED BY: NSP
DRAWN BY: NSP
CHECKED BY: JPS

SHEET CONTENTS: **TREE & UTILITY PLAN NORTH**



JOB #: 21185
DATE: 4-15-2023
SHEET: **C6.2**



1 ALL EXISTING TREES ON SITE
Scale: 1" = 40'-0"



2 PROPOSED TREES + EXISTING TREES TO REMAIN
Scale: 1" = 40'-0"



ISSUE DATE: 07/29/22
REISSUE DATE: 01/13/23
REISSUE DATE: 04/17/23
REISSUE DATE: 09/13/23

PROJECT NAME:

STREAM BELLINGHAM
TOWNHOMES
3726 Meridian Street
Bellingham, Washington 98225

SHEET NAME:

TREE
CALCULATIONS
-
REMOVED/
REMAIN/
PROPOSED


SCALE:

1"=40'-0"

SHEET NUMBER:

L-0.TC

												
Oregon White Oak Quercus garryana	Japanese Zelkova Zelkova serrata	Eddie's White Wonder Dogwood Cornus 'Eddie's White Wonder'	Japanese snowdrop Styrax japonica	Autumn Brilliance Serviceberry Amelanchier x grandiflora 'Autumn Brilliance'	Saucer Magnolia Magnolia x Soulangiana	Little Gem Magnolia Magnolia grandiflora 'Little Gem'	Claim Jumper Kasura Tree Cercidiphyllum japonicum 'Claim Jumper'	Slender Hinoki Cypress Chamaecyparis obtusa 'Gracilis'	Weeping Alaska Cedar Chamaecyparis nootkatensis	Hoopsii Blue Spruce Picea pungens 'Hoopsii'		
COMMON AREA TREES - POSSIBLE TREE LIST												
I LARGE TREE (Canopy Spread 30') GREEN FACTOR AREA=100 SF					10 MEDIUM TREES (Canopy Spread 25') GREEN FACTOR AREA=300 SF					42 SMALL TREES (Canopy Spread 15') GREEN FACTOR AREA=630 SF	6-NARROW EVERGREEN TREES (Plants 2' or taller) GREEN FACTOR=34 SF	
Proposed at Pocket Park Entrance					Proposed along Driveways and Common Areas by Parking and Garbage Enclosure					No less than 6' ht. at time of installation with min. 1" caliper measured one foot above grade	Proposed between building where space allows	
Proposed within or Near Private Yard Spaces												
Botaninc Name					Common Name					Size/ Space	Common Name	Size/ Space
Acer palmatum					Upright Japanese Maple					12'-15'oc	Chamaecyparis obtusa 'Gracilis'	Slender Hinoki Cypress
Magnolia x Soulangiana					Saucer Magnolia					15'oc	Cupressus nootkatensis 'Van den Akker'	Van den Akker Weeping Alaska Cedar
Magnolia					Little Gem Magnolia Tree					10-15'oc	Picea pungens 'Hoopsii'	Hoopsii Blue Spruce
Malus adirondack					Adirocack Crabapple					12'-15'oc	Picea abies 'Cupressina'	Columnar Norway Spruce
Prunus x hilleri Spire					Spire Cherry Tree					12'-15'oc		6'-8' ht/ 10'oc
Cercidiphyllum japon. 'Claim Jumper'					Claim Jumper' Katsura Tree					15'oc		

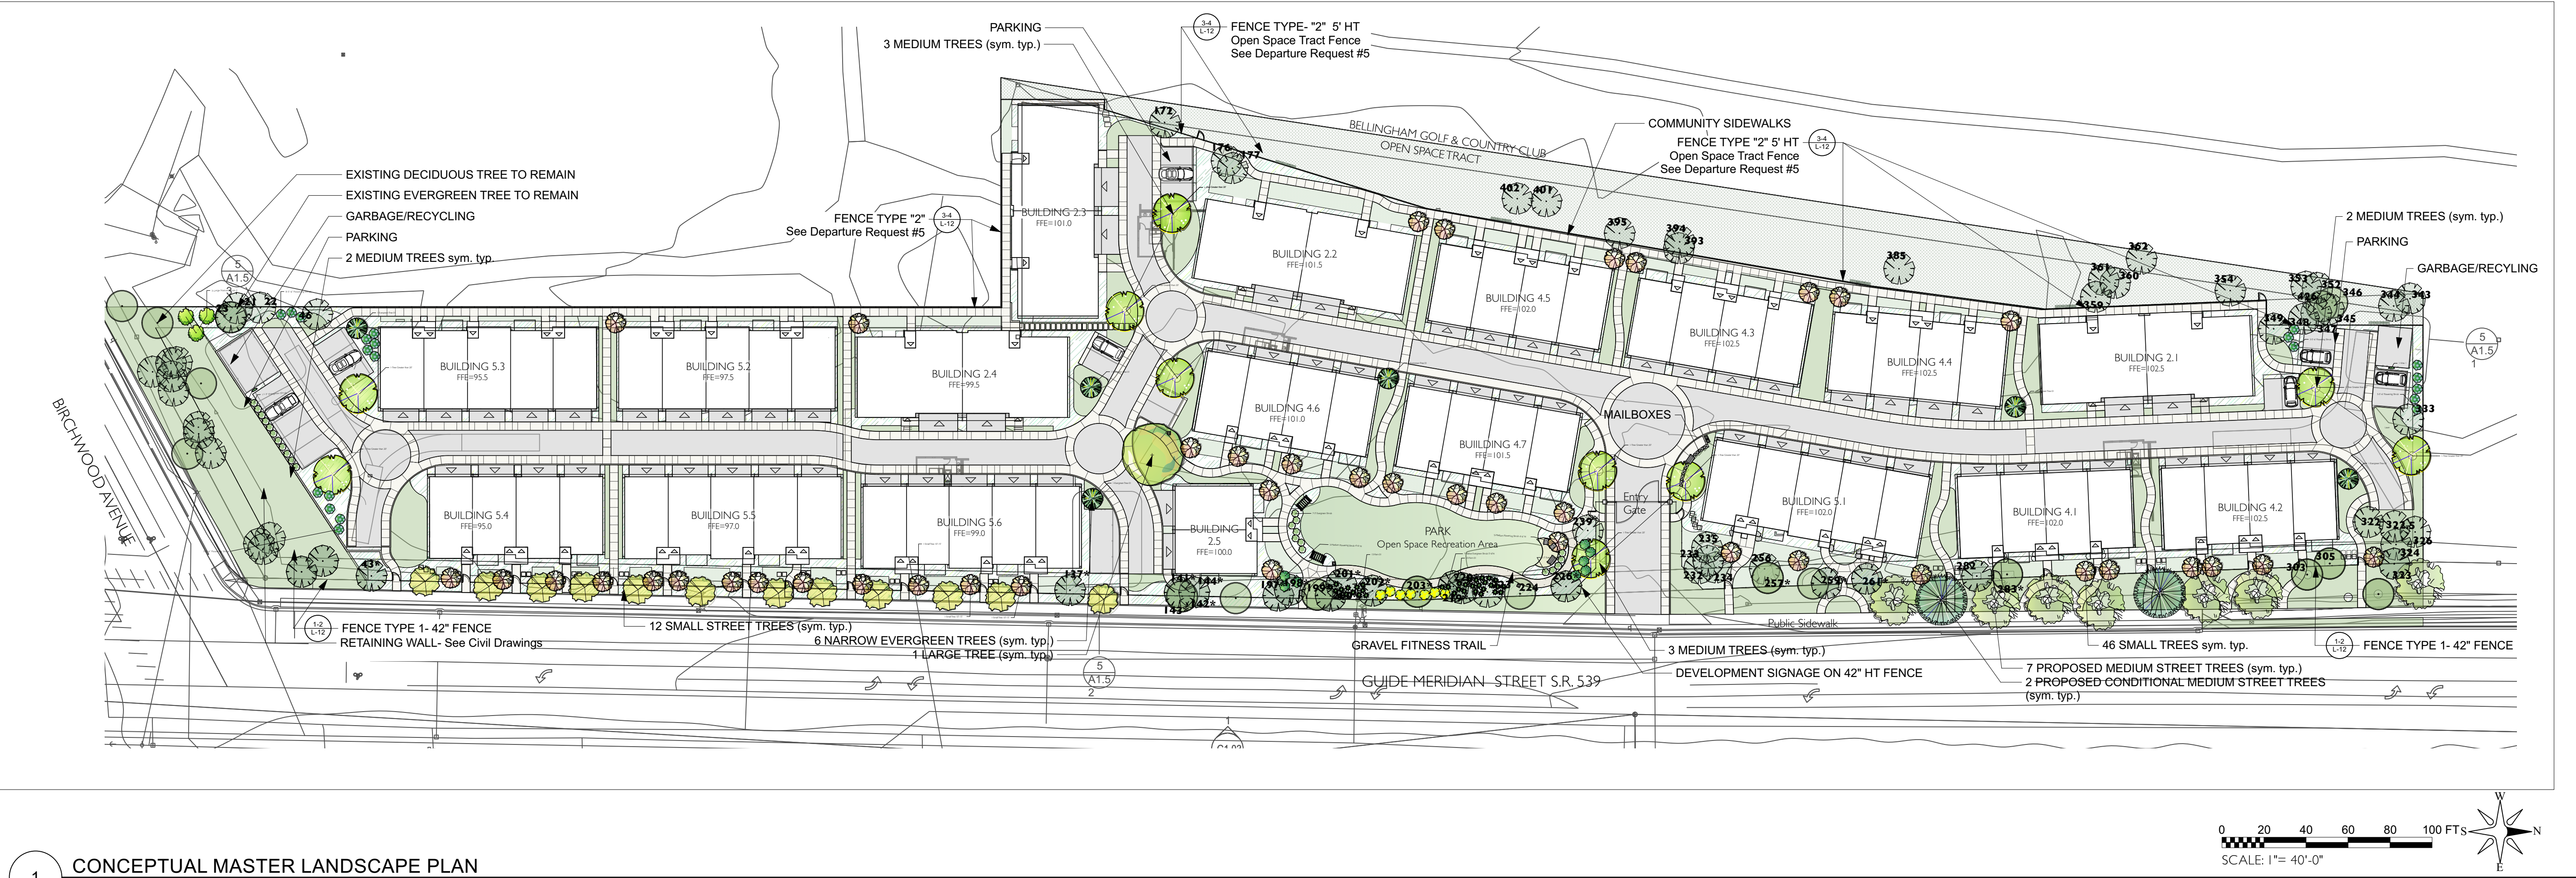

1 CONCEPTUAL MASTER LANDSCAPE PLAN
Scale: 1" = 40'-0"

21 RIGHT OF WAY PLANTING - POSSIBLE TREE LIST
Required: 1 tree per every 50 lin.ft. = 20 Required / 21 Proposed - PER CODE: STREET TREES SHALL BE NO LESS THAN 10' HT AND HAVE A MIN. CALIPER OF 2.5" MEASURED 1' ABOVE GRADE

12- SMALL STREET TREES 2.5" min cal. GREEN FACTOR AREA=180 SF

Botanic Name	Common Name	Size / Space
Carpinus japonica	Japanese Hornbeam	20' w
Ginkgo biloba 'Princeton Sentry'	Princeton Sentry Maiden Hair Tree	15' w
Quercus robur 'Crimson Spire'	Crimson Spire Oak	15' w



2- CONDITIONAL MEDIUM STREET TREES GREEN FACTOR AREA=120SF

Botanic Name	Common Name	Size / Space
Thuja plicata var. Excelsa	Excelsa Western Red Cedar	10' / 20' oc
Pseudotsuga menziesii	Douglas Fir	10' 20-25' oc



7- MEDIUM STREET TREES GREENFACTOR AREA =420 SF

Botanic Name	Common Name	Size / Space
Carpinus betulus	European Hornbeam	2.5"min/25-30'
Fraxinus pennsylvanic 'Patmore'	Patmore Ash	2.5"min/30-35'
Koeleruteria paniculata	Golden Rain Tree	2.5' min/30-35'



SEE SHEET L-11 FOR GREENFACTOR TOTAL SCORE

- GENERAL NOTES:
1. No landscape bed shall have artificial impervious materials underneath the surface bed
 2. Provisions should be taken to ensure proper drainage.
 3. All trees over 8' should be staked for less than one year.
 4. No fencing shall be placed between units.

LEGEND :

	Existing Deciduous Tree to Remain as possible
	Existing Evergreen Tree to Remain as possible
	Proposed Planting Areas
	Proposed Concrete Sidewalks, Road Pavement Details, + Driveways
	Proposed Common Area Lawn
	Proposed Private Lawn
	Proposed Open Space Easement
	Asphalt- Road- Drive lane, Parking, Garbage Areas.
	Proposed Fence / Gate



KIM ROONEY
landscape architecture
3627 w.Vermont Way West
Seattle, Wa. 98199
office: 206-920-1323



STATE OF WASHINGTON
REGISTERED
LANDSCAPE ARCHITECT
Kim E. Rooney
CERTIFICATE NO. 958

ISSUE DATE: 7/29/22
REISSUE DATE: 01/13/23
REISSUE DATE: 04/17/23
REISSUE DATE: 09/13/23

PROJECT NAME:

STREAM BELLINGHAM
TOWNHOMES
3726 Meridian Street
Bellingham, Washington 98225

SHEET NAME:

CONCEPTUAL
LANDSCAPE
PLAN
PROPOSED
TREES

SCALE: 1"=40'-0"

SHEET NUMBER:

L-1.A



STATE OF
WASHINGTON
REGISTERED
LANDSCAPE ARCHITECT

Kim E. Rooney
KIM E. ROONEY
CERTIFICATE NO. 958

REISSUE DATE: 09/13/2011

PROJECT NAME

STREAM BELLINGHAM
TOWNHOMES
3726 Meridian Street
Bellingham, Washington 98225

SHEET NAME:




CONCEPTUAL LANDSCAPE PLAN

PROPOSED
TREES


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SHEET NUMBER:


L-1.B

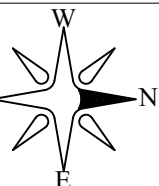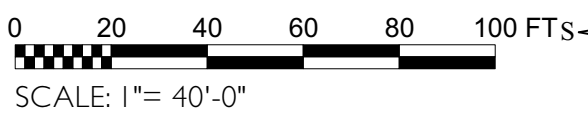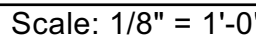

Scale: 1" = 40'-0"

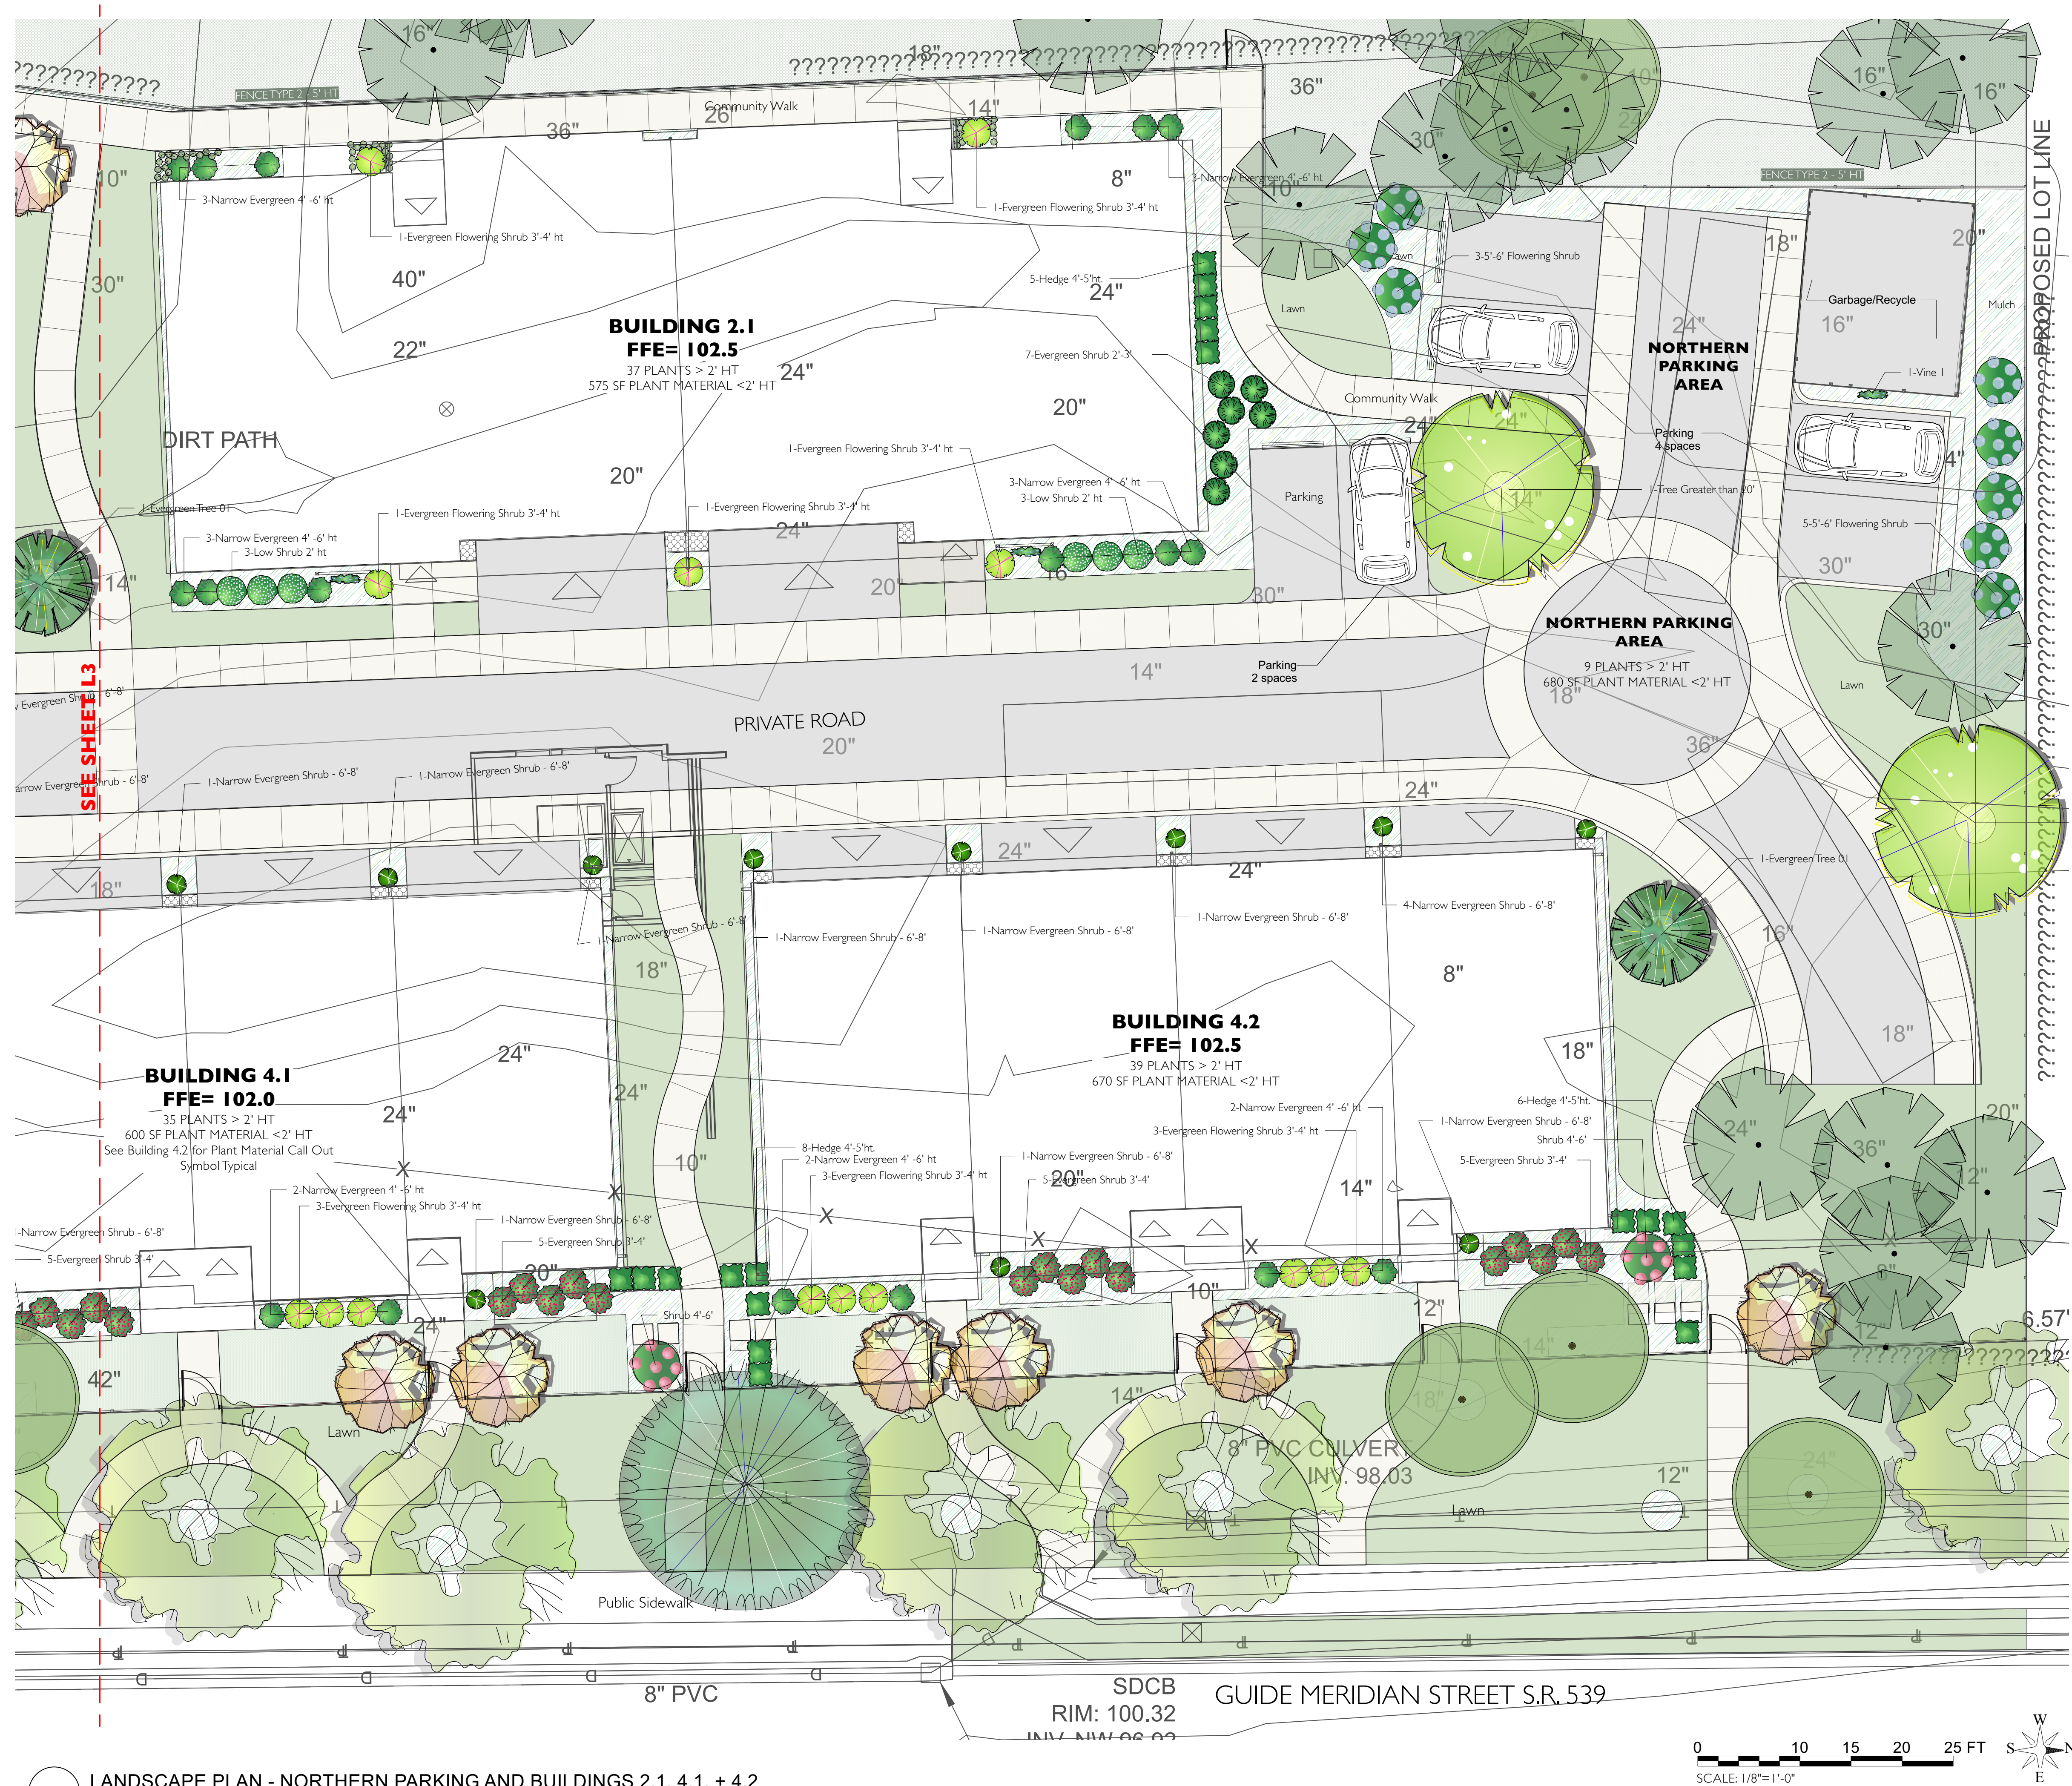

1 LANDSCAPE PLAN - NORTHERN PARKING AND BUILDINGS 2.1, 4.1, + 4.2
Scale: 1/8" = 1'-0"

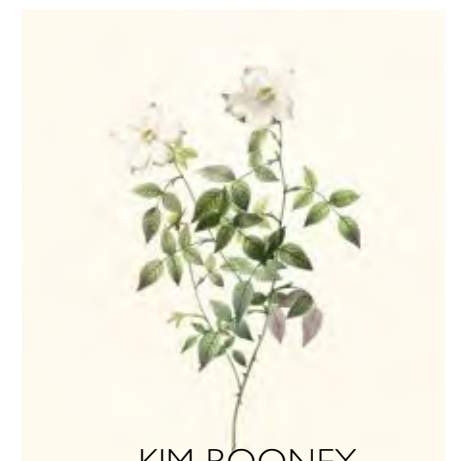

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ISSUE DATE: 7/29/22
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PROJECT NAME:

STREAM BELLINGHAM
TOWNHOMES
3726 Meridian Street
Bellingham, Washington 98225

SHEET NAME:

**CONCEPTUAL
LANDSCAPE
PLAN**
Northern Parking
Area + Buildings
2.1, 4.1, 4.2



SCALE: 1/8" = 1'-0"

SHEET NUMBER:

L-2



1 LANDSCAPE PLAN - BUILDINGS 4.3, 4.4 + 5.1
Scale: 1/8" = 1'-0"

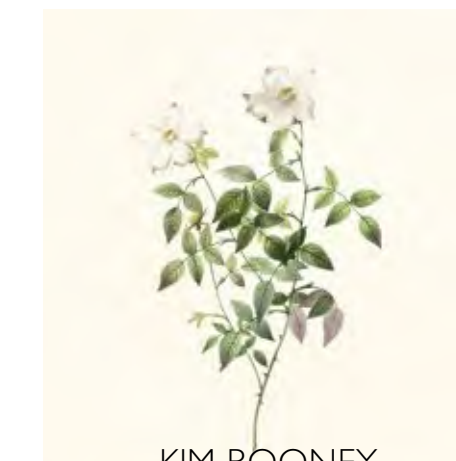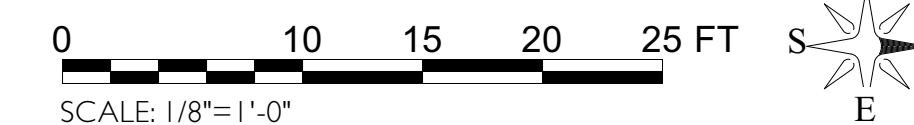

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REISSUE DATE: 09/13/23

PROJECT NAME:

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Bellingham, Washington 98225


SHEET NAME:

CONCEPTUAL
LANDSCAPE
PLAN
BUILDINGS
4.3, 4.4, + 5.1

SCALE: 1/8" = 1'-0"

SHEET NUMBER:

L-3

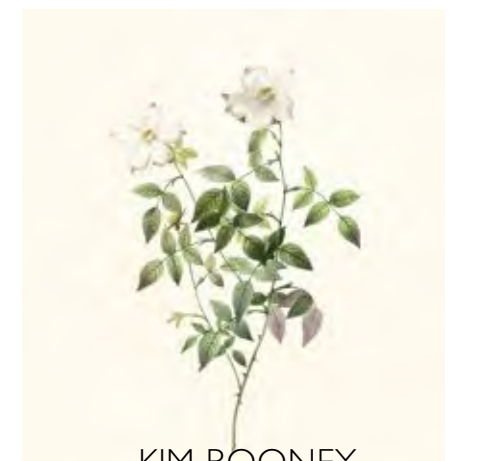

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office: 206-920-1323



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REISSUE DATE: 09/13/23

PROJECT NAME:

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TOWNHOMES
3726 Meridian Street
Bellingham, Washington 98225

SHEET NAME:

**CONCEPTUAL
LANDSCAPE
PLAN**
BUILDINGS
2.2, 4.5, 4.6 + 4.7


SCALE: 1/8" = 1'-0"

SHEET NUMBER:

L-4



andscape architecture
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Seattle, Wa. 98199
office: 206-920-1323

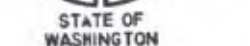

ISSUE DATE: 7/29/22

REISSUE DATE: 01/13/2011

REISSUE DATE: 04/17/2018

REISSUE DATE: 09/13/2011

PROJECT NAME:

STREAM BELLINGHAM
TOWNHOMES
3726 Meridian Street
Bellingham, Washington 98225

SHEET NAME:

CONCEPTUAL LANDSCAPE PLAN

CENTRAL PARKING
+ 2.3 + 2.4


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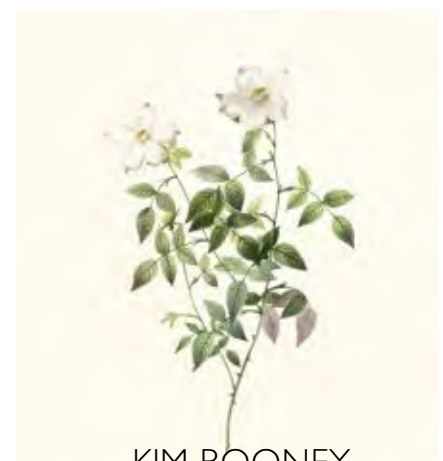
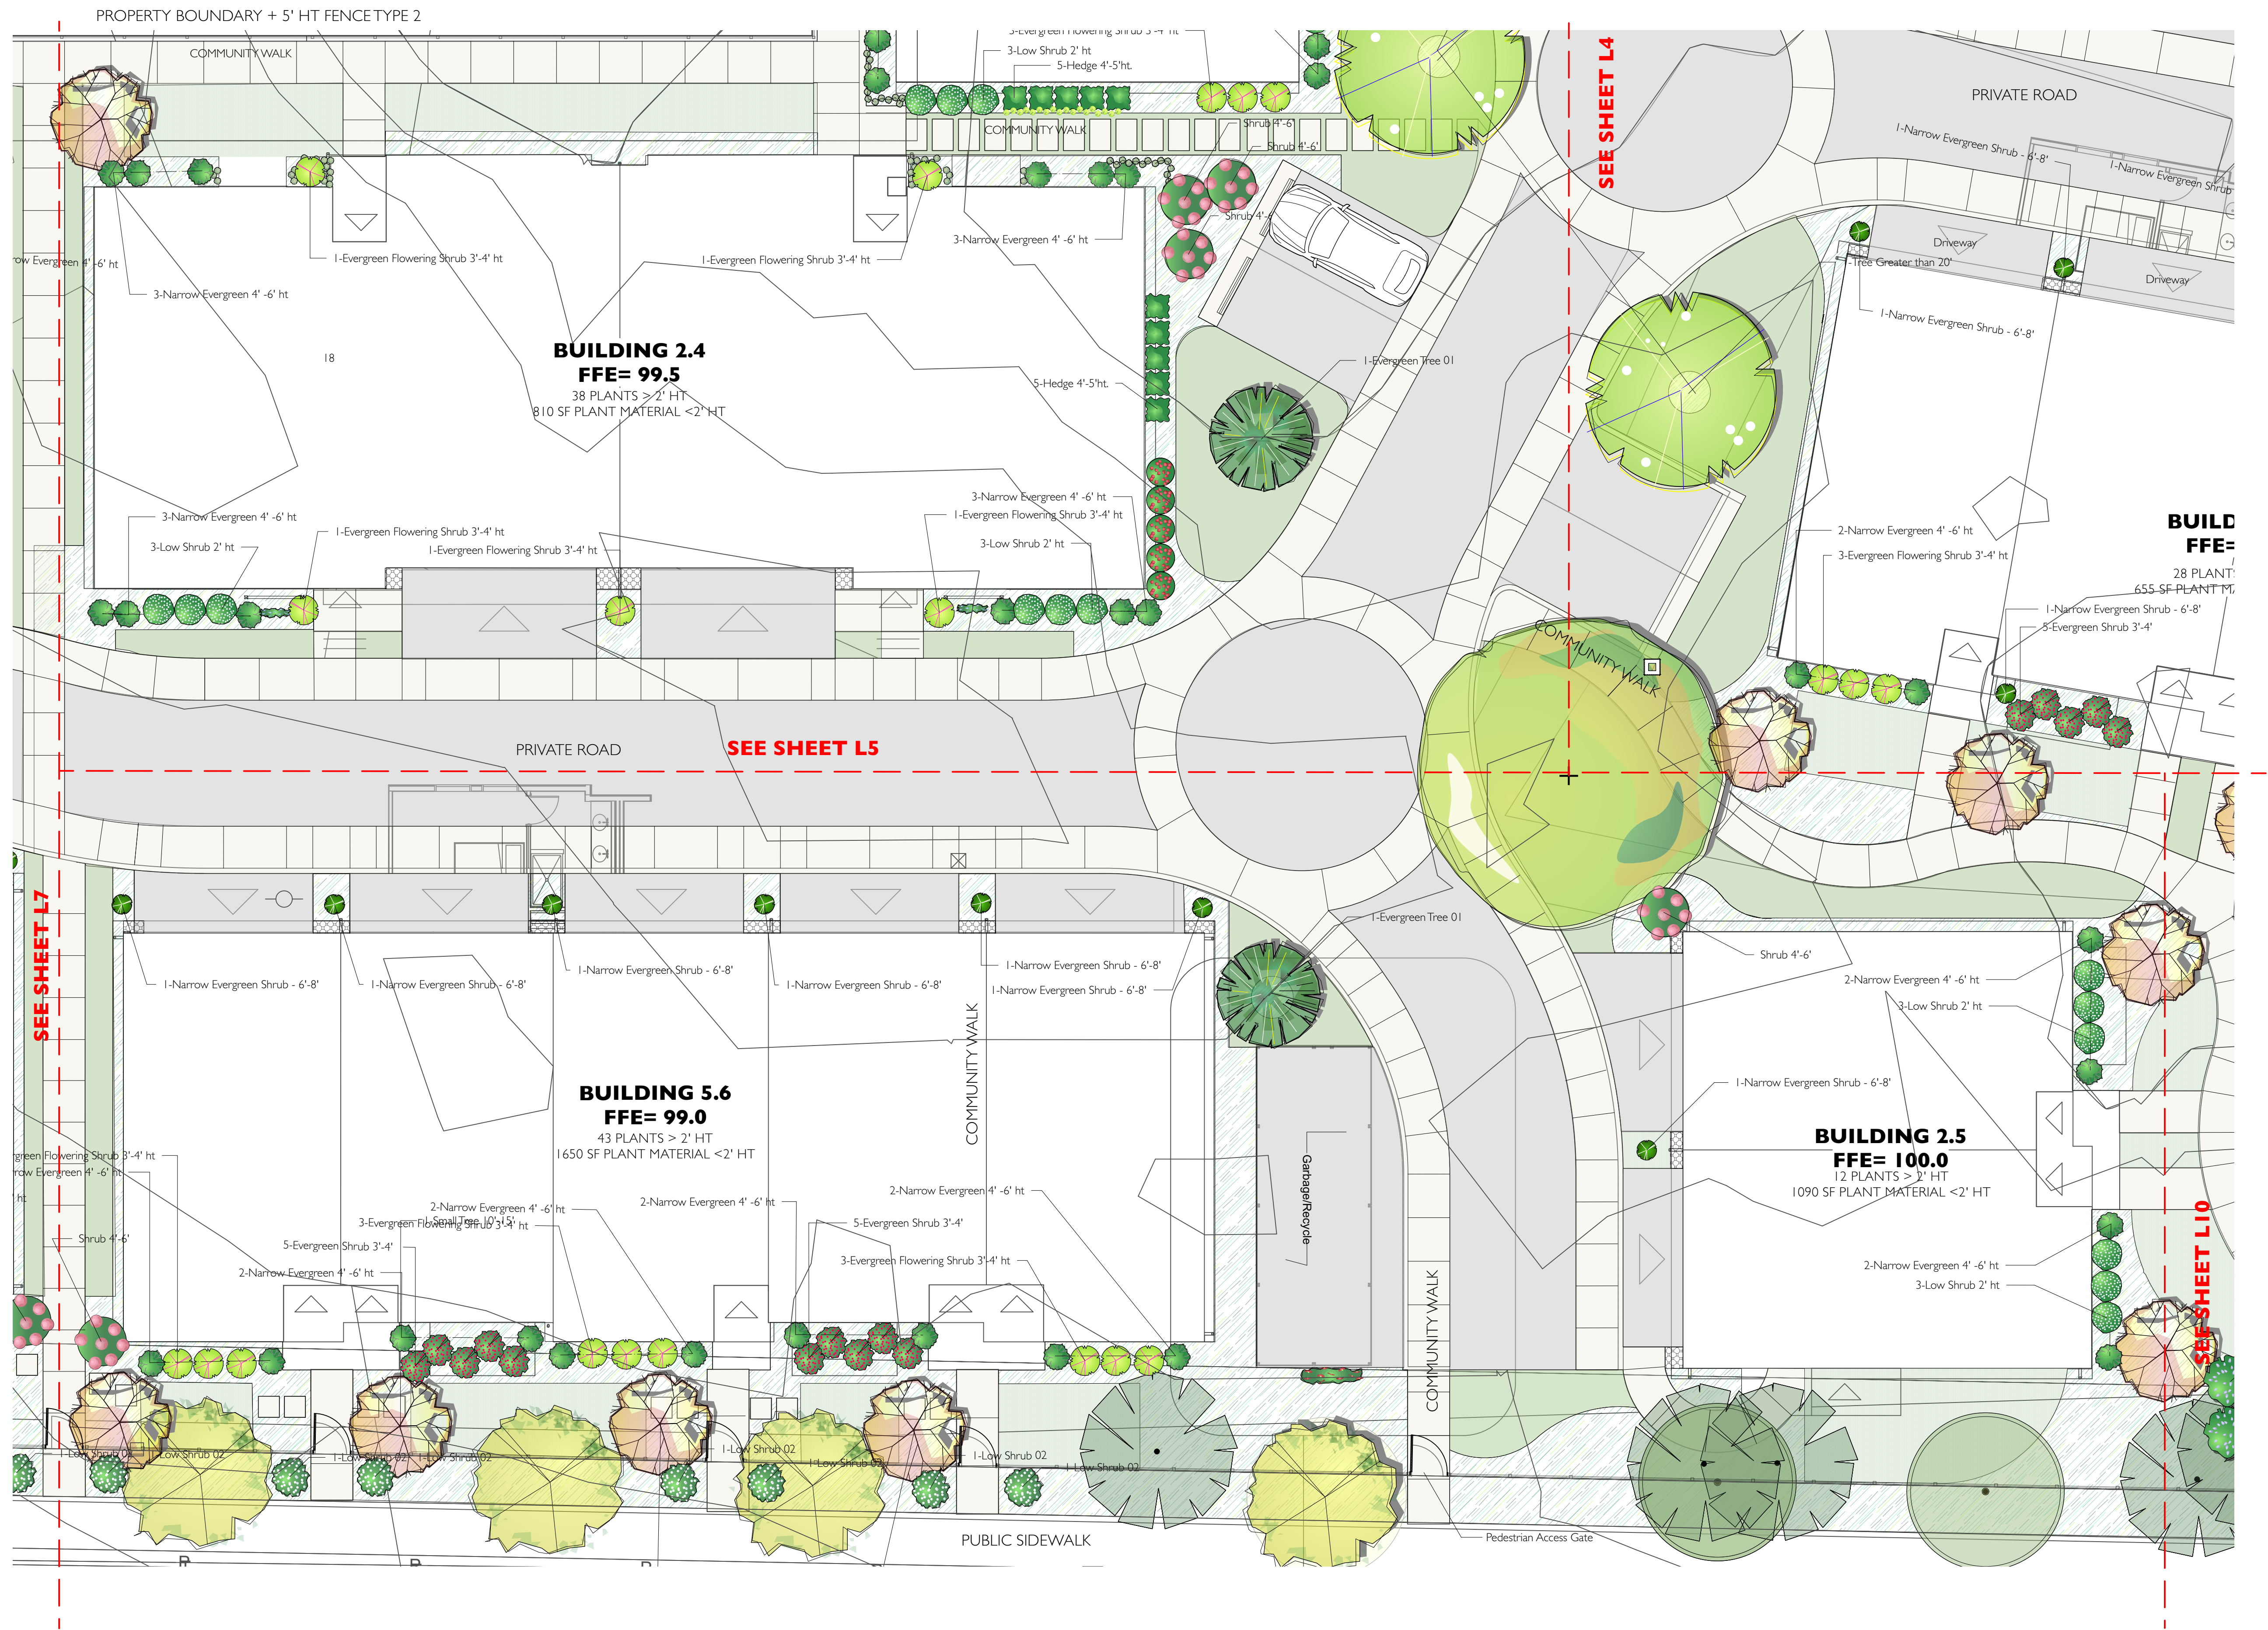
SHEET NUMBER:

L-5



0 10 15 20 25
SCALE: 1/8" = 1'-0"



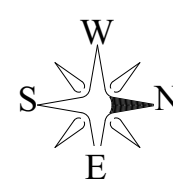

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REISSUE DATE: 09/13/23

PROJECT NAME:

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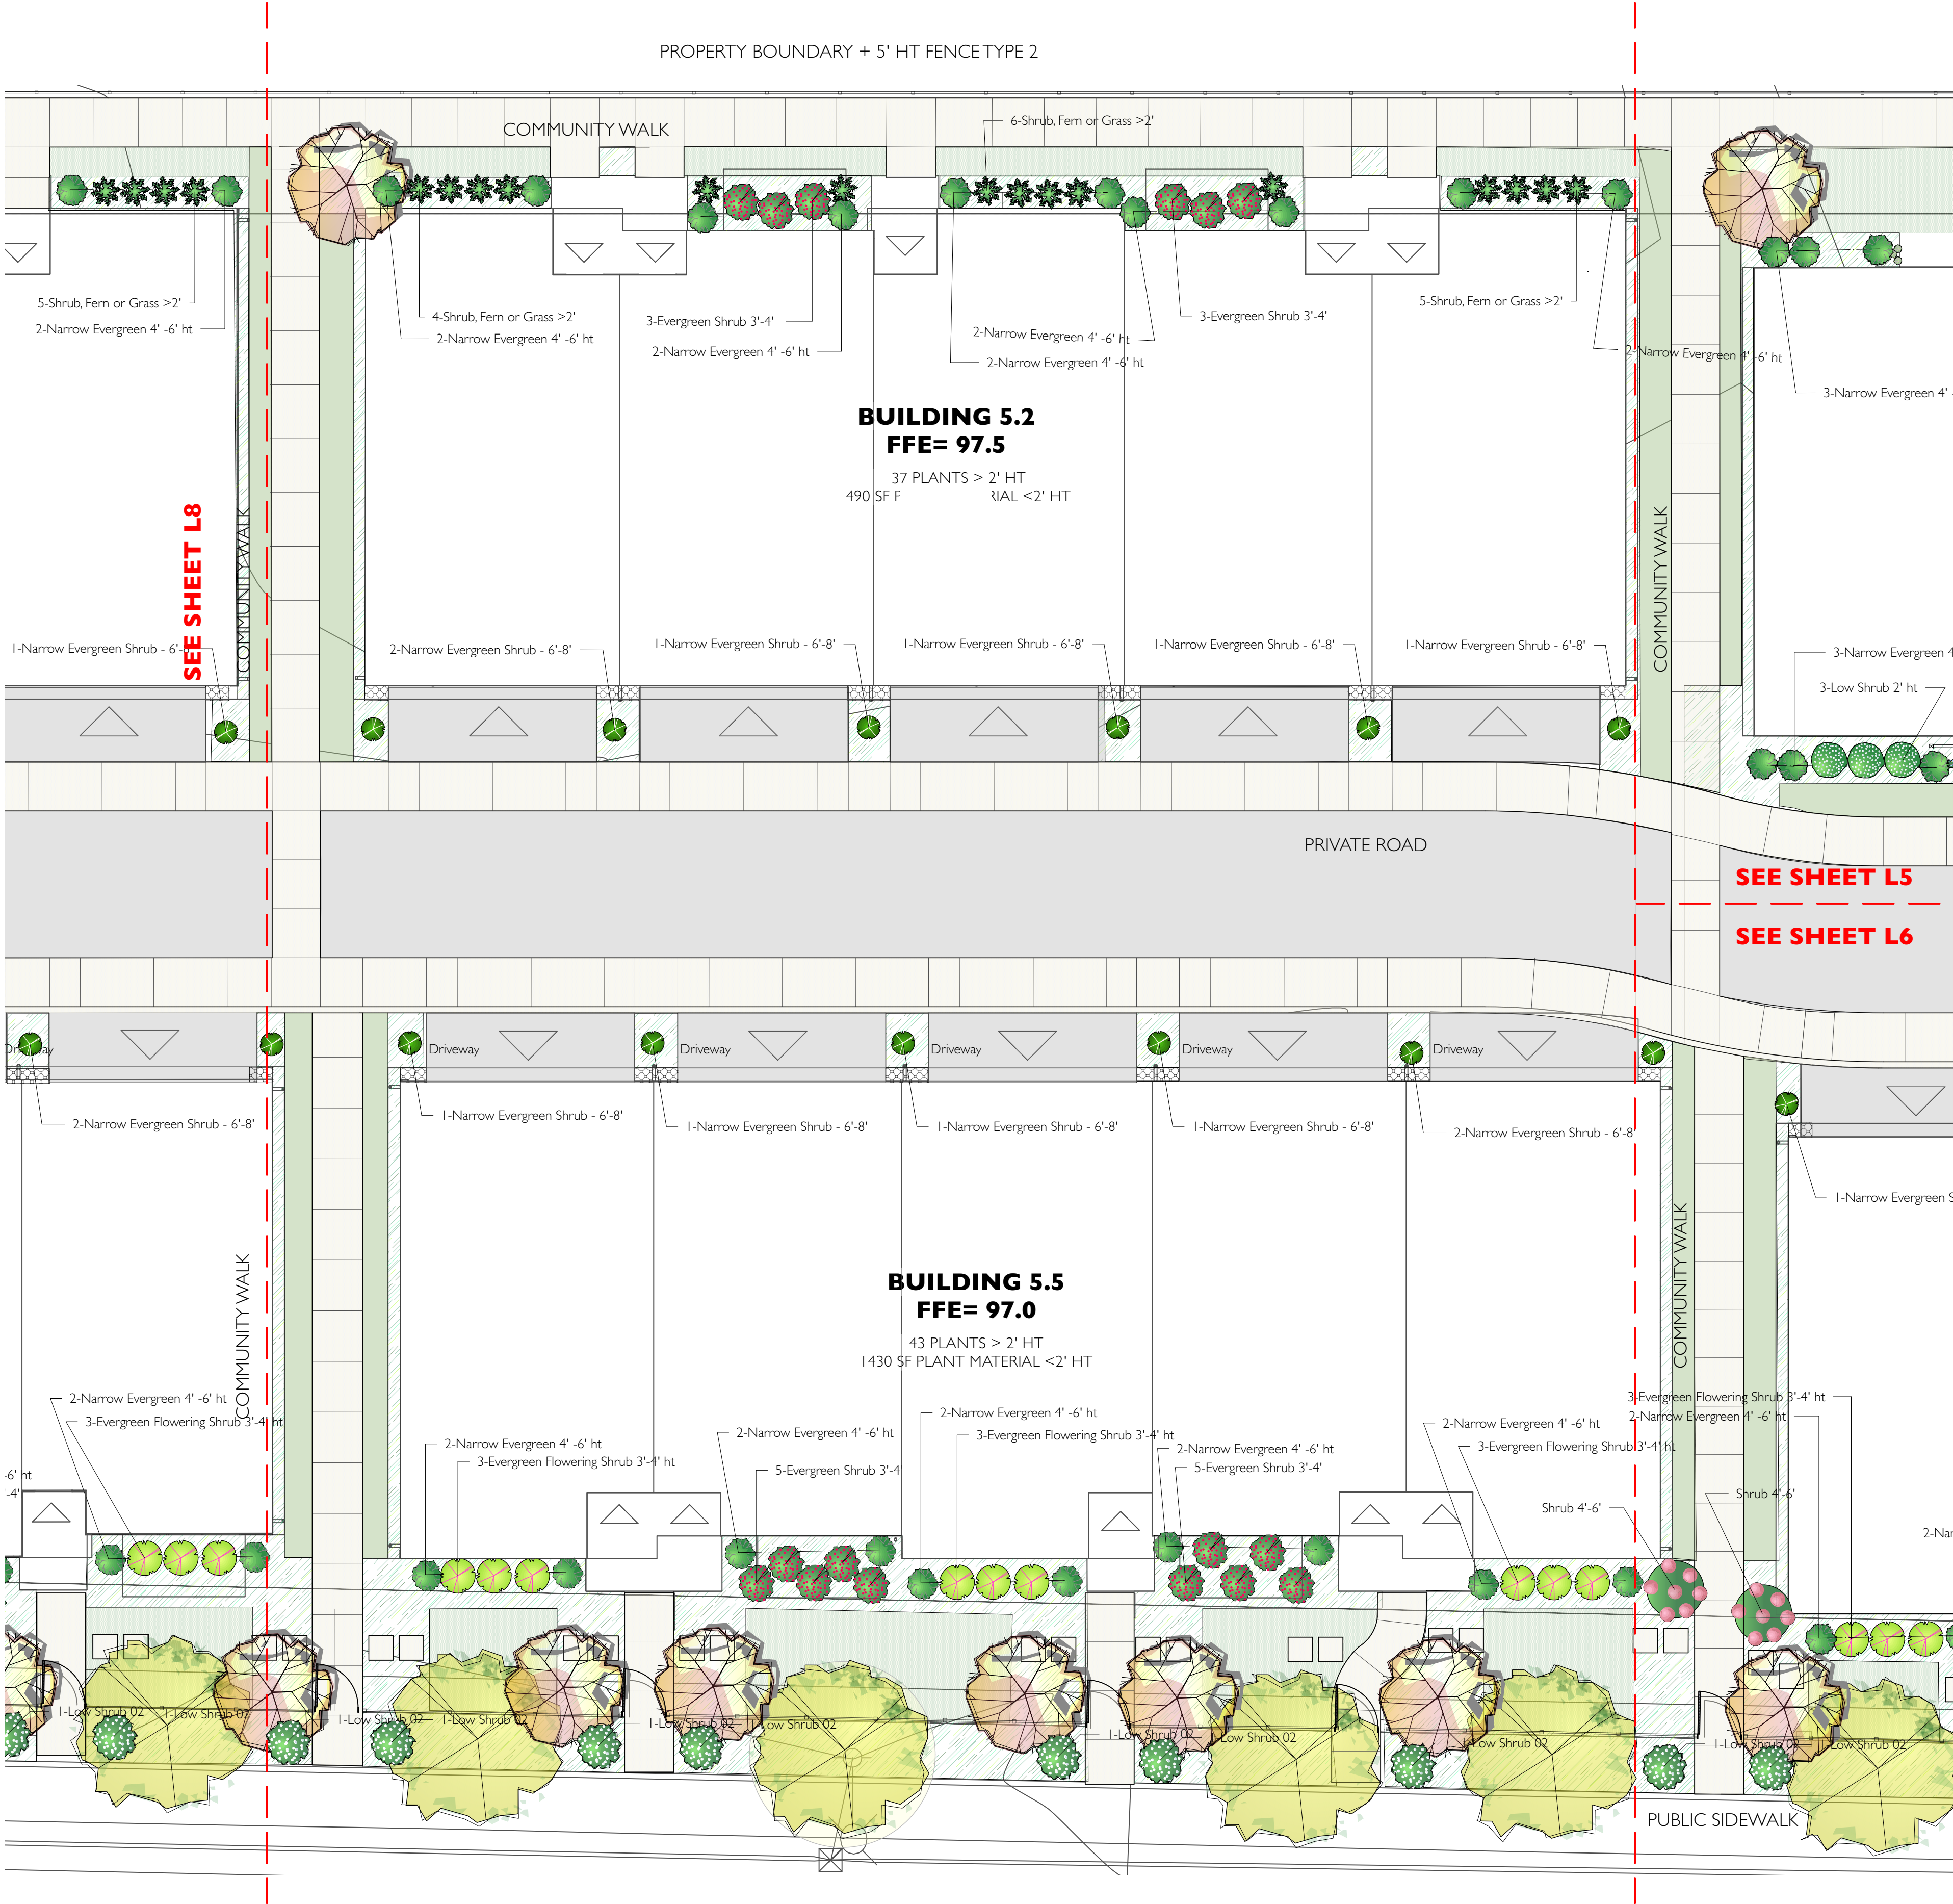
SHEET NAME:

**CONCEPTUAL
LANDSCAPE
PLAN**
BUILDING 2.5+ 5.6

SCALE: 1/8" = 1'-0"

SHEET NUMBER:

L-6



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office: 206-920-1323



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REISSUE DATE: 09/13/23

PROJECT NAME:

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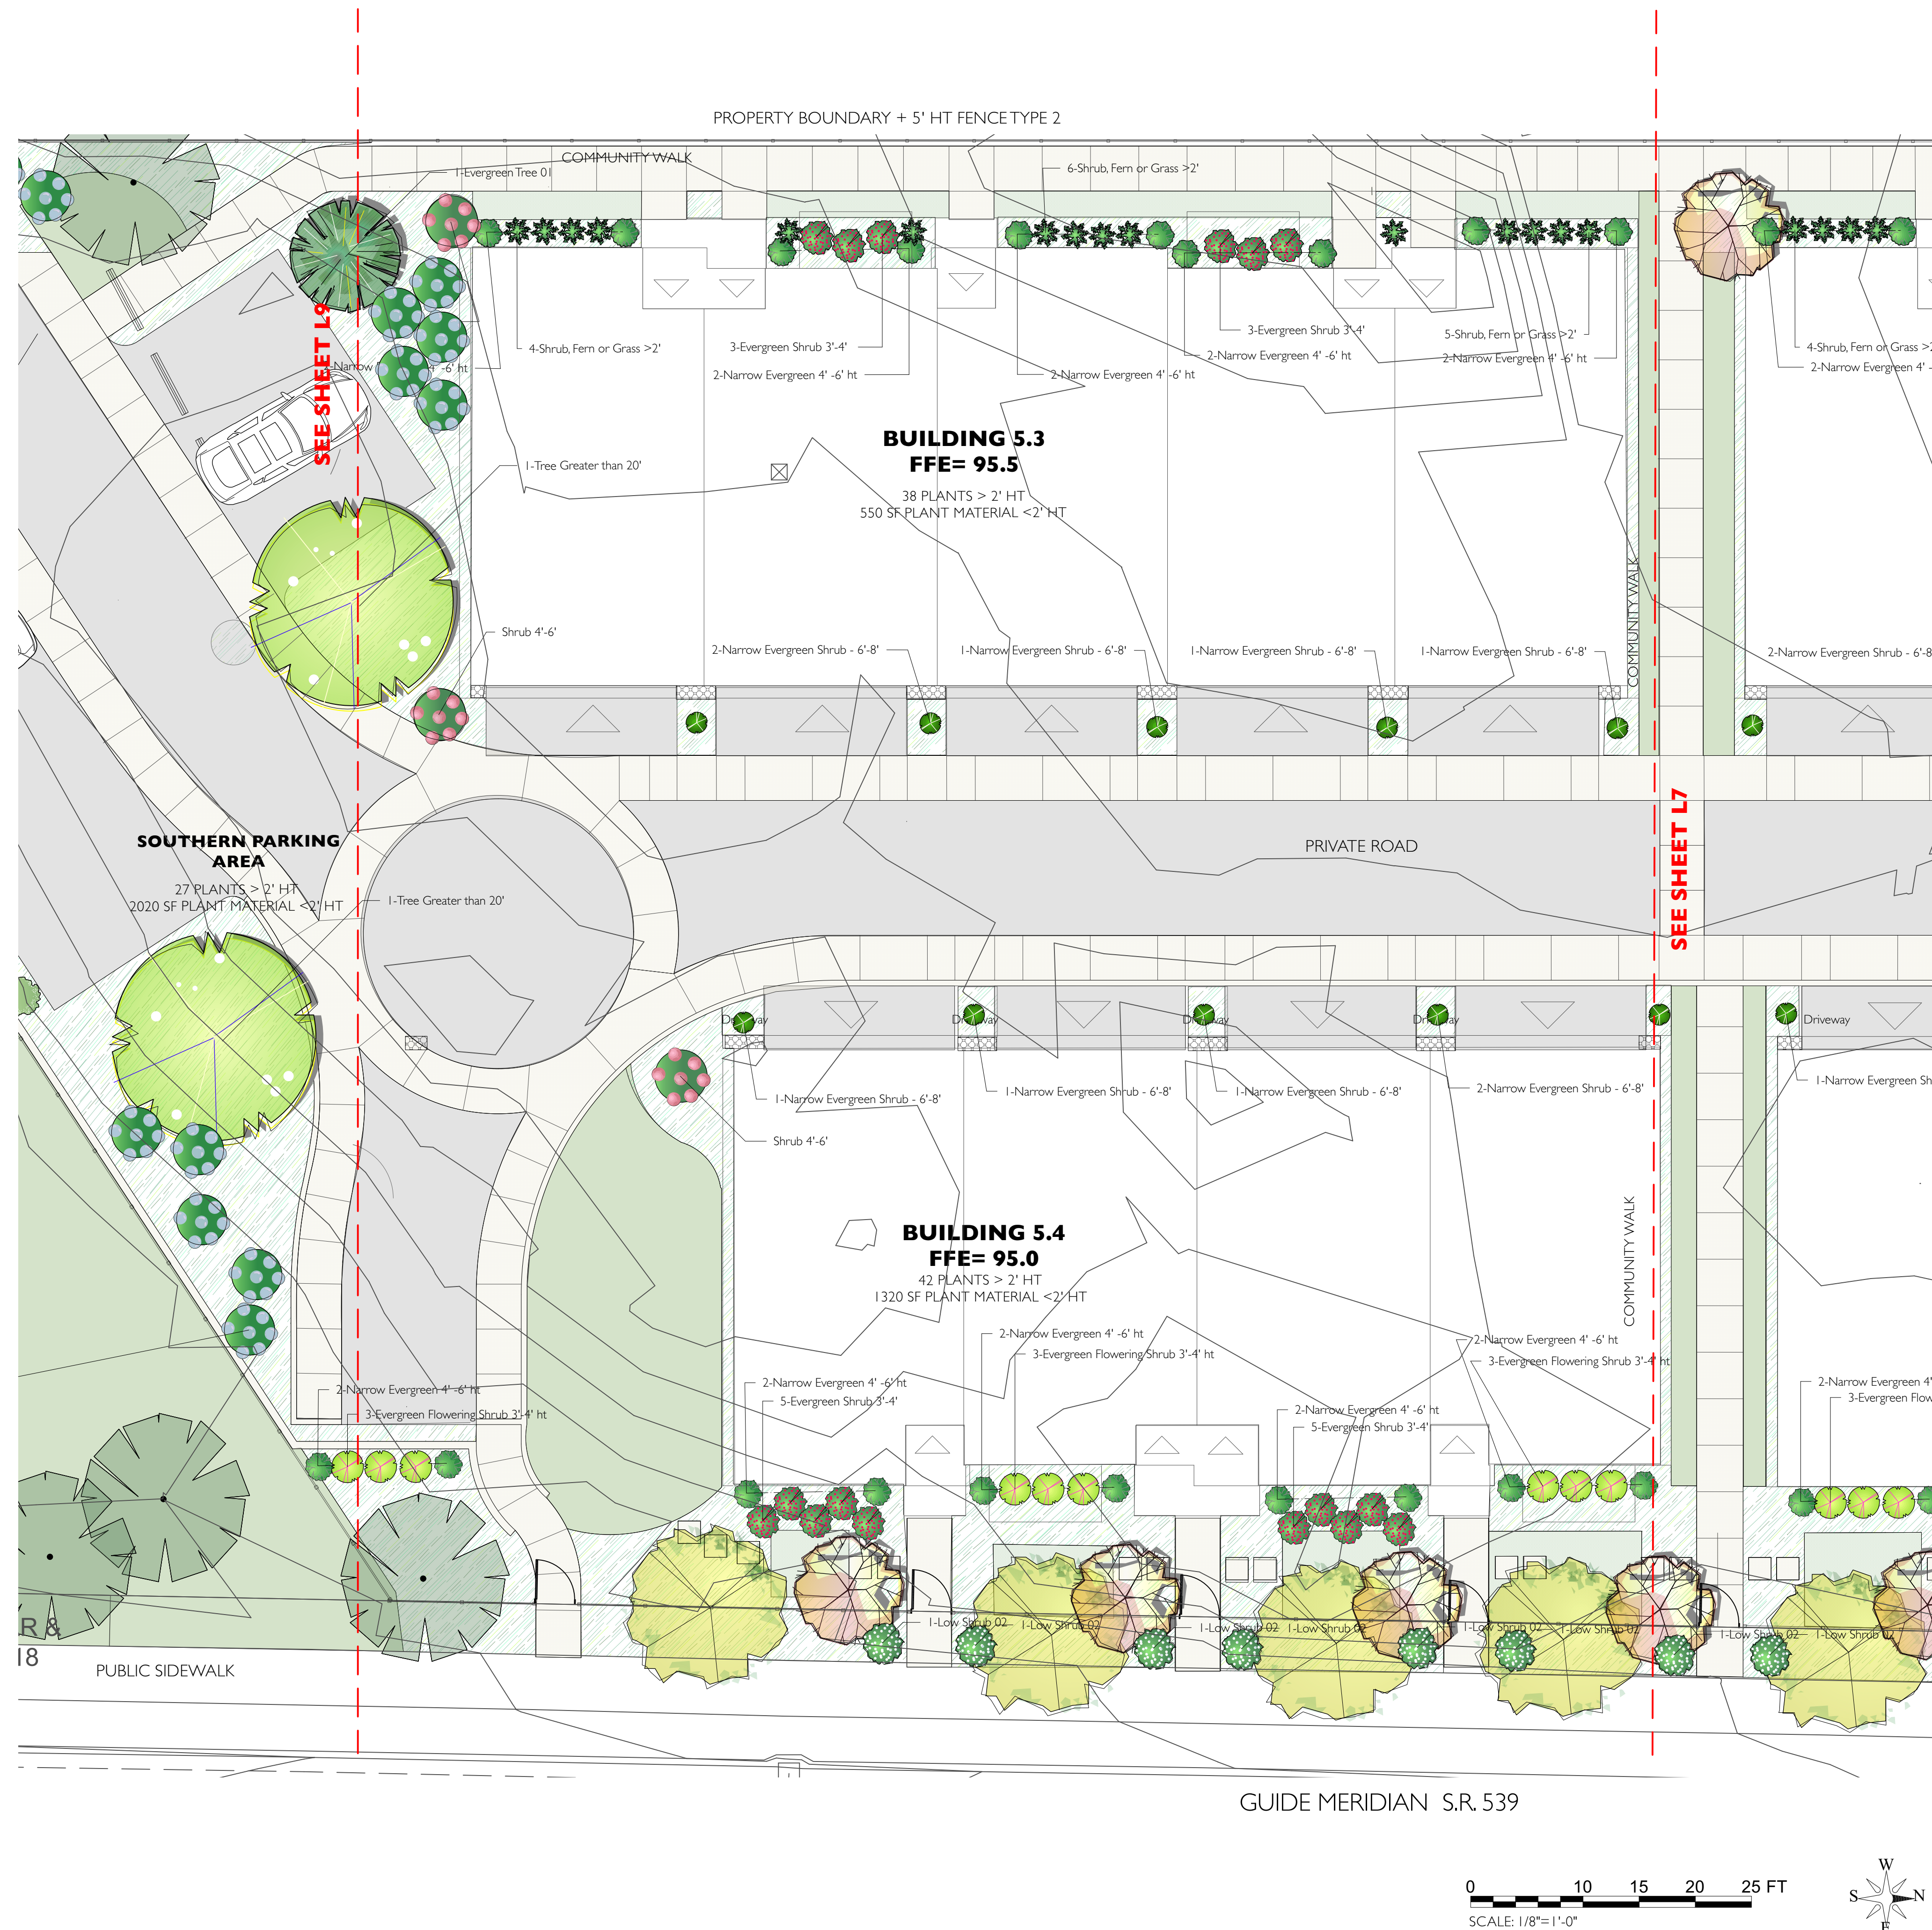
SHEET NAME:

CONCEPTUAL
LANDSCAPE
PLAN
BUILDING 5.2+ 5.5

SCALE: 1/8" = 1'-0"


SHEET NUMBER:

L-7



1 LANDSCAPE PLAN BUILDINGS 5.3 + 5.4
Scale: 1/8" = 1'-0"


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office: 206-920-1323

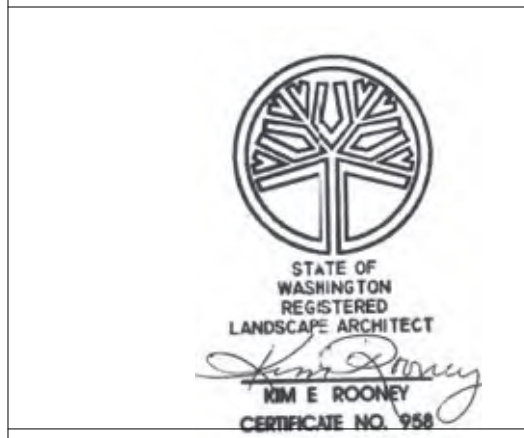

ISSUE DATE: 7/29/22
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REISSUE DATE: 04/17/23
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TOWNHOMES
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SHEET NAME:

CONCEPTUAL
LANDSCAPE
PLAN
BUILDINGS
5.3 + 5.4


SCALE: 1/8" = 1'-0"

SHEET NUMBER:

L-8



1 LANDSCAPE PLAN - SOUTH PARKING COMMON AREA
Scale: 1/8" = 1'-0"

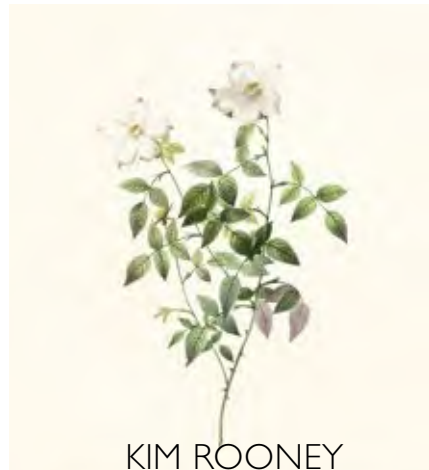

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ISSUE DATE: 7/29/22
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REISSUE DATE: 09/13/23

PROJECT NAME:

STREAM BELLINGHAM
TOWNHOMES
3726 Meridian Street
Bellingham, Washington 98225

SHEET NAME:

CONCEPTUAL
LANDSCAPE
PLAN
Southern Parking
Area

SCALE: 1/8" = 1'-0"

SHEET NUMBER:

L-9

NEIGHBORHOOD POCKET PARK- MICRO GATHERING AREAS
PLACES TO CONNECT WITH NEIGHBORS FRONT PORCH AND/OR BACK YARD SITE FURNISHING



Hammock or Swings on Modern Pergola



Hammock or Swings on Modern Pergola



Hammock or Swings on Modern Pergola



Adirondack Chairs

NEIGHBORHOOD POCKET PARK
OUTDOOR FITNESS AREA-ACTIVE PLACES FOR WELLNESS



Outdoor Fitness Equipment



Community Mail Box- Gatering Area




1 PARK
Scale: 1/8" = 1'-0"



Crushed Gravel Path



Tree Lined Gravel Path /adjacent Open Lawn

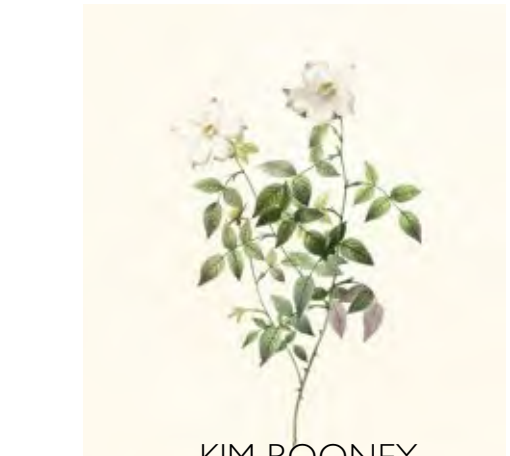

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STREAM BELLINGHAM
TOWNHOMES
3726 Meridian Street
Bellingham, Washington 98225

SHEET NAME:

CONCEPTUAL
LANDSCAPE
PLAN
COMMUNITY PARK

SCALE: 1/8" = 1'-0"

SHEET NUMBER:

L-10



1 GREEN FACTOR CALCULATION PLAN
Scale: 1" = 40'-0"

PLANTING - POSSIBLE PLANT MATERIAL LIST				
a. Groundcover or other plants less than 2' feet Tall = 19214 SF (GF SCORE 3842.8)				
Common Name	Botanic Name	Spacing	Native	Evergreen
Kinnickinick	Arctostaphylos uva-ursi	2' oc	X	X
Deer Fern	Blechnum spicant	2' oc	X	X
Low Oregon Grape	Mahonia repens	3' oc	X	X
Winter Creeper	Euonymus fort.	8" oc	X	X
Japanese Forest Grass	Hachenocloa	2' oc	X	X
Dwarf Candytuft	Iberis sempervirens	2' oc	X	X
Harbor Dwarf Nandina	Nandina dom.'Harb. Dwarf	2' oc	X	X
Periwinkle	Vinca Minor 'Bowles'	8" oc	X	X
Hosta varieties	Hosta	1'-3' oc	X	X
Sweet Woodruff	Galium odoratum	1 oc	X	X
b. Plants 2 feet or Taller = 695 Plants (GF SCORE 3336)				
Common Name	Botanic Name	Spacing	Native	Evergreen
Serviceberry	Amelanchier			
Tall Oregon Grape	Mahonia aquifolium	5'-6'	X	X
Sala	Gaultheria shallon Salal	4' oc	X	X
Nootka Rose	Rosa nutkana	5' oc	X	X
Sword fern	Polystichum munitum	3' oc	X	X
Red-flowering Currant	Ribes sanguineum	5'-6' oc	X	X
Snowberry	Symphoricarpos albus	5' oc	X	X
Evergreen Huckleberry	Vaccinium ovatum	5' oc	X	X
Mexican Orage	Choysia ternata	6' oc	X	X
Heavenly Bamboo	Nandina domestica	5' oc	X	X
Hydrangea	Hydrangea spp.	5'-6'	X	X
Knock Out® Shrub Rose	Rosa x 'Radrazz'	4'-5' oc	X	X
Miss Kim Lilac	Syringa x. pat. 'Miss Kim'	5' oc	X	X
Spirea	Spirea spp.	2'-6' oc	X	X
Carl Forester Grass	Calamagrostis x acutiflora	3' oc	X	X
Maiden Grass	Misacanthus spp.	3'-4' oc	X	X
Muhly Grass	Muhlenbergia capillaris	3' oc	X	X
Dwarf Fountain Grass	Pennisetum alopecuroides	3' oc	X	X
Rhododendron	Rhododendron spp.	5-6' oc	X	X
Azalea	Azalea spp.	2'-4' oc	X	X
Pieris	Pieris spp.		X	X
4. Vegetative Walls - 2- Vine of Garbage Encloser Fence (GF SCORE 40)				
Common Name	Botanic Name	Spacing	Native	Evergreen
Climbing Hydrangea	Hydrangea	20'	X	X
Evergreen Clematis	Clematis	15'	X	X
Asian Jasmine	Trachelospermum asia.	12'	X	X
Climbing Rose	Rosa 'Alchymist'	12'	X	X
Honeysuckle	Lonicera ciliosa	12'	X	X


SEE SHEET L1 FOR TREE GREEN FACTOR
2 MEDIUM TREES PER 8 PARKING SPACES

PLANTING LIST IS PRELIMINARY. FINAL PLANT LIST MAY INCLUDE BUT MAY NOT BE LIMITED TO THE ABOVE MATERIALS.


TOTAL GREEN FACTOR SCORE FOR PLANTING			
Building/Area	Plants >2'	Plants <2' SF	
2.1	37	575	
2.2	34	1145	
2.3	34	530	
2.4	38	810	
2.5	12	1090	
4.1	35	600	
4.2	39	670	
4.3	27	530	
4.4	27	410	
4.5	27	465	
4.6	28	655	
4.7	28	580	
5.1	39	1260	
5.2	37	490	
5.3	38	550	
5.4	42	1320	
5.5	43	1420	
5.6	43	1650	
Northern Parking	9	680	
Southern Parking	27	2020	
Community Park	63	1760	
Total	713	19210	

OVERALL PROJECT GREEN FACTOR SCORE				
Green Factor Landscape Element	Multiplier	Total	Sq. Ft.	GF Score
1. Landscaped Areas (select one of the following for each area):				
a. Landscape areas with soil depth of less than 24"	0.1			0
b. Landscape areas with soil depth of 24" or greater	0.8		50023	40018.4
c. Bioretention facility	1		6,500	6,000
2. Planting (credit for plants in landscaped areas above):				
a. Mulch, ground covers, or other plants less than two feet tall at maturity. For Detailed Break Down of Planting Credits, See Landscaped Areas Sheet (Sheets L2-L13)	0.2		19210	3842
b. Plants two feet or Taller at Maturity, calculated at 16' square feet per plant. For Detailed Break Down of Planting Credits, See Landscaped Areas Sheet (Sheets L2-L13)	0.3	713	11408	3422.4
c. Tree canopy for small trees in Bellingham List of Approved Street Trees or equivalent (canopy spread of 15') calculated at 50 sq. Ft. Per tree. (See Sheet L1)	0.3	54	2700	810
3. Tree canopy for medium trees in Bellingham List of Approved Street Trees or equivalent (canopy spread of 25') calculated at 150 sq. Ft. Per tree. (See Sheet L1)				
d. Tree canopy for large trees in Bellingham List of Approved Street Trees or equivalent (canopy spread of 30') calculated at 200 sq. Ft. Per tree. (See Sheet L1)	0.5	1	200	100
e. Tree canopy for preservation of "exceptional trees" or other large existing trees 6" or greater, calculated at 15 square feet per inch DBH (See Sheet L0)	0.8	65	21,945	17,556

Green Factor Landscape Element	Multiplier	Total	Sq. Ft.	GF Score
3. Green Roofs				
a. Over at least 2" and less than 4" of growth medium	0.4		0	0
b. Over at least 4" of growth medium	0.7		0	0
4. Vegetative Walls	0.7		0	0
5. Approved Water Feature	0.7		0	0
6. Permeable Paving				
a. Permeable Paving over at least 6" and less than 24" of soil or gravel	0.3		0	0
b. Permeable paving over at least 24" of soil or gravel	0.5		0	0
7. Structural Soils				
8. Bonuses				
a. Drought Tolerant or Native Plant Species	0.1	10	160	16
b. Landscaped areas where at least 50% of annual irrigation needs are met through the use of harvested rainwater	0.2		0	0
c. Landscaping in food cultivation	0.3		0	0
Total Lot Area:				
				179793
Total Green Factor Area				
				72604.8
Total Green Factor Area Score				
				0.4038



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ISSUE DATE: 7/29/22
REISSUE DATE: 01/13/23
REISSUE DATE: 04/17/23
REISSUE DATE: 09/13/23

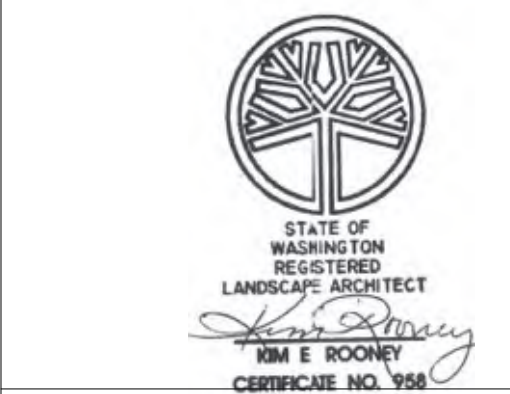PROJECT NAME:

STREAM BELLINGHAM
TOWNHOMES
3726 Meridian Street
Bellingham, Washington 98225

SHEET NAME:


GREEN
FACTOR
LANDSCAPE
ELEMENTS

SCALE: 1"=40'-0"


SHEET NUMBER:

L-11

TYPE 1 FENCE - SEE SHEET L1.B FENCE AND GATE PLAN

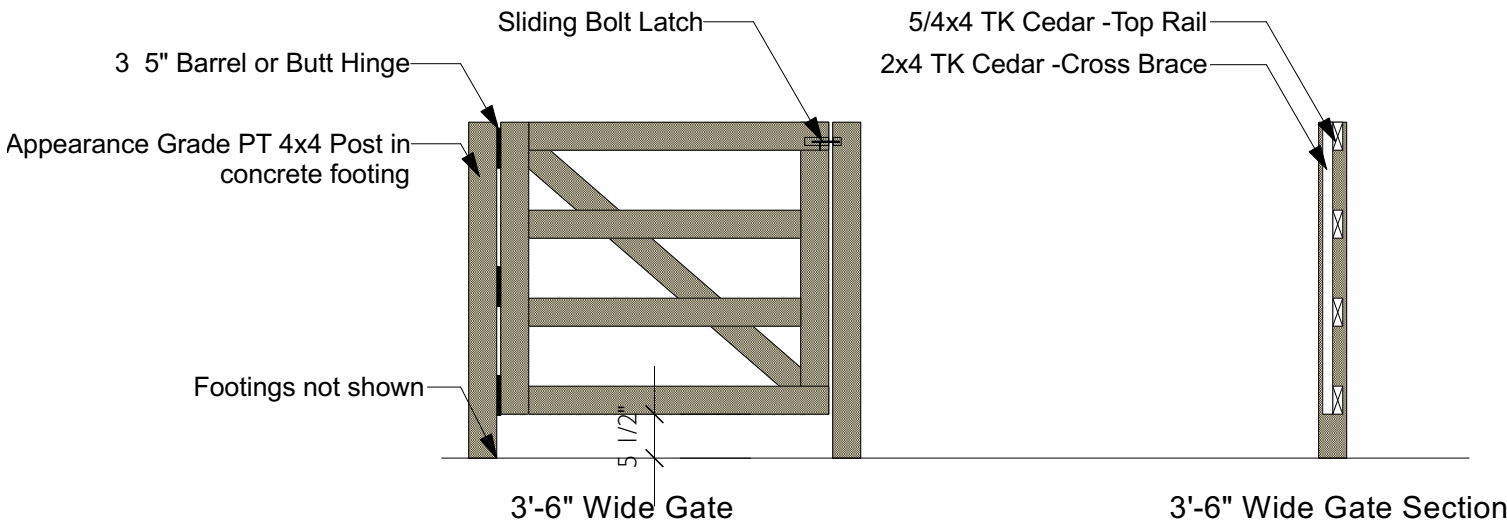


1 GATE FOR TYPE 1 - MERIDIAN GUIDE
Scale: 1/2" = 1'-0"

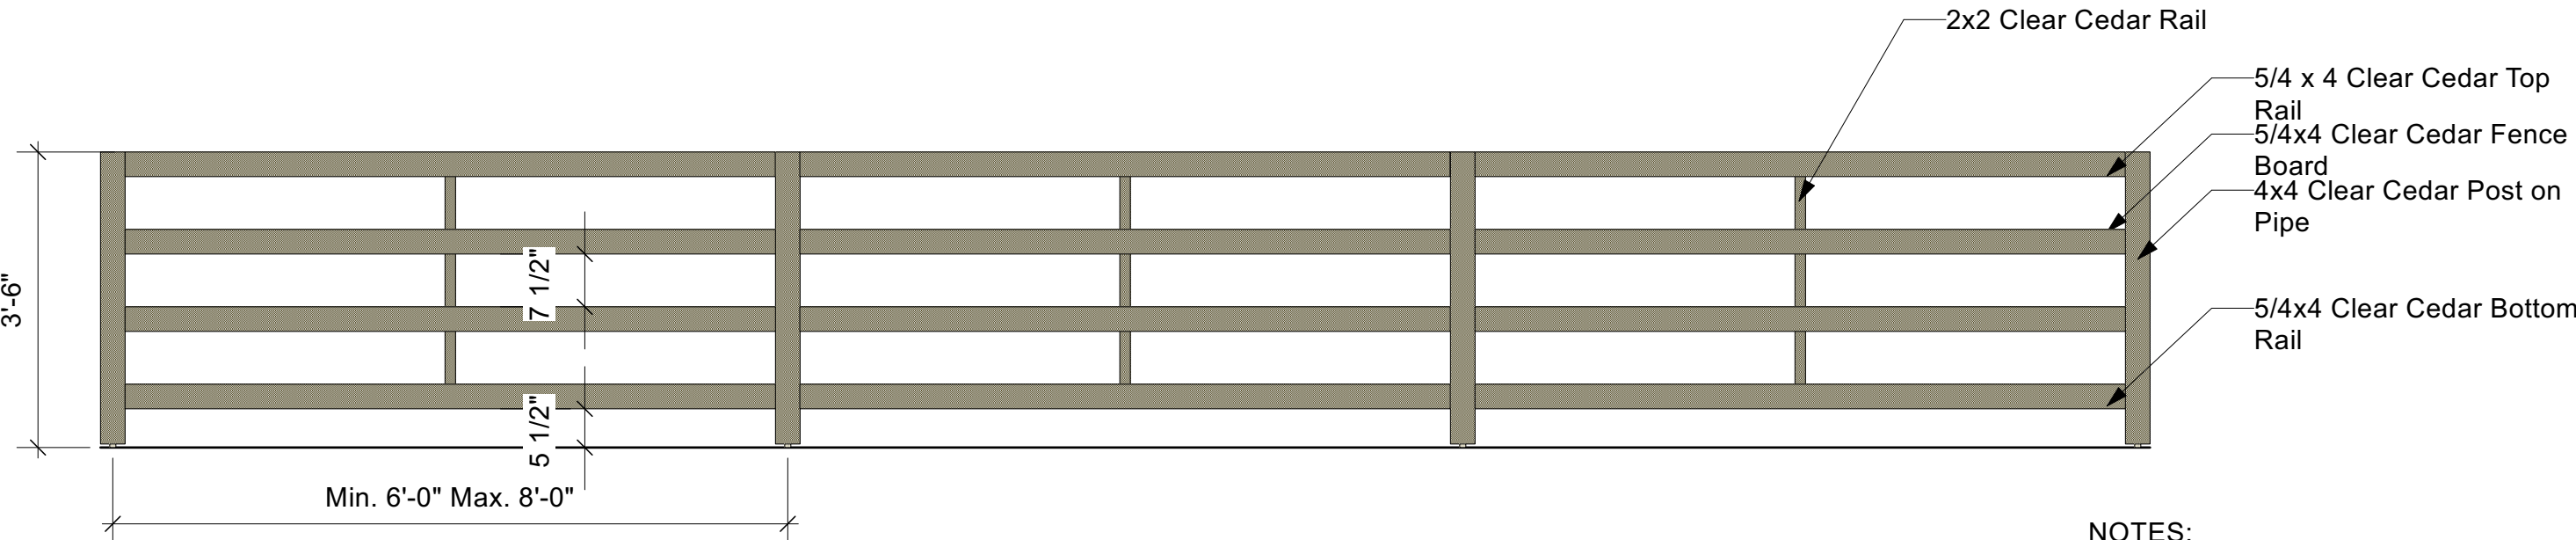


NOTES:
1. No fence to be placed between units
2. Visibility between 65-66%
3. Footings not shown

2 TYPE 1 FENCE - MERIDIAN GUIDE
Scale: 1/2" = 1'-0"

TYPE 2 FENCE - SEE SHEET L1.B FENCE AND GATE PLAN

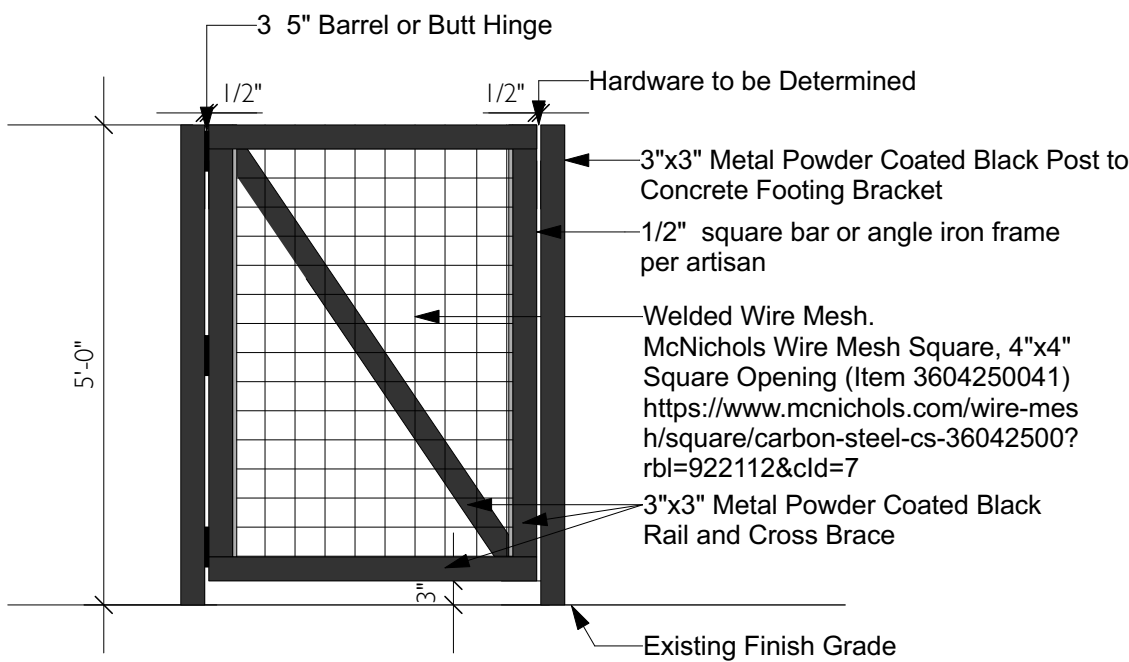

3 GATE FOR FENCE TYPE 2
Scale: 1/2" = 1'-0"

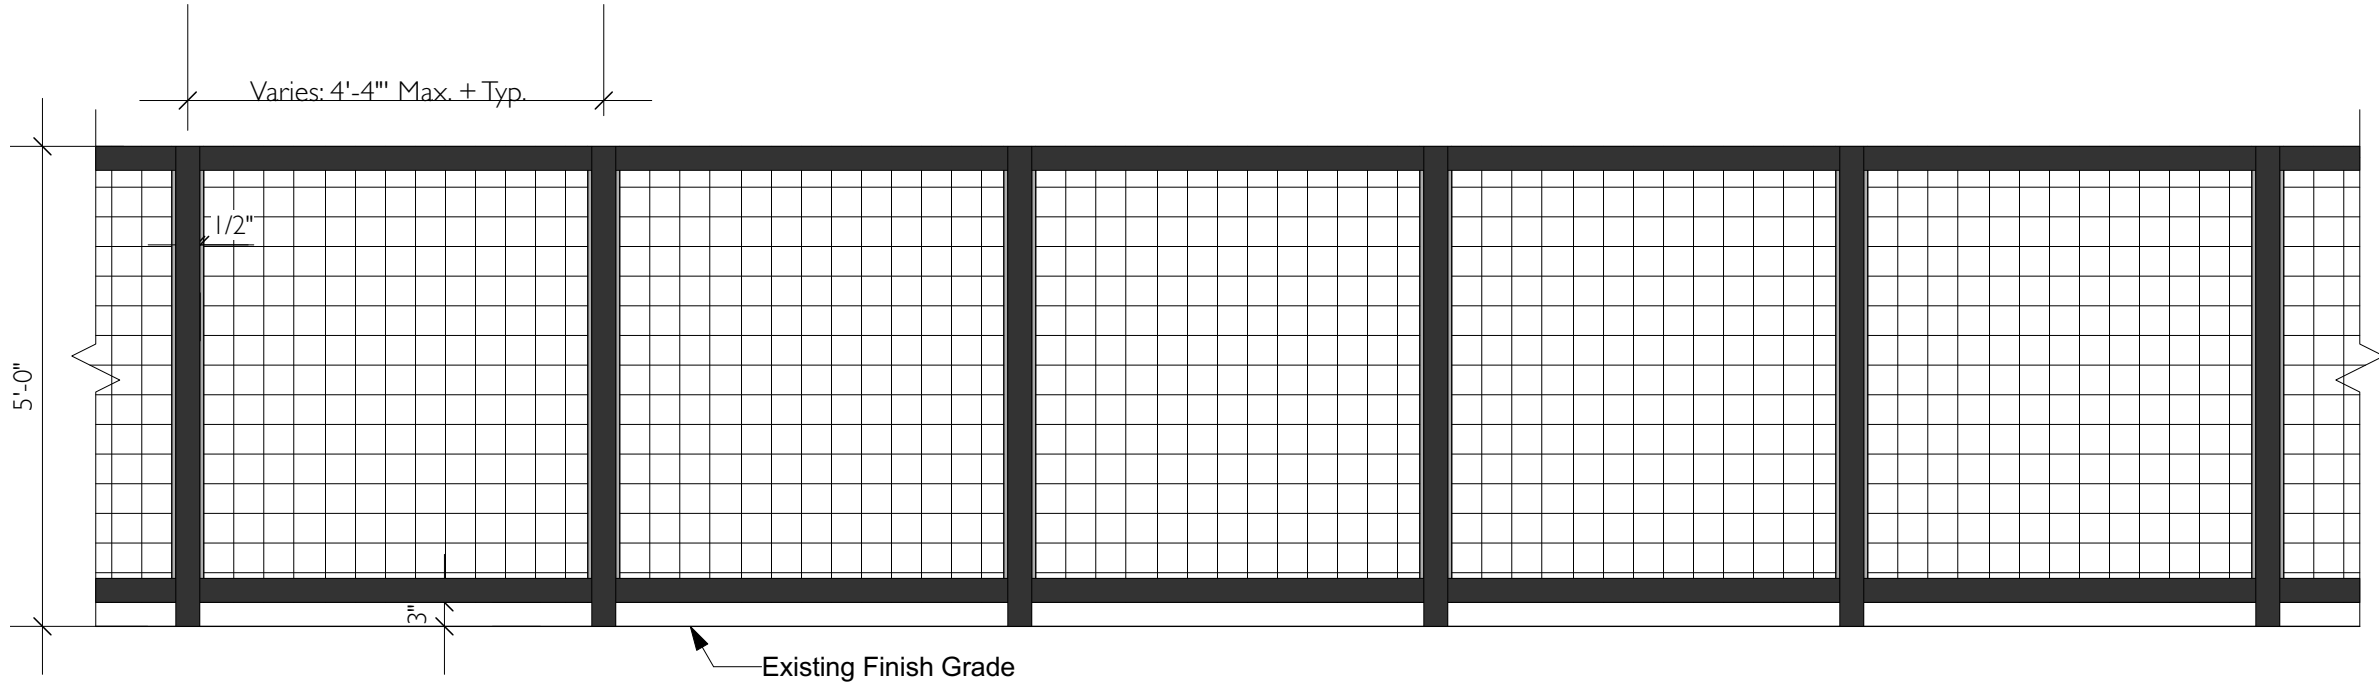

4 FENCE TYPE 2 ELEVATION
Scale: 1/2" = 1'-0"


PRECEDENT IMAGES



FENCE TYPE 1 - 42" HT
CEDAR FENCE
Meridian Fence



FENCE TYPE "2" 5' HT
WIRE MESH FENCE
Open Space Tract Fence

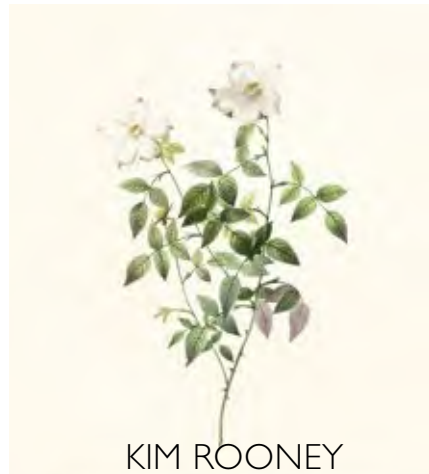

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SHEET NAME:

FENCE
ELEVATIONS +
DETAILS

SCALE: 1"=40'-0"

SHEET NUMBER:

L-12