

RESIDENTIAL DESIGN INTERIOR DESIGN **PLANNING**

5 Ringbolt Road Hingham, MA 02043 Tel: 617 - 347 - 6481

NEW SINGLE FAMILY RESIDENCE FOR: ROBERTS DESIGN CONSTRUCTION, INC.

49 Summit Ave, Hull MA




DRAWING TITLE	PERMIT SET			1. THE COI
COVER / SITE PLAN/DEMOLITION PLANS	5/23/25			OF ALL
-1 FOUNDATION PLAN	5/23/25			SUCH M 2. THE CO
-2 FOUNDATION DETAILS	5/23/25			IN THE I
-3 FIRST AND SECOND FLOOR FLOOR FRAMING PLANS	5/23/25			3. THE CO
A-4 THIRD FLOOR AND ROOF FRAMING PLANS	5/23/25			4. THE CO
A-5 BASEMENT AND FIRST FLOOR PLANS	5/23/25			UNCOVE UNANTI
A-6 SECOND FLOOR AND THIRD FLOOR PLANS	5/23/25			5. CAREFU
A-7 EXTERIOR ELEVATION & WINDOW SCHEDULE	5/23/25			AREAS ACCESS
A-8 EXTERIOR ELEVATIONS	5/23/25			6. CONTRA APPROF
A-9 BUILDING SECTIONS	5/23/25			7. FURNISI
A-10 BUILDING SECTION	5/23/25			SO THA OCCUR
A-11 BUILDING SECTION AND EXTERIOR DETAILS	5/23/25			8. PRESSU
				9. BUILT-U LAMINA
				ENGINE
				10. SEE STF MEMBEI
				LIMITED IN THIS
				GENERAL

- 1. THE CONTRACTOR SHALL DEMOLISH, REMOVE AND LEGALLY DISPOSE OF ALL ITEMS SHOWN DASHED ON THIS DRAWING SET AND ALL ITEMS SUCH MARKED. NO ITEMS SHALL BE BURIED ON SITE.
- 2. THE CONTRACTOR SHALL VERIFY ALL CONDITIONS AND DIMENSIONS IN THE FIELD PRIOR TO ANY WORK OR ORDERING OF ANY MATERIALS
- 3. THE CONTRACTOR SHALL PROVIDE SOUND AND DUST PROTECTION TO THE EXISTING HOUSE DURING CONSTRUCTION 4. THE CONTRACTOR SHALL NOTIFY THE ARCHITECT IF CONDITIONS
- UNCOVERED DURING DEMOLITION OR CONSTRUCTION ARE UNANTICIPATED OR APPEAR TO PRESENT A DANGEROUS CONDITION
- 5. CAREFULLY PROTECT ALL MATERIALS AND SURFACES ADJACENT TO
- AREAS IN WHICH WORK IS BEING DONE AND AREAS USED FOR ACCESS.
 6. CONTRACTOR TO PROVIDE AND DISPLAY "NO TRESPASSING" SIGNS IN
- APPROPRIATE LOCATIONS DURING CONSTRUCTION. 7. FURNISH AND PLACE ALL SUPPORTS, TEMPORARY AND PERMANENT SO THAT NO HORIZONTAL MOVEMENT OR VERTICAL SETTLEMENT
- 8. PRESSURE TREATED WOOD SHALL BE SOUTHERN PINE #1 9. BUILT-UP WOOD BEAMS SHALL BE CONSTRUCTED OF MICRO-LAM LAMINATED VENEER LUMBER (LVL) . SIZES AS INDICATED BY THE ENGINEERING SKETCHES, OR IN THIS DRAWING SET.
- 10. SEE STRUCTURAL ENGINEERING SKETCHES FOR ALL STRUCTURAL MEMBERS NOT CALLED OUT WITH-IN THIS DRAWING SET, INCLUDING BUT NOT LIMITED TO; LVL'S, STRUC. STEEL MEMBERS AND STRUCTURAL POSTS INDICATED IN THIS DRAWING SET.

- 11. CONNECTORS AND TIES SHALL BE AS MANUFACTURE BY SIMPSON STRONG-TIE, OR EQUAL. 12. LUMBER SHALL BE SPRUCE PINE FIR (S-P-F) #1 OR EQUAL
- WITH A MAX. MOISTURE CONTENT OF 19%. 13. ALL WINDOWS TO BE MARVIN ELEVATE WINDOWS AS SPECIFIED. U.N.O

AT INTERIOR. PROVIDE BASEBOARD AS SELECTED BY OWNER

- ALL TO BE INSTALLED IN ACCORDANCE WITH MANUFACTURERS INSTRUCTIONS. 14. ALL NEW INTERIOR WALLS TO RECEIVE ONE COAT BEN-MOORE LATEX PRIMER AND TWO COATS BEN MOORE LATEX FINISH (EGG SHELL) . ALL TRIM TO RECEIVE ONE COAT BEN-MOORE LATEX PRIMER AND 2 COATS GLOSS,
- 15. ALL EXTERIOR SIDING TO MATCH EXISTING CLAPBOARDS, 16. ALL EXTERIOR TRIM TO BE "KLEER" PVC TRIM BOARDS AND TO RECEIVE 1 COAT BENJAMIN MOORE PRIMER AND 2 COATS BEN-MORE EXT. PAINT
- 17. ALL MECH., ELECTRICAL AND PLUMBING SYSTEMS ARE DESIGN BUILD BY TRADE SUB-CONTRACTORS
- INT. WALLS TO BE; 2x4 STUDS AT 1'-4" O.C. WITH ONE LAYER OF 1/2" BLUE BOARD EACH SIDE. PROVIDE BASEBOARD AS SELECTED BY OWNER EXT. WALLS TO BE; 2x6 STUDS AT 1'-4" O.C. WITH ONE LAYER OF 1/2" BLUE BOARD

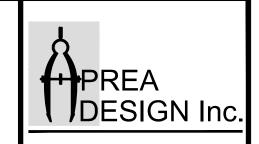

RESIDENTIAL DESIGN INTERIOR DESIGN PLANNING

5 Ringbo**l**t Road Hingham, MA 02043

Off: 781 - 875 - 3292 Cell: 617 - 347 - 6481 apreadesign.com

Consultants

Drawn By:

Checked By:

5/23/25

Revision Date By

Project:


NEW SINGLE FAMILY PRIVATE RESIDENCE ROBERTS DESIGN CONSTRUCTION, INC. AT:

49 SUMMIT AVE HULL, MA

1. ALL CONCRETE TO HAVE A MINIMUM COMPRESSIVE STRENGTH OF 3,500 PSI @ 28 DAYS, 3500 P.S.I. MIX (3/4" STONE, NO AIR ENTRAINMENT)

FOUNDATION NOTES:

- 2. 5/8" DIAMETER ANCHOR BOLTS WITH 3"x3"x1/4" PLATE WASHERS TO BE SET @ 36" O.C. AND NOT MORE THAN 1'-0" FROM ALL CORNERS & STEPS - BOLTS TO BE SET 8" INTO CONCRETE (MIN) . 3. NO FOOTINGS SHALL BE PLACED ON FROZEN SOIL.
- 4. ALL FOOTINGS MUST BEAR ON UNDISTURBED SOIL WITH A MINIMUM BEARING CAPACITY OF 1.5 TONS PER SQUARE FOOT. 5. ALL FOOTINGS SHALL BE PLACED A MINIMUM OF 4'-0" BELOW GRADE.
- 6. MAINTAIN FULL WIDTH OF FOOTING AT ALL STEPS, IF ANY 7. CONTRACTOR IS TO NOTIFY "DIG-SAFE" BEFORE BEGINNING ANY WORK. 8. ALL CONCRETE SLABS SHALL BE REINFORCED WITH
- 6x6 10/10 W.W.F. 9. ALL CONCRETE SLABS SHALL BE PLACED OVER 12" OF CRUSHED STONE WITH A 6 MIL. FIBER-GLASS REINFORCED POLY. VAPOR BARRIER PLACED
- DIRECTLY UNDER SLAB. 10. FOOTINGS AND FOUNDATION WALLS SHALL BE CONSTRUCTED IN CONFORMANCE WITH THE CURRENT EDITION OF THE MASSACHUSETTS STATE BUILDING CODE AS A MINIMUM REQUIREMENT.
- 1. FINISHED GRADES SHALL BE ARRANGED TO DIRECT SURFACE WATER AWAY FROM ALL FOUNDATION WALLS. THE FINISHED GRADE SHALL SLOPE A MINIMUM OF 1/2" PER FOOT FOR A DISTANCE OF AT LEAST SIX FEET
- FROM THE FACE OF ALL FOUNDATION WALLS. 12. TOP OF CONCRETE SLABS SHALL NOT VARY MORE THAN 3/16" OVER 10 FEET. 13. ALL FOUNDATION WALLS SHALL BE DAMPPROOFED FROM THE TOP OF FOOTING TO THE FINISHED GRADE OR WATERPROOFED IN AREAS WHERE A HIGH WATER TABLE OR OTHER SEVER SOIL-WATER CONDITIONS ARE KNOWN TO EXIST. (OR AS INDICATED)
- 4. THE SPACE BETWEEN THE EXCAVATION AND THE FOUNDATION WALL SHALL BE BACKFILLED WITH THE SAME MATERIAL USED FOR FOOTINGS, UP TO A HEIGHT OF ONE FOOT ABOVE THE FOOTING FOR WELL-DRAINED SITES, OR 1/2 THE TOTAL BACKFILL HEIGHT FOR POORLY DRAINED SITES. THE REMAINDER OF THE EXCAVATED AREA SHALL BE BACKFILLED WITH THE SAME TYPE OF SOIL AS WAS REMOVED DURING EXCAVATION. THE BACKFILL SHALL BE PLACED IN SIX TO EIGHT INCH COMPACTED LAYERS.
- 5. BACKFILL ADJACENT TO THE WALL SHALL NOT BE PLACED UNTIL THE WALL HAS SUFFICIENT STRENGTH AND HAS BEEN ANCHORED TO THE FLOOR OR HAS BEEN SUFFICIENTLY BRACED TO PREVENT DAMAGE BY BACKFILL.
- 16. A 6-MIL, FIBER-GLASS REINFORCED, POLY VAPOR BARRIER WITH JOINTS LAPPED LAPPED LESS THAN 6", SHALL BE PLACED BETWEEN THE CONCRETE FLOOR BASE COURSE OR PREPARED SUB-GRADE.
- 17. ALL STEEL REINFORCING SHALL BE A.S.T.M. A615, GRADE 60.
- 18. ALL FILL FOR SLABS SHALL BE CLEAN, GRANULAR MATERIAL AND SHALL BE COMPACTED TO NOT LESS THAN 95% OF MAXIMUM DRY DENSITY PER A.S.T.M. DI557. FILL SHALL BE PLACED AND COMPACTED IN 12" LAYERS MAXIMUM. LESS THAN 6", SHALL BE PLACED BETWEEN THE CONCRETE FLOOR SLAB AND THE

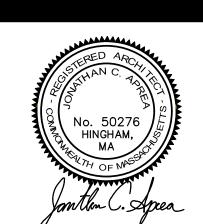

Drawing Title:


FOUNDATION PLAN


Scale: As Noted

Drawing Number:


Set: CONSTRUCTION

IMPORTANT STRUCTURAL ENGINEERING NOTE: FRAMING MEMBER SIZES NOTED WITH-IN THIS DRAWING SET ARE INDICATED FOR DESIGN INTENT ONLY; IT IS THE RESPONSIBILITY OF THE OWNER/CONTRACTOR TO OBTAIN ADDITIONAL STRUCTURAL ENGINEERING, AND STRUCTURAL ENGINEERING REVIEW, FOR ALL FRAMING COMPONENTS INDICATED WITH-IN THIS DRAWING SET INCLUDING "LATERAL" OR WIND DESIGN LOADS. AND SHALL MEET OR EXCEED ALL APPLICABLE BUILDING CODE REQUIREMENTS.

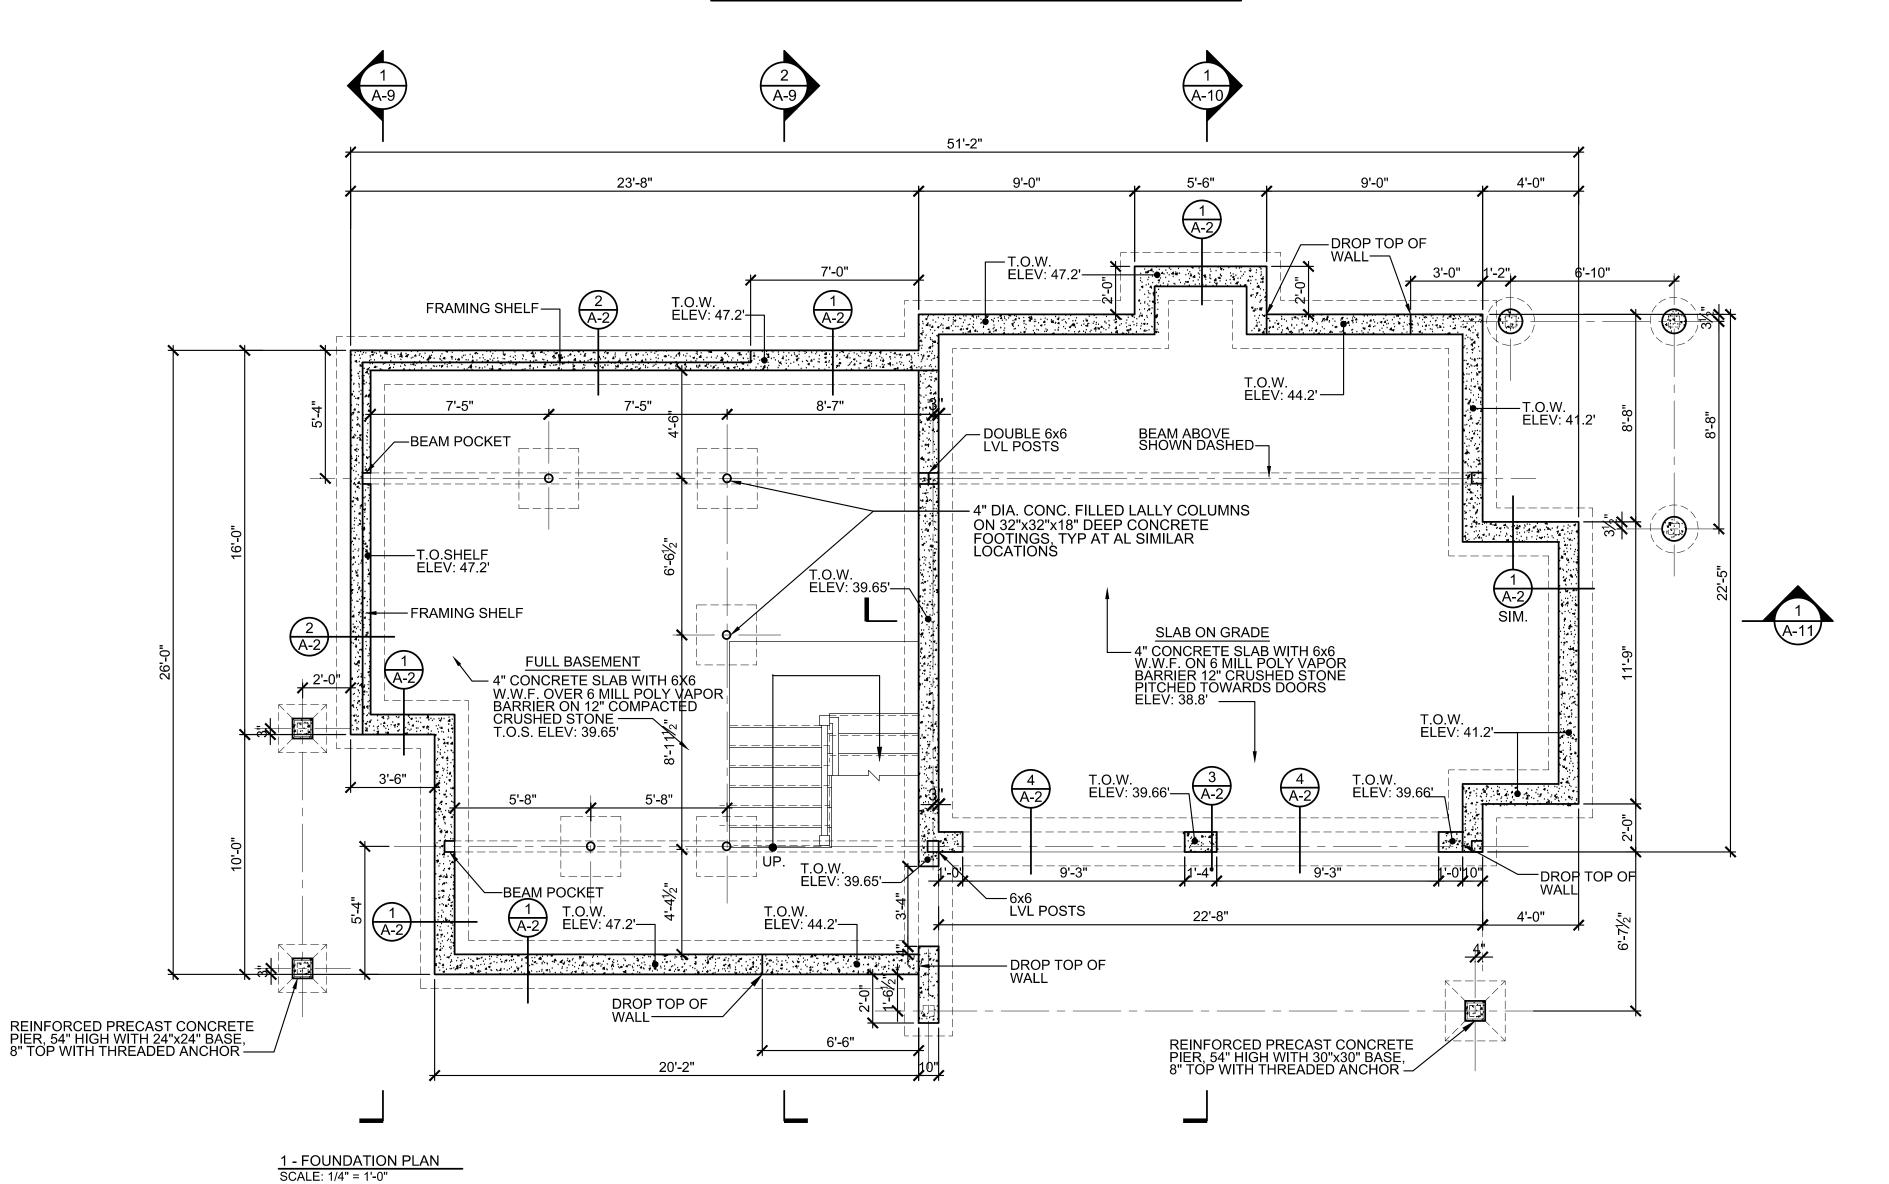

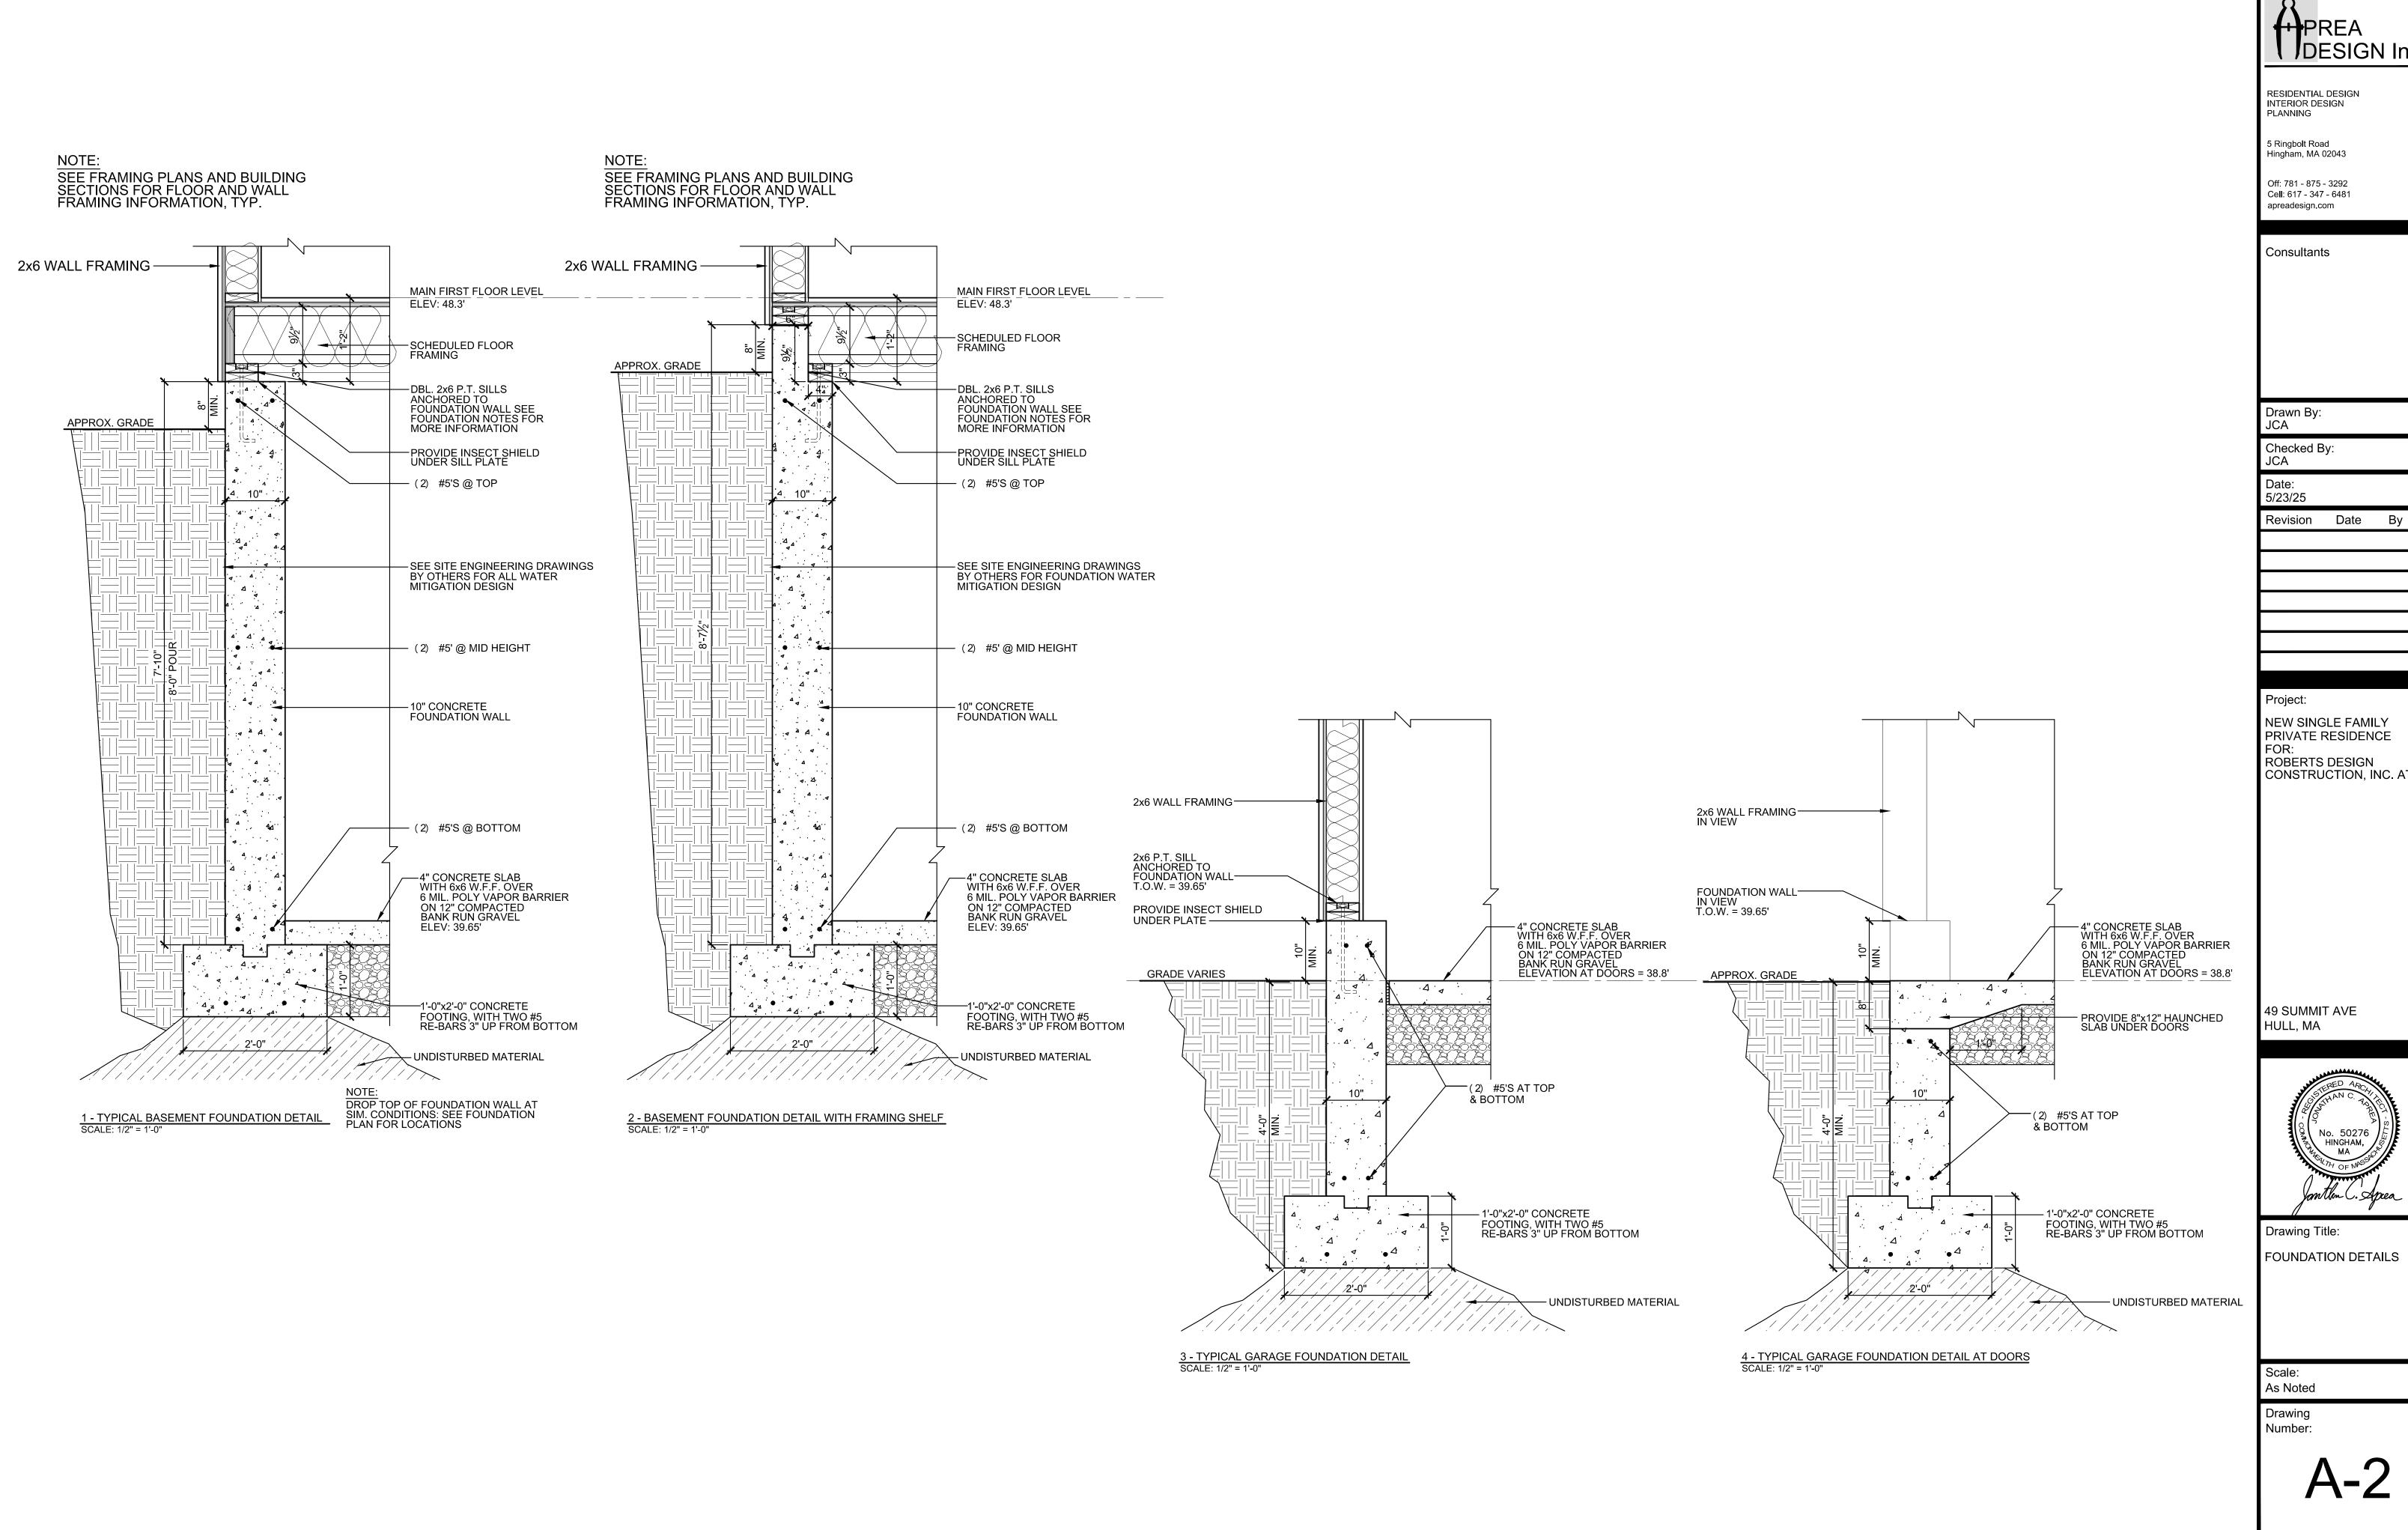



NEW SINGLE FAMILY PRIVATE RESIDENCE ROBERTS DESIGN CONSTRUCTION, INC. AT:

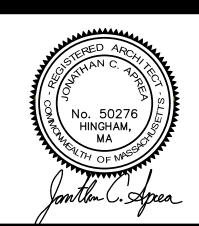


FOUNDATION DETAILS


Set: CONSTRUCTION

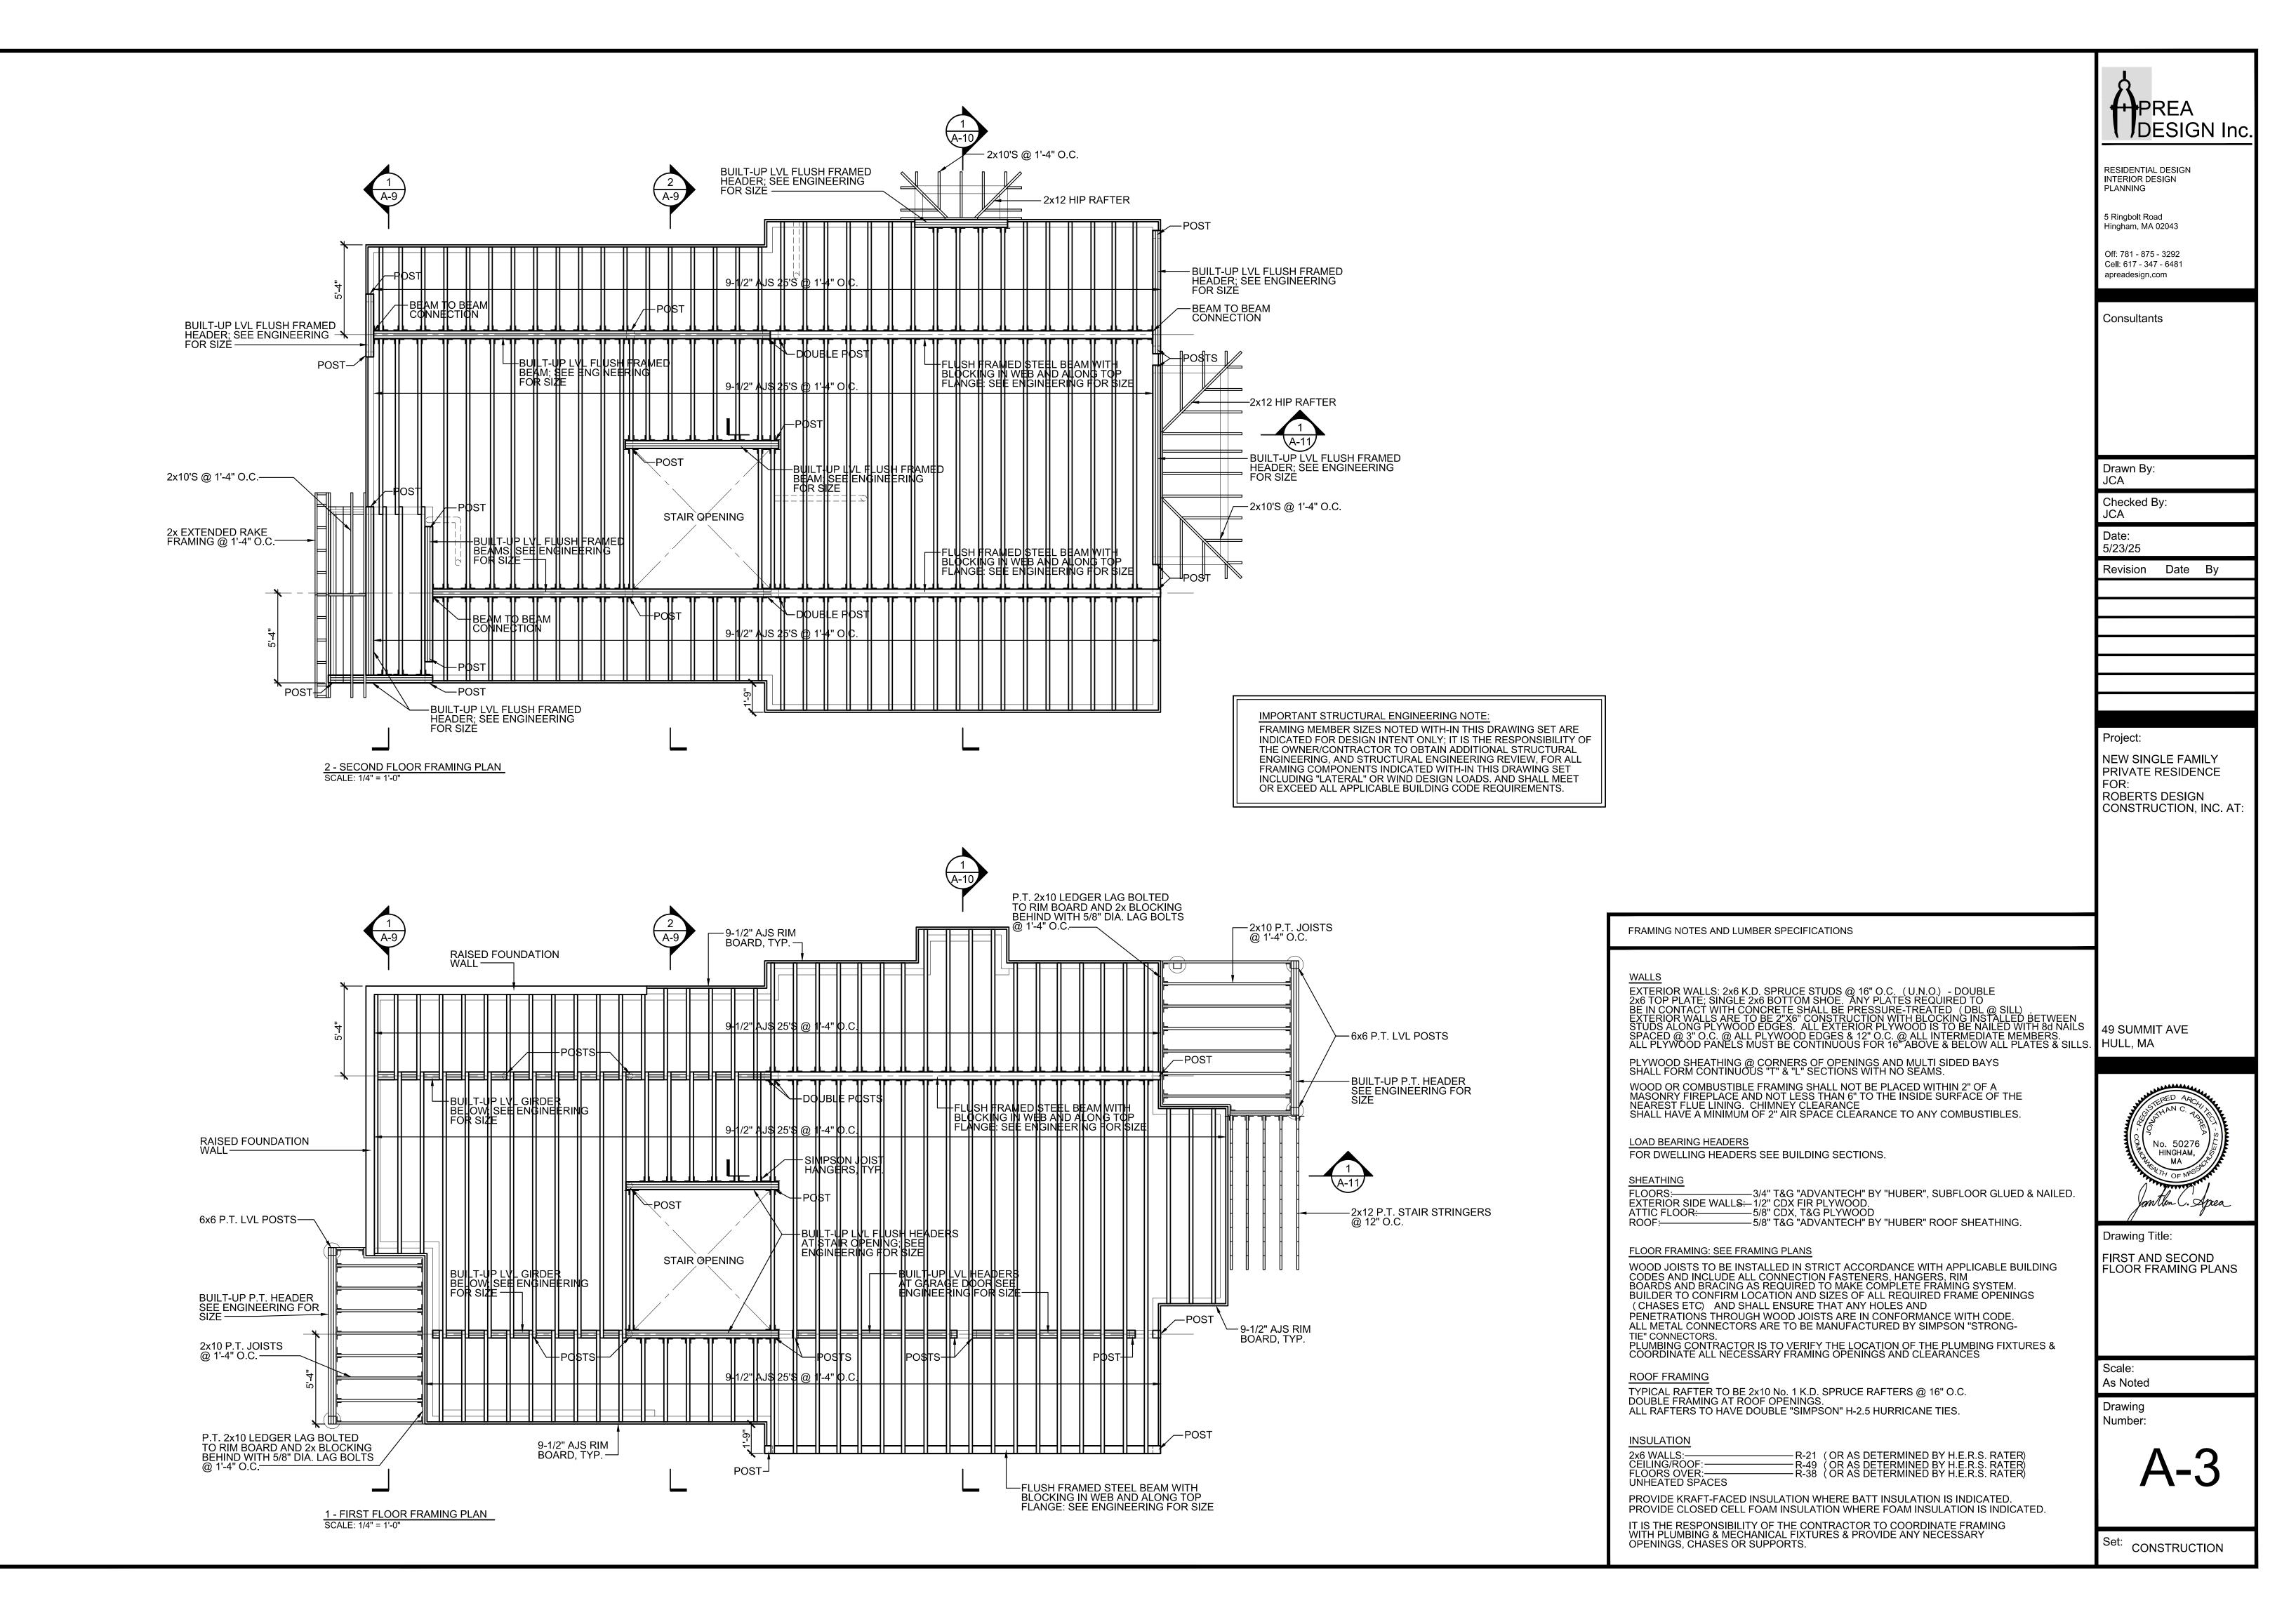

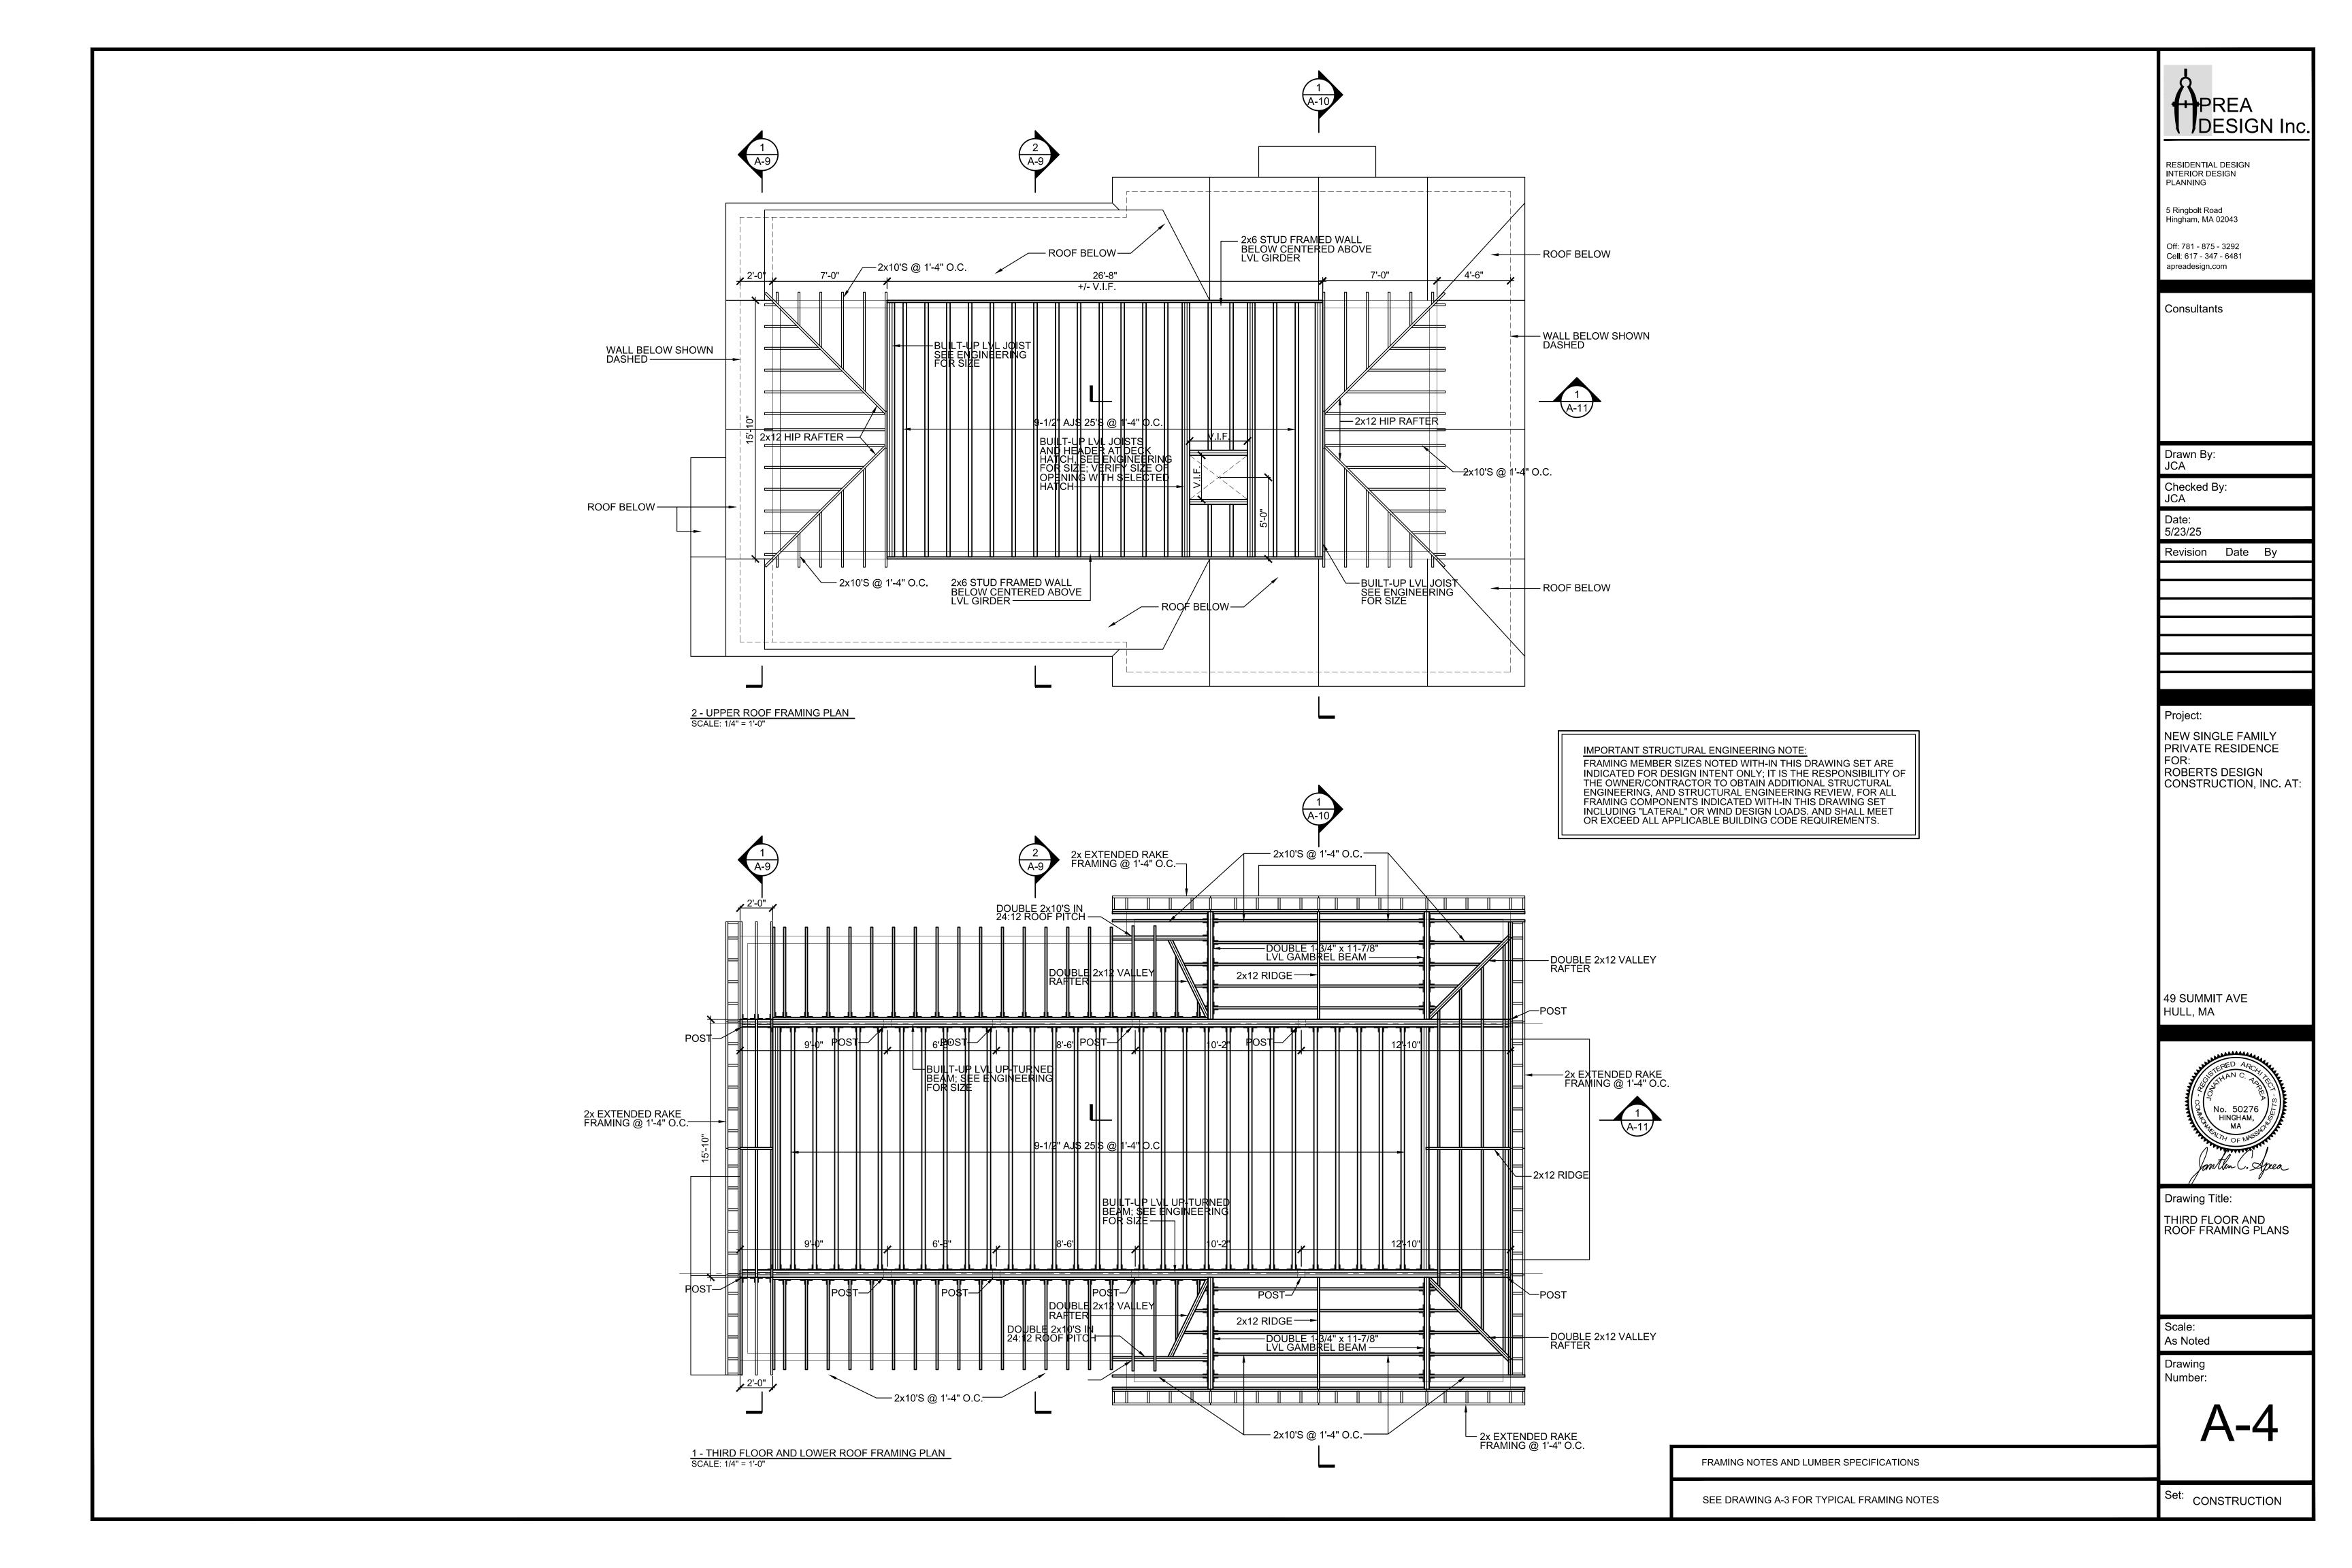

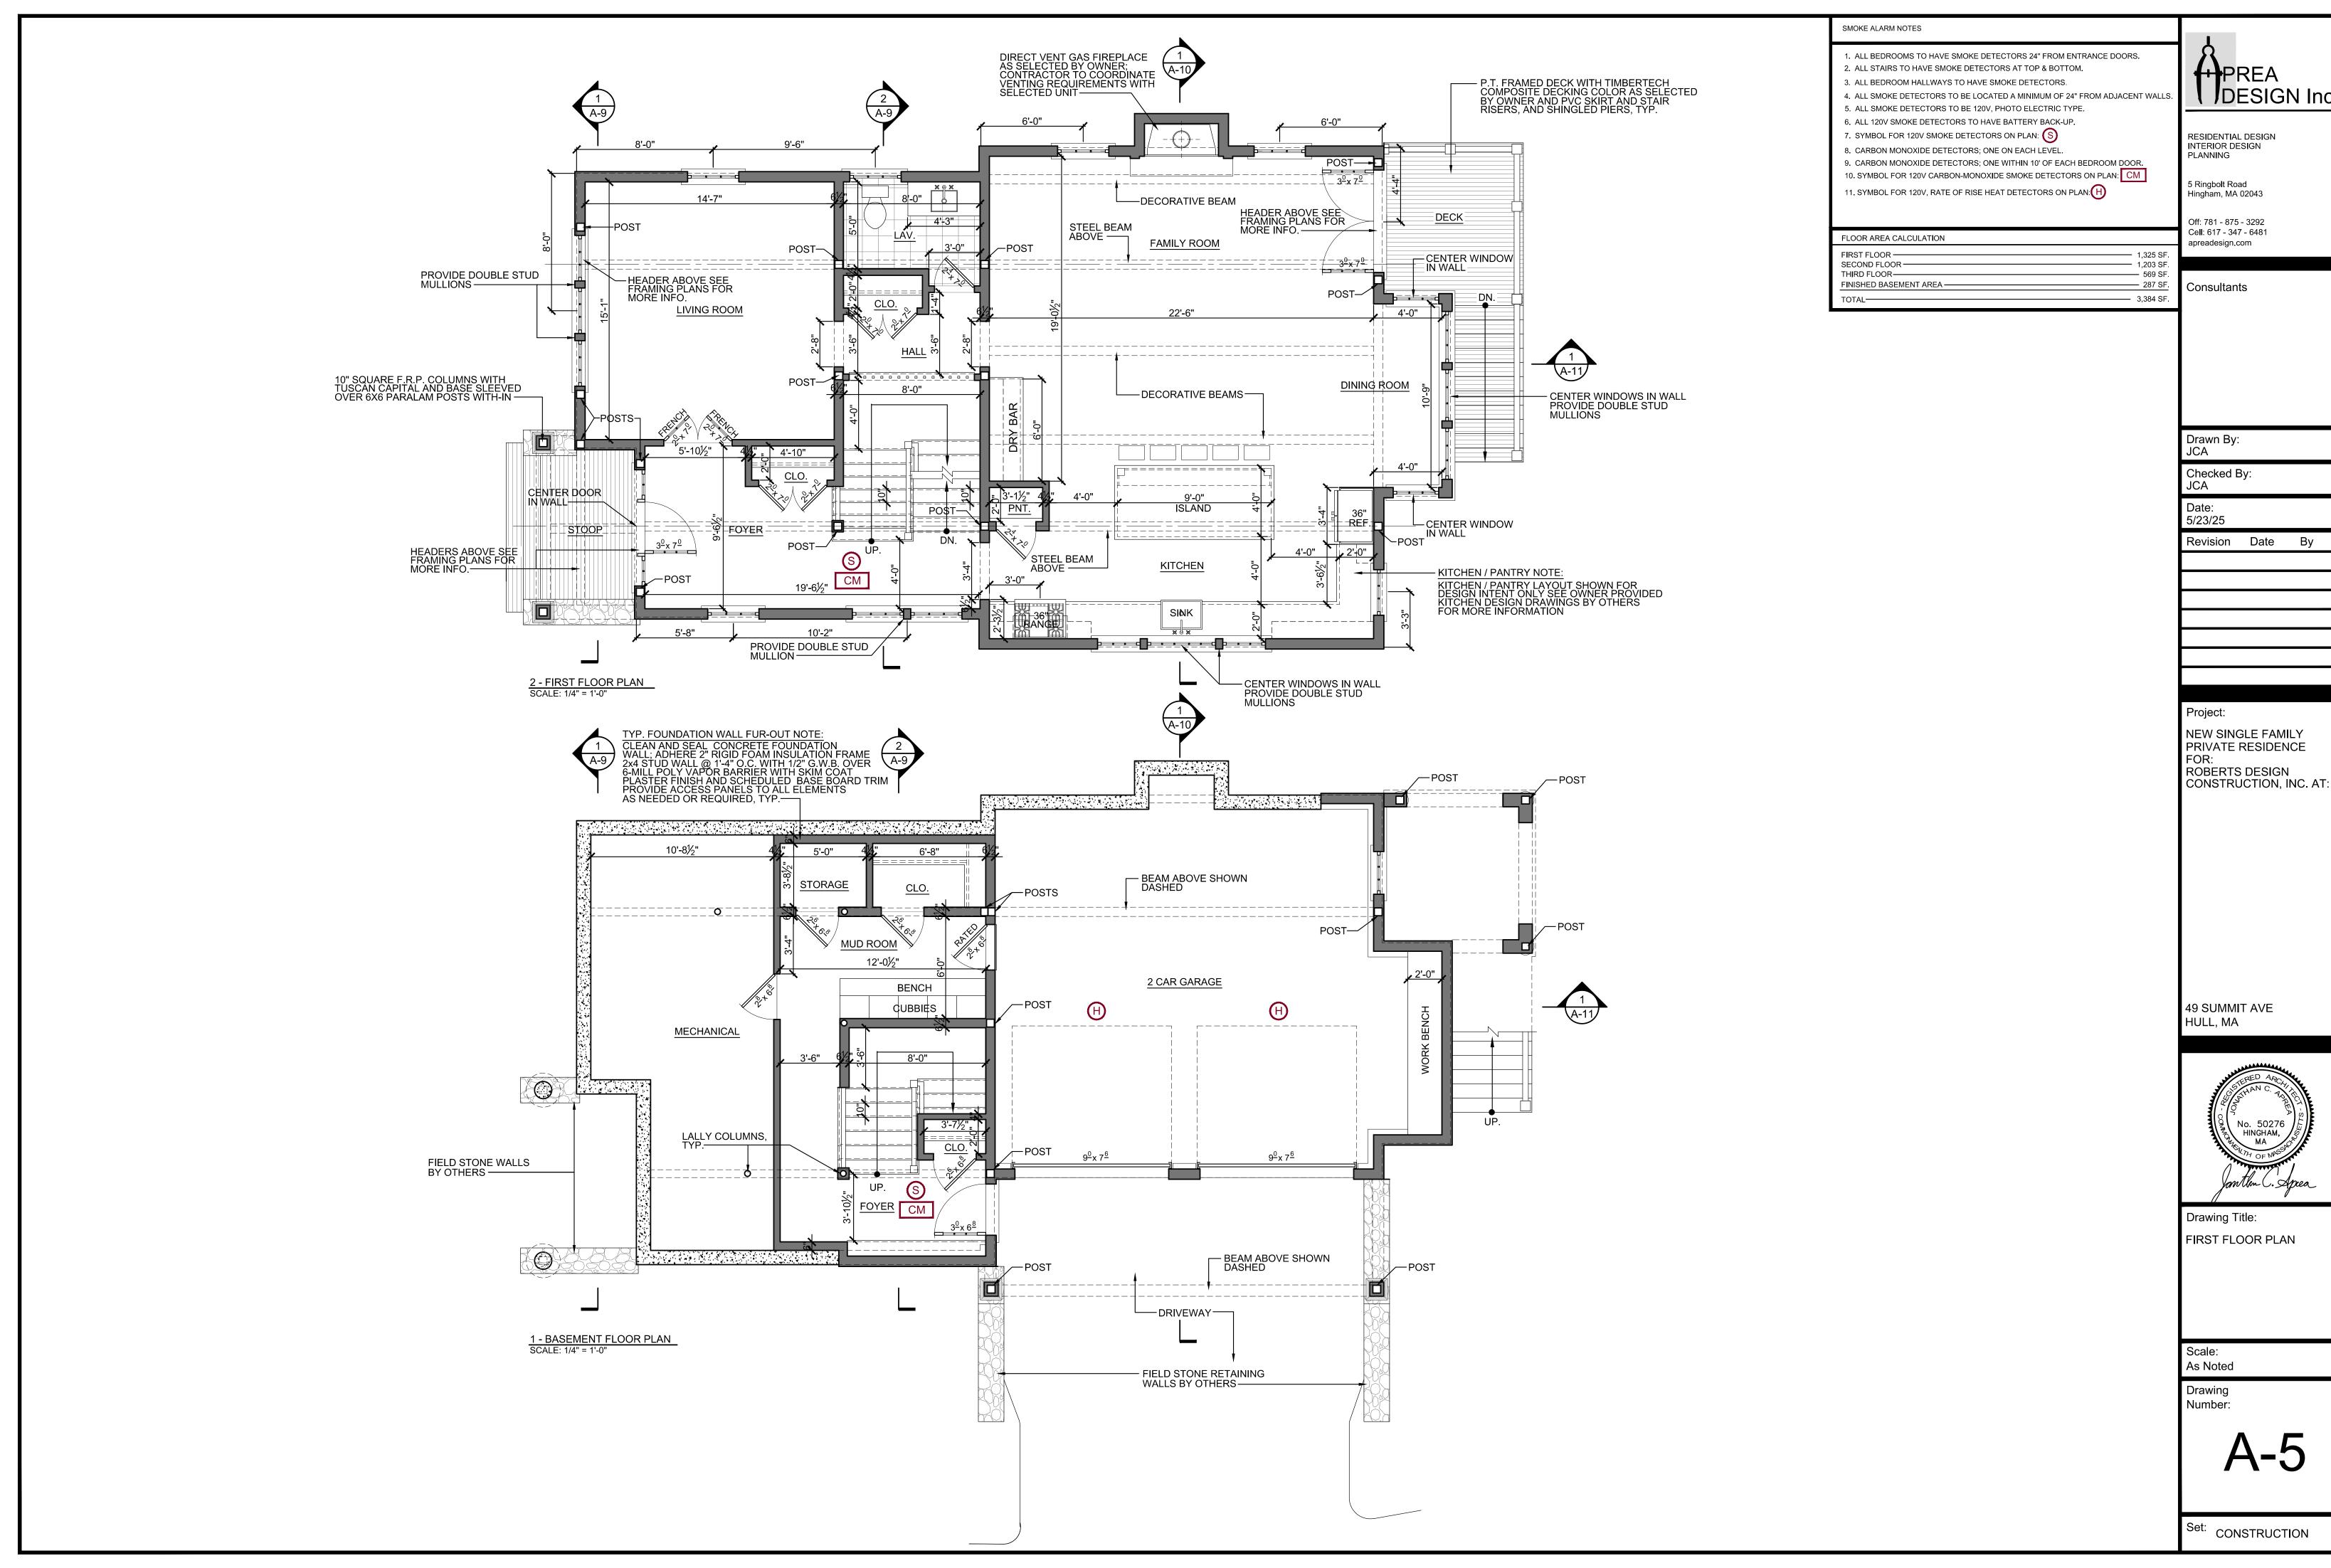

DESIGN Inc.

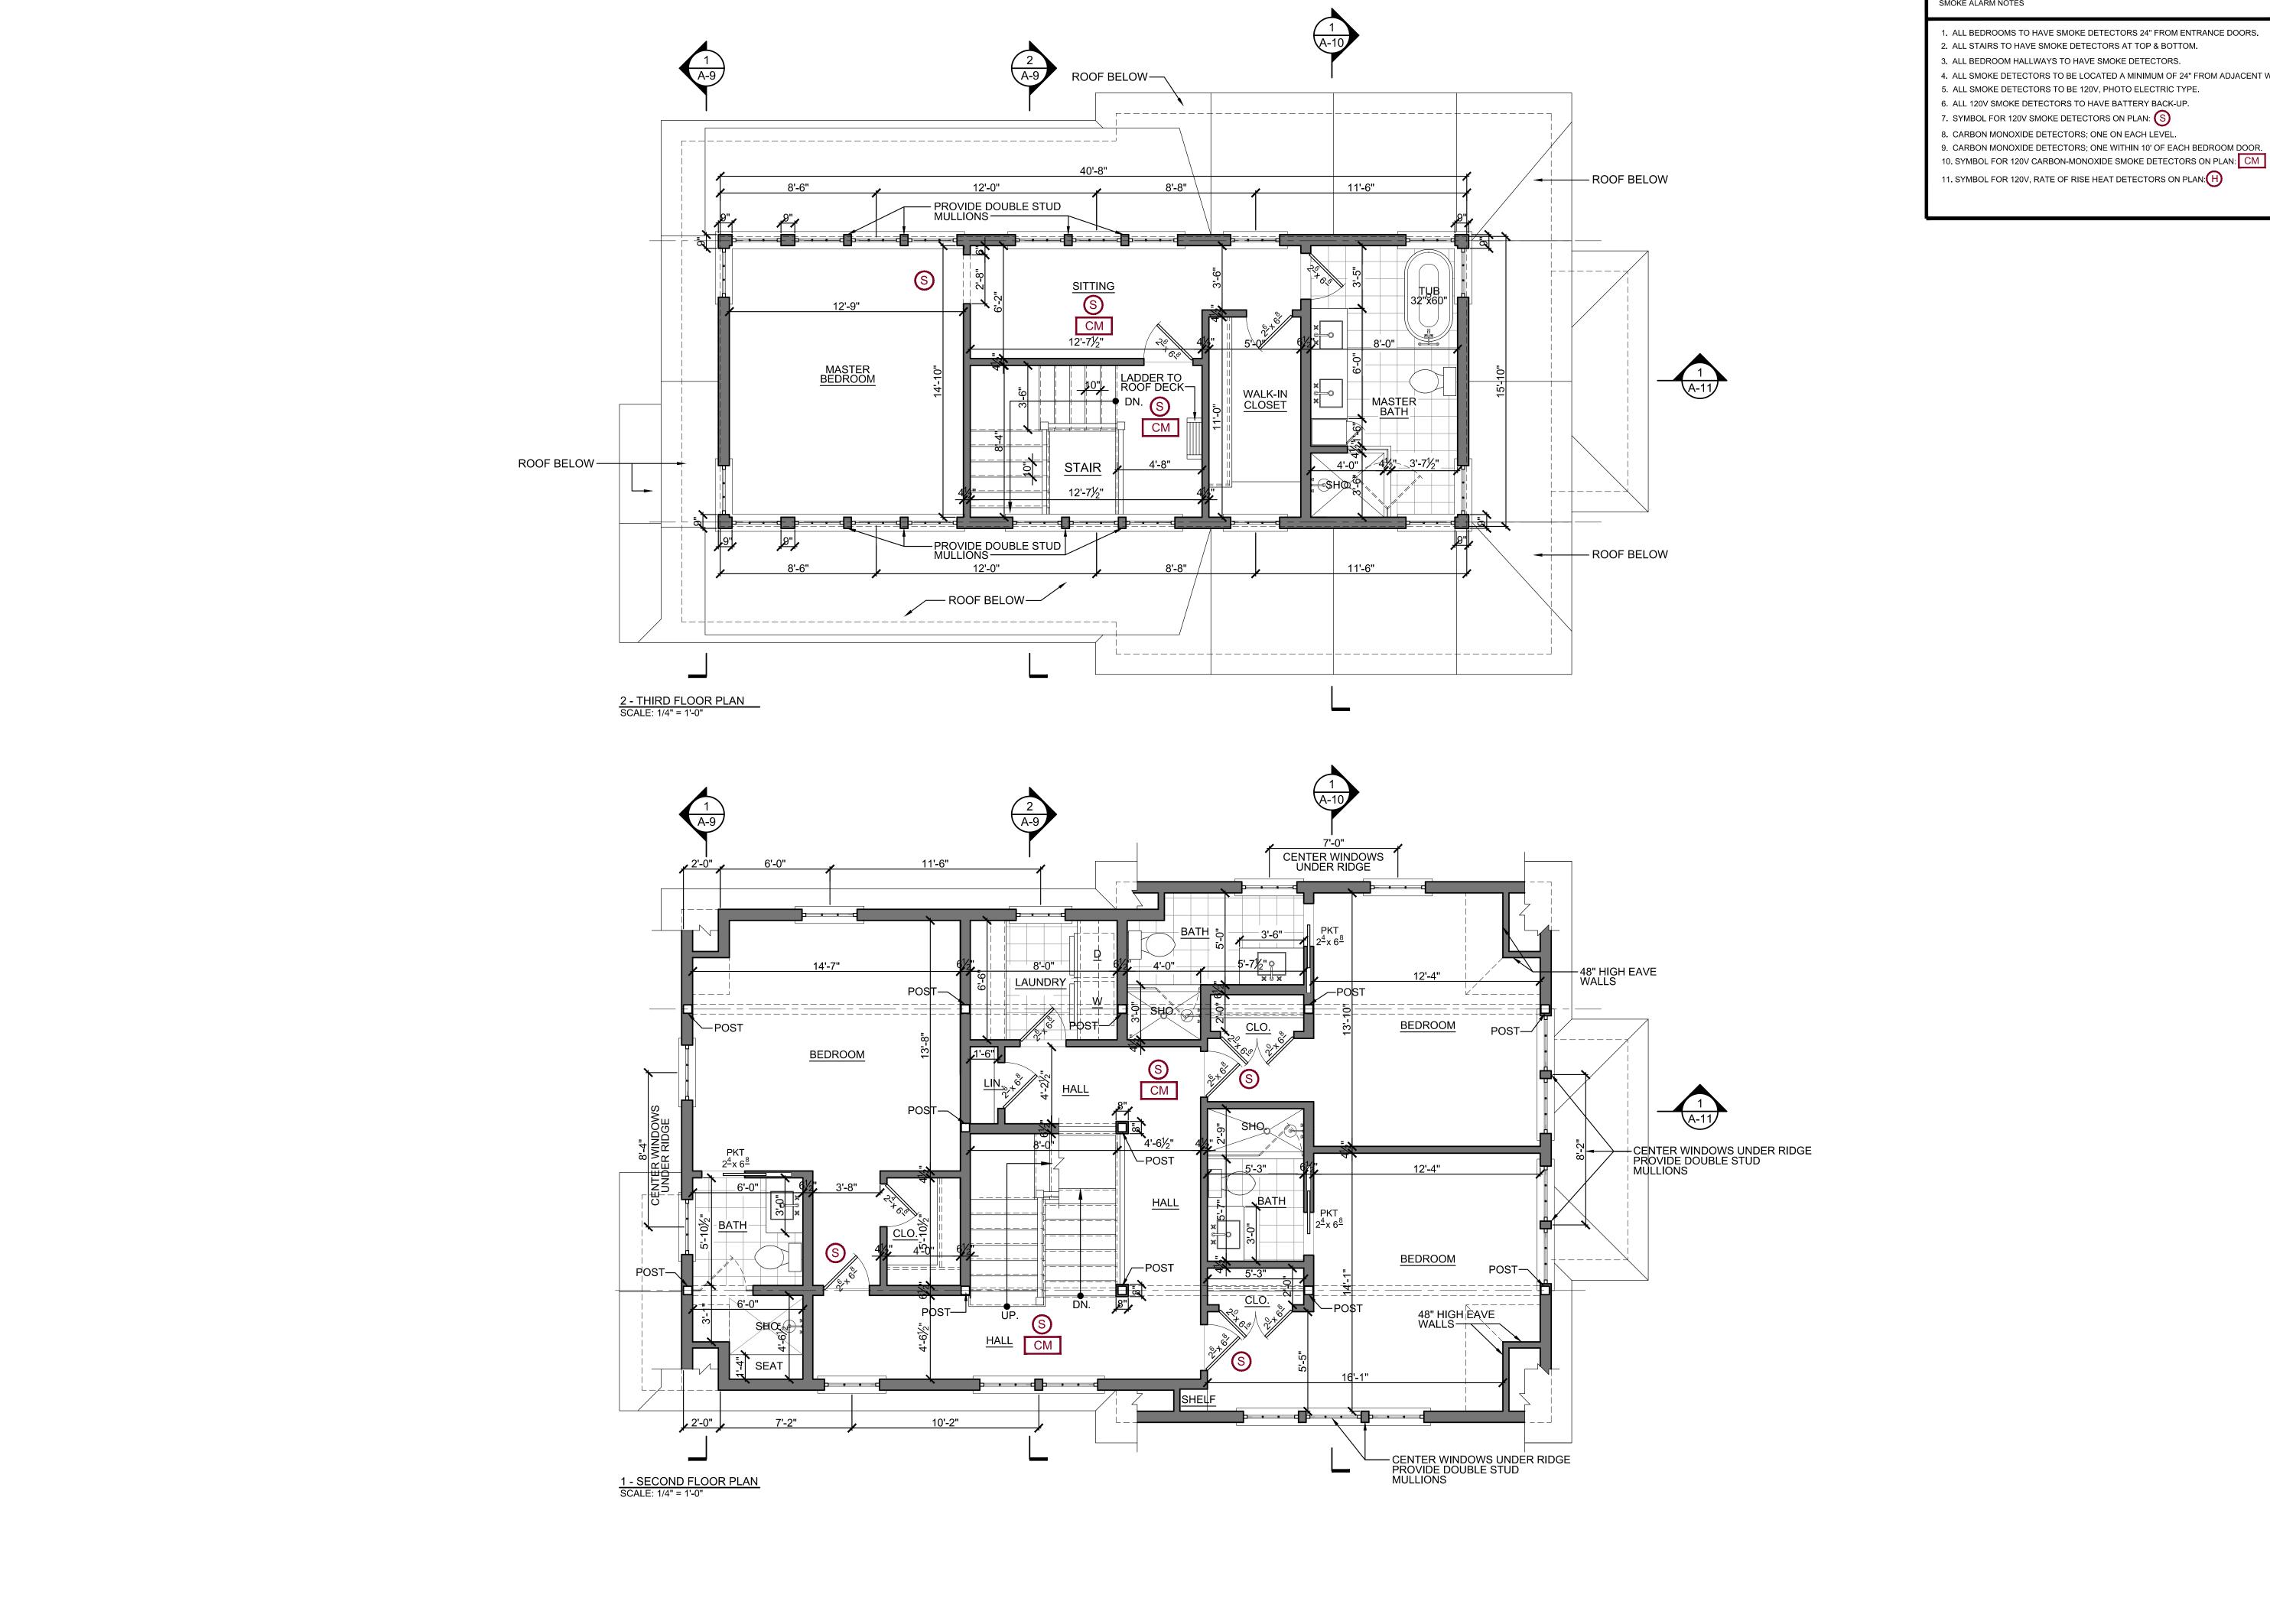

SMOKE ALARM NOTES

- 1. ALL BEDROOMS TO HAVE SMOKE DETECTORS 24" FROM ENTRANCE DOORS.
- 2. ALL STAIRS TO HAVE SMOKE DETECTORS AT TOP & BOTTOM.
- 4. ALL SMOKE DETECTORS TO BE LOCATED A MINIMUM OF 24" FROM ADJACENT WALLS
- 9. CARBON MONOXIDE DETECTORS; ONE WITHIN 10' OF EACH BEDROOM DOOR.



RESIDENTIAL DESIGN INTERIOR DESIGN PLANNING

5 Ringbo**l**t Road Hingham, MA 02043

Off: 781 - 875 - 3292 Cell: 617 - 347 - 6481 apreadesign.com

Consultants

Drawn By:

Checked By:

Date: 5/23/25

Revision Date By

Project:

NEW SINGLE FAMILY PRIVATE RESIDENCE ROBERTS DESIGN CONSTRUCTION, INC. AT:

49 SUMMIT AVE HULL, MA



Drawing Title: SECOND FLOOR PLAN

As Noted

Drawing Number:

Set: CONSTRUCTION

